

38 Dolphin Isle - Addition DESIGN REVIEW SUBMISSION - Revision 1 April 2024

SHEET LIST

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A3.3 **EXTERIOR ELEVATIONS** A4.5 **ENLARGED SECTIONS** A4.6 ENLARGED SECTIONS A6.5 CASEWORK I A6.6 CASEWORK II

CASEWORK III

A6.8 CASEWORK IV A6.9 CASEWORK V A8.0 SECTION DETAILS A9.0 SCHEDULES

A6.7

A9.1 EXTERIOR MATERIALS

PROJECT DATA:

NEW ONE STORY SINGLE-FAMILY RESIDENTIAL ADDITION WITHIN FOOTPRINT OF EXISTING COVERED PATIO. REPLACE FOUNDATION. NEW FRAMING, DOORS & WINDOWS, ROOF, EXTERIOR SIDING AND INTERIOR FINISHES. CONNECT NEW LIGHTING TO EXISTING ELECTRICAL SYSTEM AND RE-LOCATE REGISTERS OF EXISTING MECHANICAL SYSTEM. NO PLUMBING MODIFICATIONS. REPLACE DECK STAIRS AND LANDING AT NEW EXTERIOR PATIO DOOR.

PROJECT ADDRESS:

38 DOLPHIN ISLE NOVATO. CALIFORNIA

157-560-08

ASSESSOR'S PARCEL NUMBER

BFC-RSP-1.6

ZONING DISTRICT

BEL MARIN KEYS CSD

10,523 SQFT AS CALCULATED ~7,500 SQFT LAND AREA

TYPE OF CONSTRUCTION

VB - NON SPRINKLED

EXISTING FLOOR AREA

NET LOT AREA

2,270 SQFT + 520 SQFT GARAGE

PROPOSED FLOOR AREA

+360 SQFT PROPOSED ADDITION 2,630 SQFT + 520 SQFT GARAGE

FLOOR AREA RATIO

2.630 : 10.523 = 25%

EXISTING IMPERVIOUS AREA PROPOSED IMPERVIOUS AREA 3,888 SQFT 3,888 SQFT - NO CHANGE

EXISTING BUILDING HEIGHT PROPOSED BUILDING HEIGHT

+27'-6" - NO CHANGE PROPOSED ADDITION HEIGHT

+15'-2"

AE EL10

+27'-6"

2 INTERIOR PROVIDED PARKING

SETBACKS - EXISTING HOME

23'-0" FRONT REAR 102'-9" 6'-2" **WEST SIDE** 6'-6" **EAST SIDE**

SETBACKS - PROPOSED ADDITION

76'-5" **FRONT** REAR 85'-7" WEST SIDE 8'-8" EAST SIDE 28'-7"

HISTORIC DESIGNATION NONE

FIRE DISTRICT NOVATO FIRE PROTECTION DISTRICT

FLOOD DESIGNATION

NOTE THAT DWELLING FOOTPRINT IS OUTSIDE OF AE ZONE, IN X 0.2% ZONE, SEE SITE PLAN

ADDRESS SPECIFIC LOMC ACCEPTED, PER MARINMAP.ORG GIS VIEWER

CODES:

THIS WORK SHALL BE PERFORMED IN ACCORDANCE WITH APPLICABLE CODE REQUIREMENTS. AND APPLICABLE REQUIREMENTS OF ALL OTHER REGULATORY AGENCIES, INLCUDING, BUT NOT LIMITED TO THE FOLLOWING:

MARIN COUNTRY MUNICIPAL CODE

2022 CALIFORNIA TITLE 24 REGULATIONS (CALIBORNIA BUILDING STANDARDS CODE)

-2022 CALIFORNIA BUILDING STANDARDS ADMINISTRATIVE CODE (PART 1) -2022 CALIFORNIA BUILDING CODE (PART 2, VOLUMES 1 AND 2)

-2022 CALIFORNIA ELECTRICAL CODE (PART 3)

-2022 CALIFORNIA MECHANICAL CODE (PART 4)

-2022 CALIFORNIA PLUMBING CODE (PART 5)

-2022 CALIFORNIA ENERGY CODE (PART 6) -2022 CALIFORNIA FIRE CODE (PART 9)

-2022 CALIFORNIA EXISTING BUILDING CODE (PART 10)

-2022 CALIFORNIA GREEN BUILDING STANDARDS CODE (CALGREEN) (PART 11)

-2022 CALIFORNIA REFERENCE STANDARDS CODE (PART 12)

UNLESS OTHERWISE SPECIFIED, SPECIFIC REFERENCES TO CODES, REGULATION STANDARDS, MANUFACTURER'S INSTRUCTIONS, OR REQUIREMENTS OF REGULATORY AGENCIES, WHEND USED TO SPECIFY REQUIREMENTS FOR MATERIALS OF DESIGN ELEMENTS SHALL MEAN THE LATEST EDITION OF EACH IN EFFECT AT THE DATE OF SUBMISSION OF BIDS, OR THE DATE OF THE CHANGE ORDER OF FIELD ORDER, AS APPLICABLE. THE INTENT OF THE DRAWINGS AND SPECIFICATIONS IS TO BE IN ACCORDANCE WITH TITLE 24, CALIFORNIA CODE REGULATIONS.

VICINITY MAP:




ABREVIATIONS:


/ IDI IL V	////10140.		
ACT	ACOUSTIC CEILING TILE	HR	HOUR
AD	AREA DRAIN	HVAC	HEATING, VENTILATING, AND AIR
AFF	ABOVE FINISHED FLOOR		CONDITIONING
ANG	ABOVE NATURAL GRADE	IRGWB	IMPACT RESISTANT GYPSUM WALL
ALUM	ALUMINUM		BOARD
ANOD	ANODIZED	ILO	IN LIEU OF
BSMT	BASEMENT	INSUL	INSULATED OR INSULATION
BYND	BEYOND	INT	INTERIOR
ВОТ	BOTTOM	LO	LOW
CIP	CAST IN PLACE	MAX	MAXIMUM
CHNL	CHANNEL	MO	MASONRY OPENING
CJ	CONTROL JOINT	MECH	MECHANICAL
CL	CENTER LINE	MEMBR	MEMBRANE
CLG	CEILING	MIN	MINIMUM
CLR	CLEAR	MRGWB	MOISTURE-RESISTANT GYPSUM
CMU	CONCRETE MASONRY UNIT		WALL BOARD
COL	COLUMN	MTL	METAL
COMPR	COMPRESSIBLE	NIC	NOT IN CONTRACT
CONC	CONCRETE	NO	NUMBER
CONT	CONTINUOUS	NOM	NOMINAL
CPT	CARPET	OC	ON CENTER
CT	CERAMIC TILE	OH	OVERHANG OR OPPOSITE HAND
CTYD	COURTYARD	OPP	OPPOSITE OR OPPOSITE HAND
DBL	DOUBLE	OZ	OUNCE
DEMO	DEMOLISH OR DEMOLITION	PCC	PRE-CAST CONCRETE
DIA	DIAMETER	PLUMB	PLUMBING
DIM	DIMENSION	PWD	PLYWOOD
DIMS	DIMENSIONS	PT	PRESSURE TREATED
DN	DOWN	PNT	PAINT OR PAINTED
DR	DOOR	PVC	POLYVINYL CHLORIDE
DWG	DRAWING	RBR	RUBBER
EA	EACH	RCP	REFLECTED CEILING PLAN
EJ	EXPANSION JOINT	RD	ROOF DRAIN
EL	ELEVATION	REQD	REQUIRED
ELEC	ELECTRICAL	RM	ROOM
ELEV	ELEVATOR OR ELEVATION	SIM SD	SIMILAR
EPDM	ETHYLENE PROPYLENE		SMOKE DETECTOR
F0	DIENE M-CLASS (ROOFING)	SPEC SPK	SPECIFIED OR SPECIFICATION SPRINKLER OR SPEAKER
EQ EXIST	EQUAL EXISTING	SSTL	STAINLES STEEL
EXP JT	EXPANSION JOINT	STC	SOUND TRANSMISSION
EXF J1	EXTERIOR	310	COEFFICIENT
FD	FLOOR DRAIN OR FIRE	STL	STEEL
	DEPARTMENT	STRUCT	
FEC	FIRE EXTINGUISHER CABINET	T&G	TONGUE AND GROOVE
FF	FINISHED FACE OR FINISHED	TELE	TELEPHONE
	FLOOR	TLT	TOILET
FFL	FINISHED FLOOR LEVEL	TME	TO MATCH EXISTING
FIXT	FIXTURE	TO	TOP OF
FLR	FLOOR	TOC	TOP OF CONCRETE
FM	FILLED METAL	TOS	TOP OF STEEL
FO	FACE OF	TPD	TOILET PAPER DISPENSER
FND	FOUNDATION	T/D	TELEPHONE/DATA
GA	GAUGE	TYP	TYPICAL
GALV	GALVANIZED	UNO	UNLESS NOTED OTHERWISE
GWB	GYPSUM WALL BOARD	U/S	UNDERSIDE
HC	HOLLOW CORE	VIF	VERIFY IN FIELD
HI	HIGH	VP	VISION PANEL
HM	HOLLOW METAL	W/	WITH
HP	HIGH POINT	WD	WOOD




pam@thecuriouscompany.com

1/31/2024

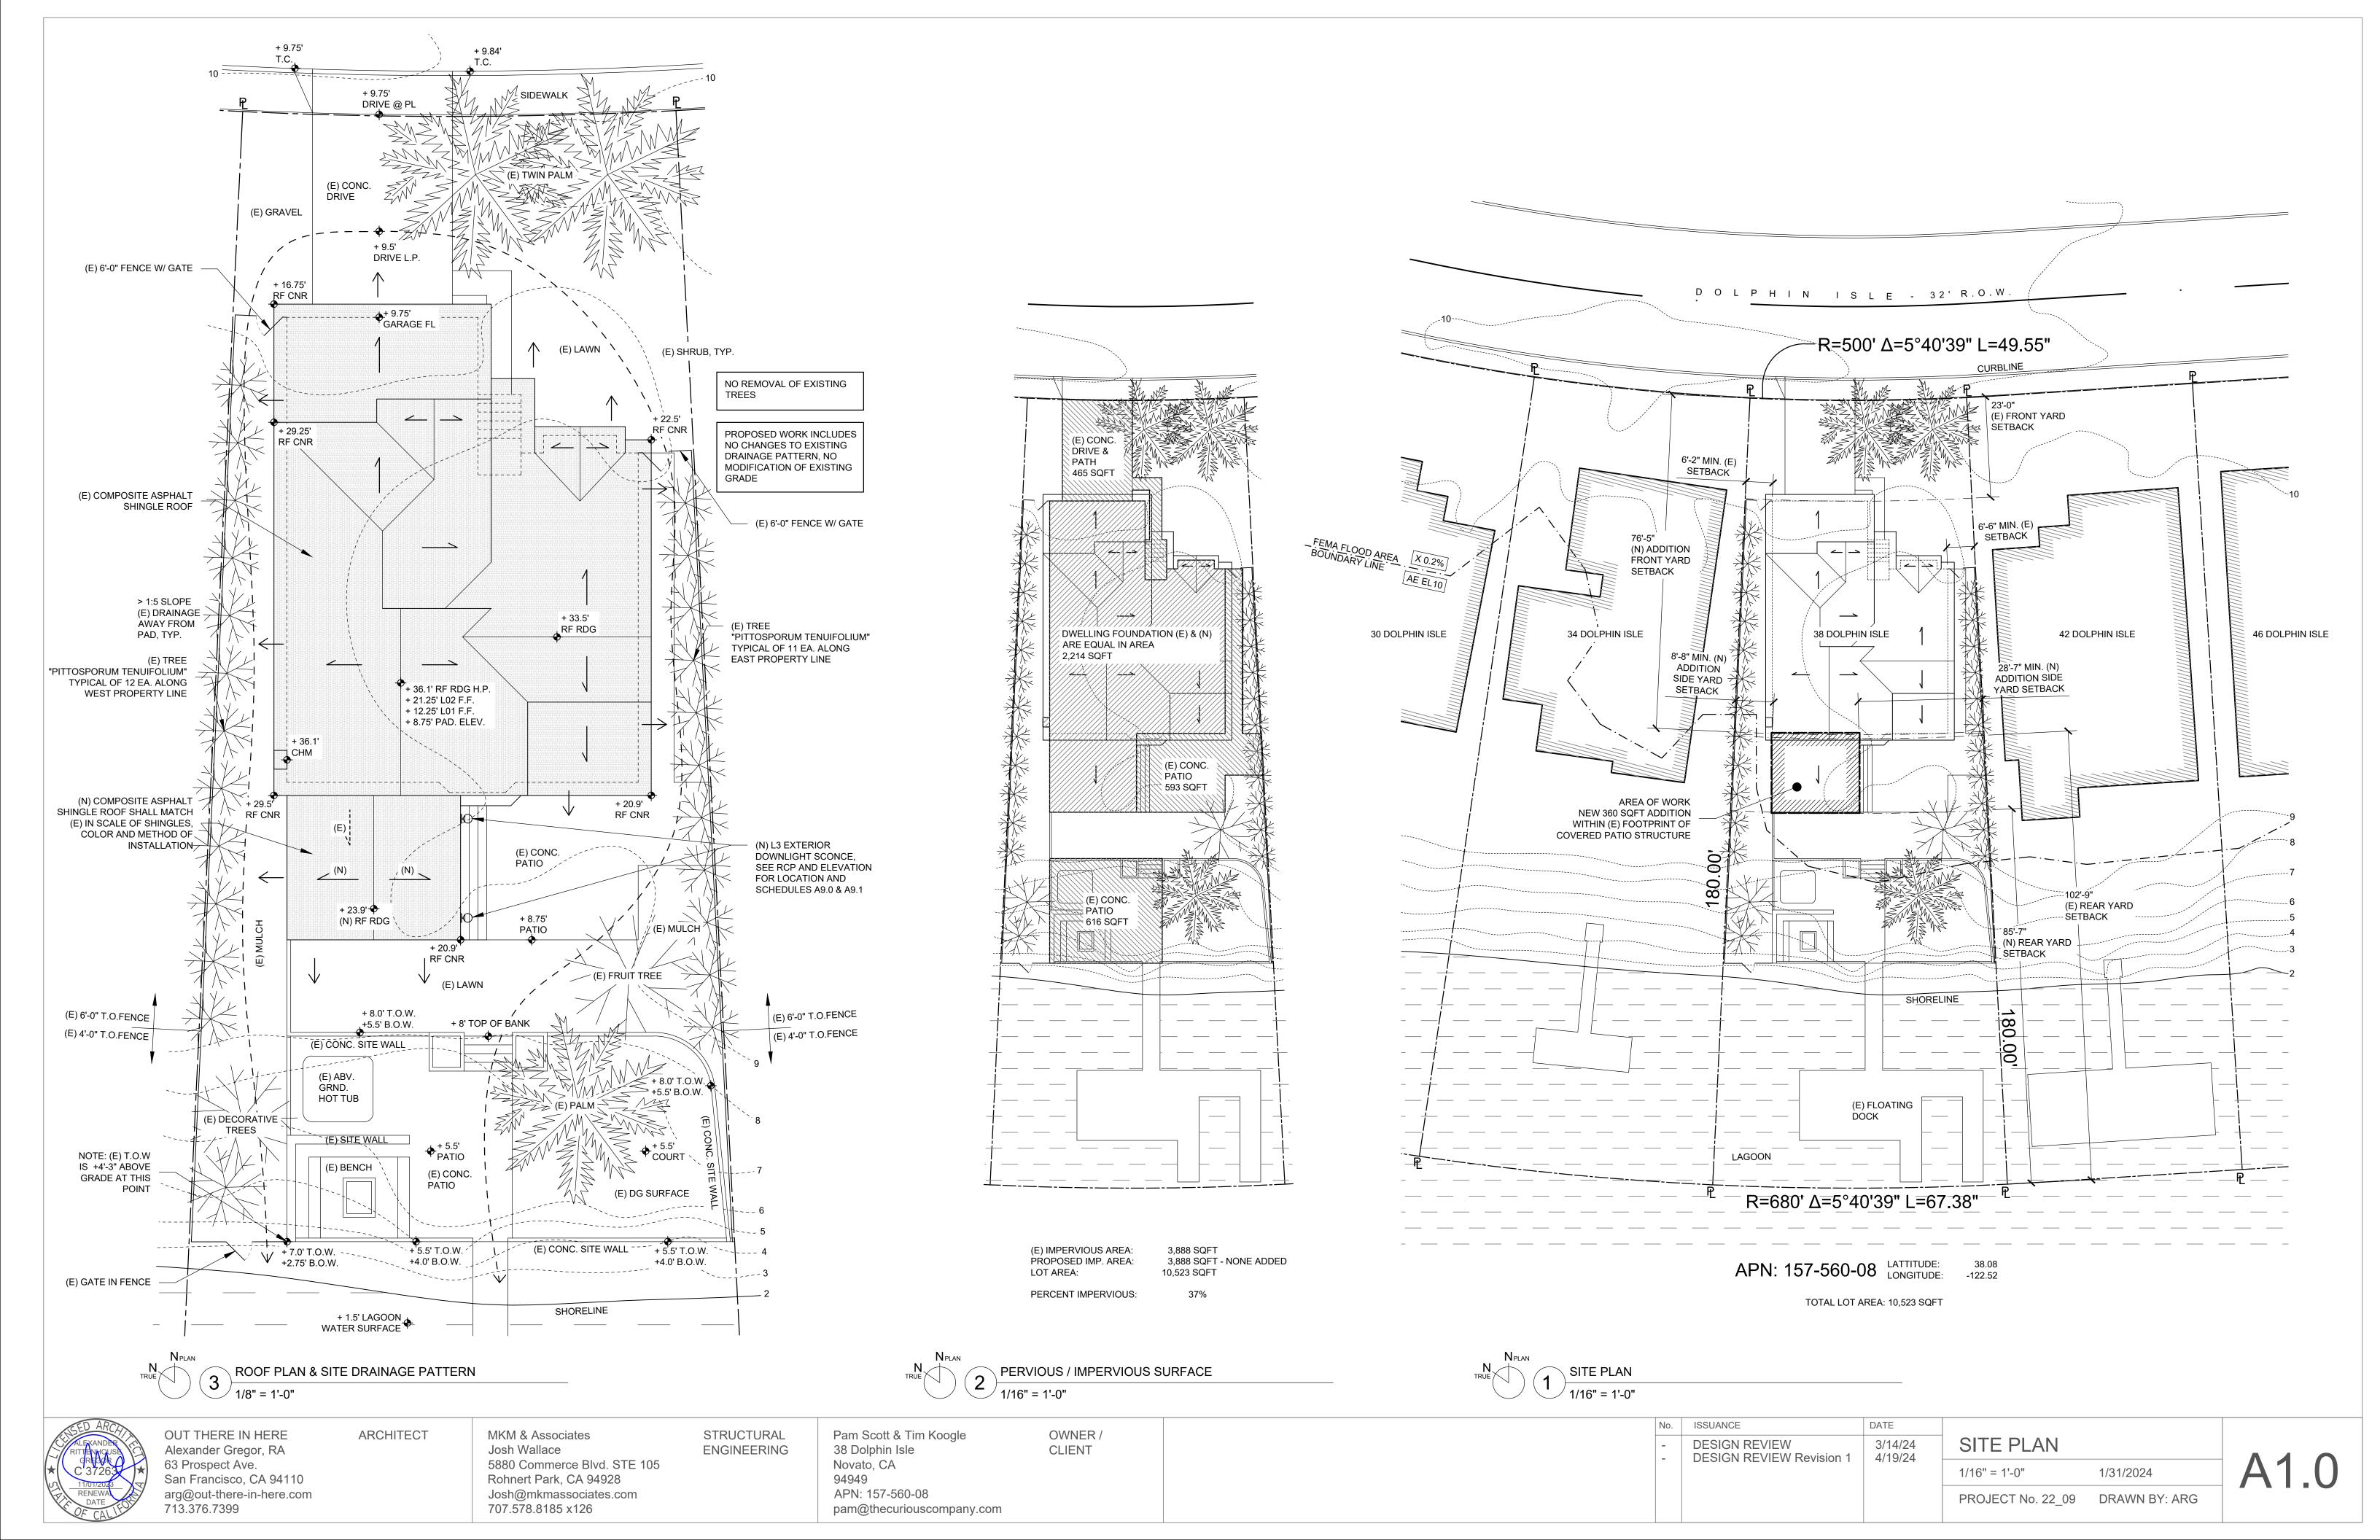

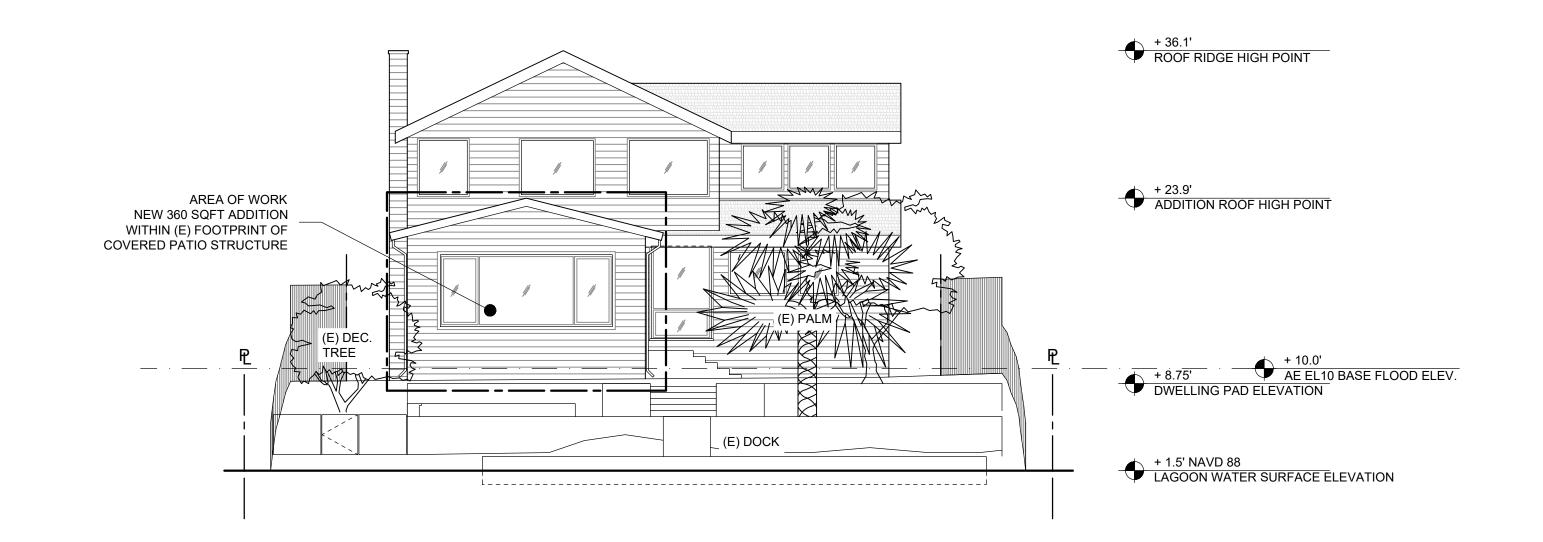

SITE SECTION - FACING NORTH

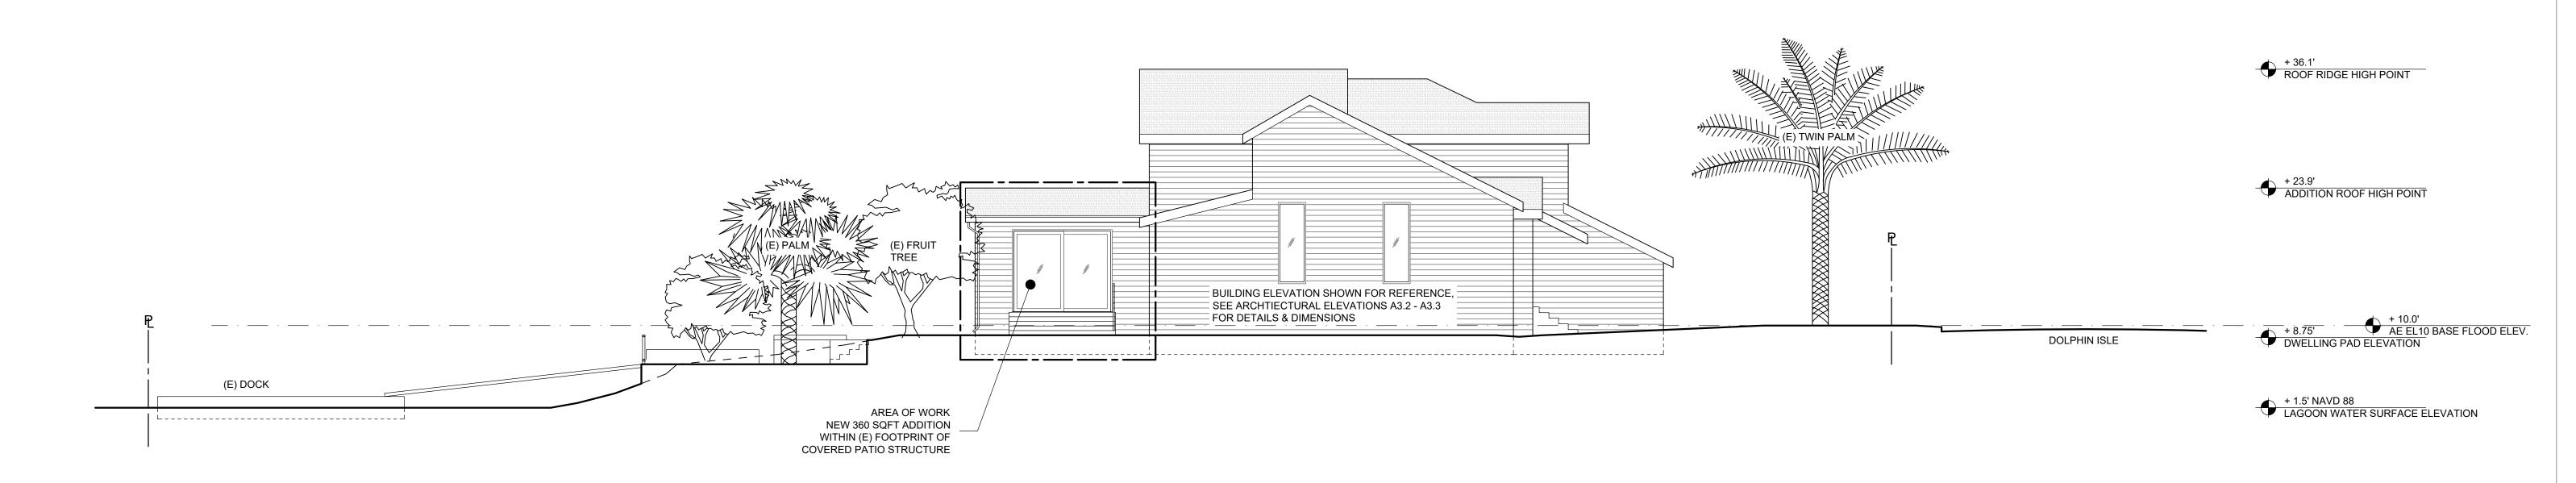

SITE SECTION - FACING WEST

OUT THERE IN HERE Alexander Gregor, RA 63 Prospect Ave. San Francisco, CA 94110 arg@out-there-in-here.com 713.376.7399 ARCHITECT

MKM & Associates Josh Wallace 5880 Commerce Blvd. STE 105 Rohnert Park, CA 94928 Josh@mkmassociates.com 707.578.8185 x126


STRUCTURAL **ENGINEERING** Pam Scott & Tim Koogle 38 Dolphin Isle Novato, CA 94949 APN: 157-560-08 pam@thecuriouscompany.com


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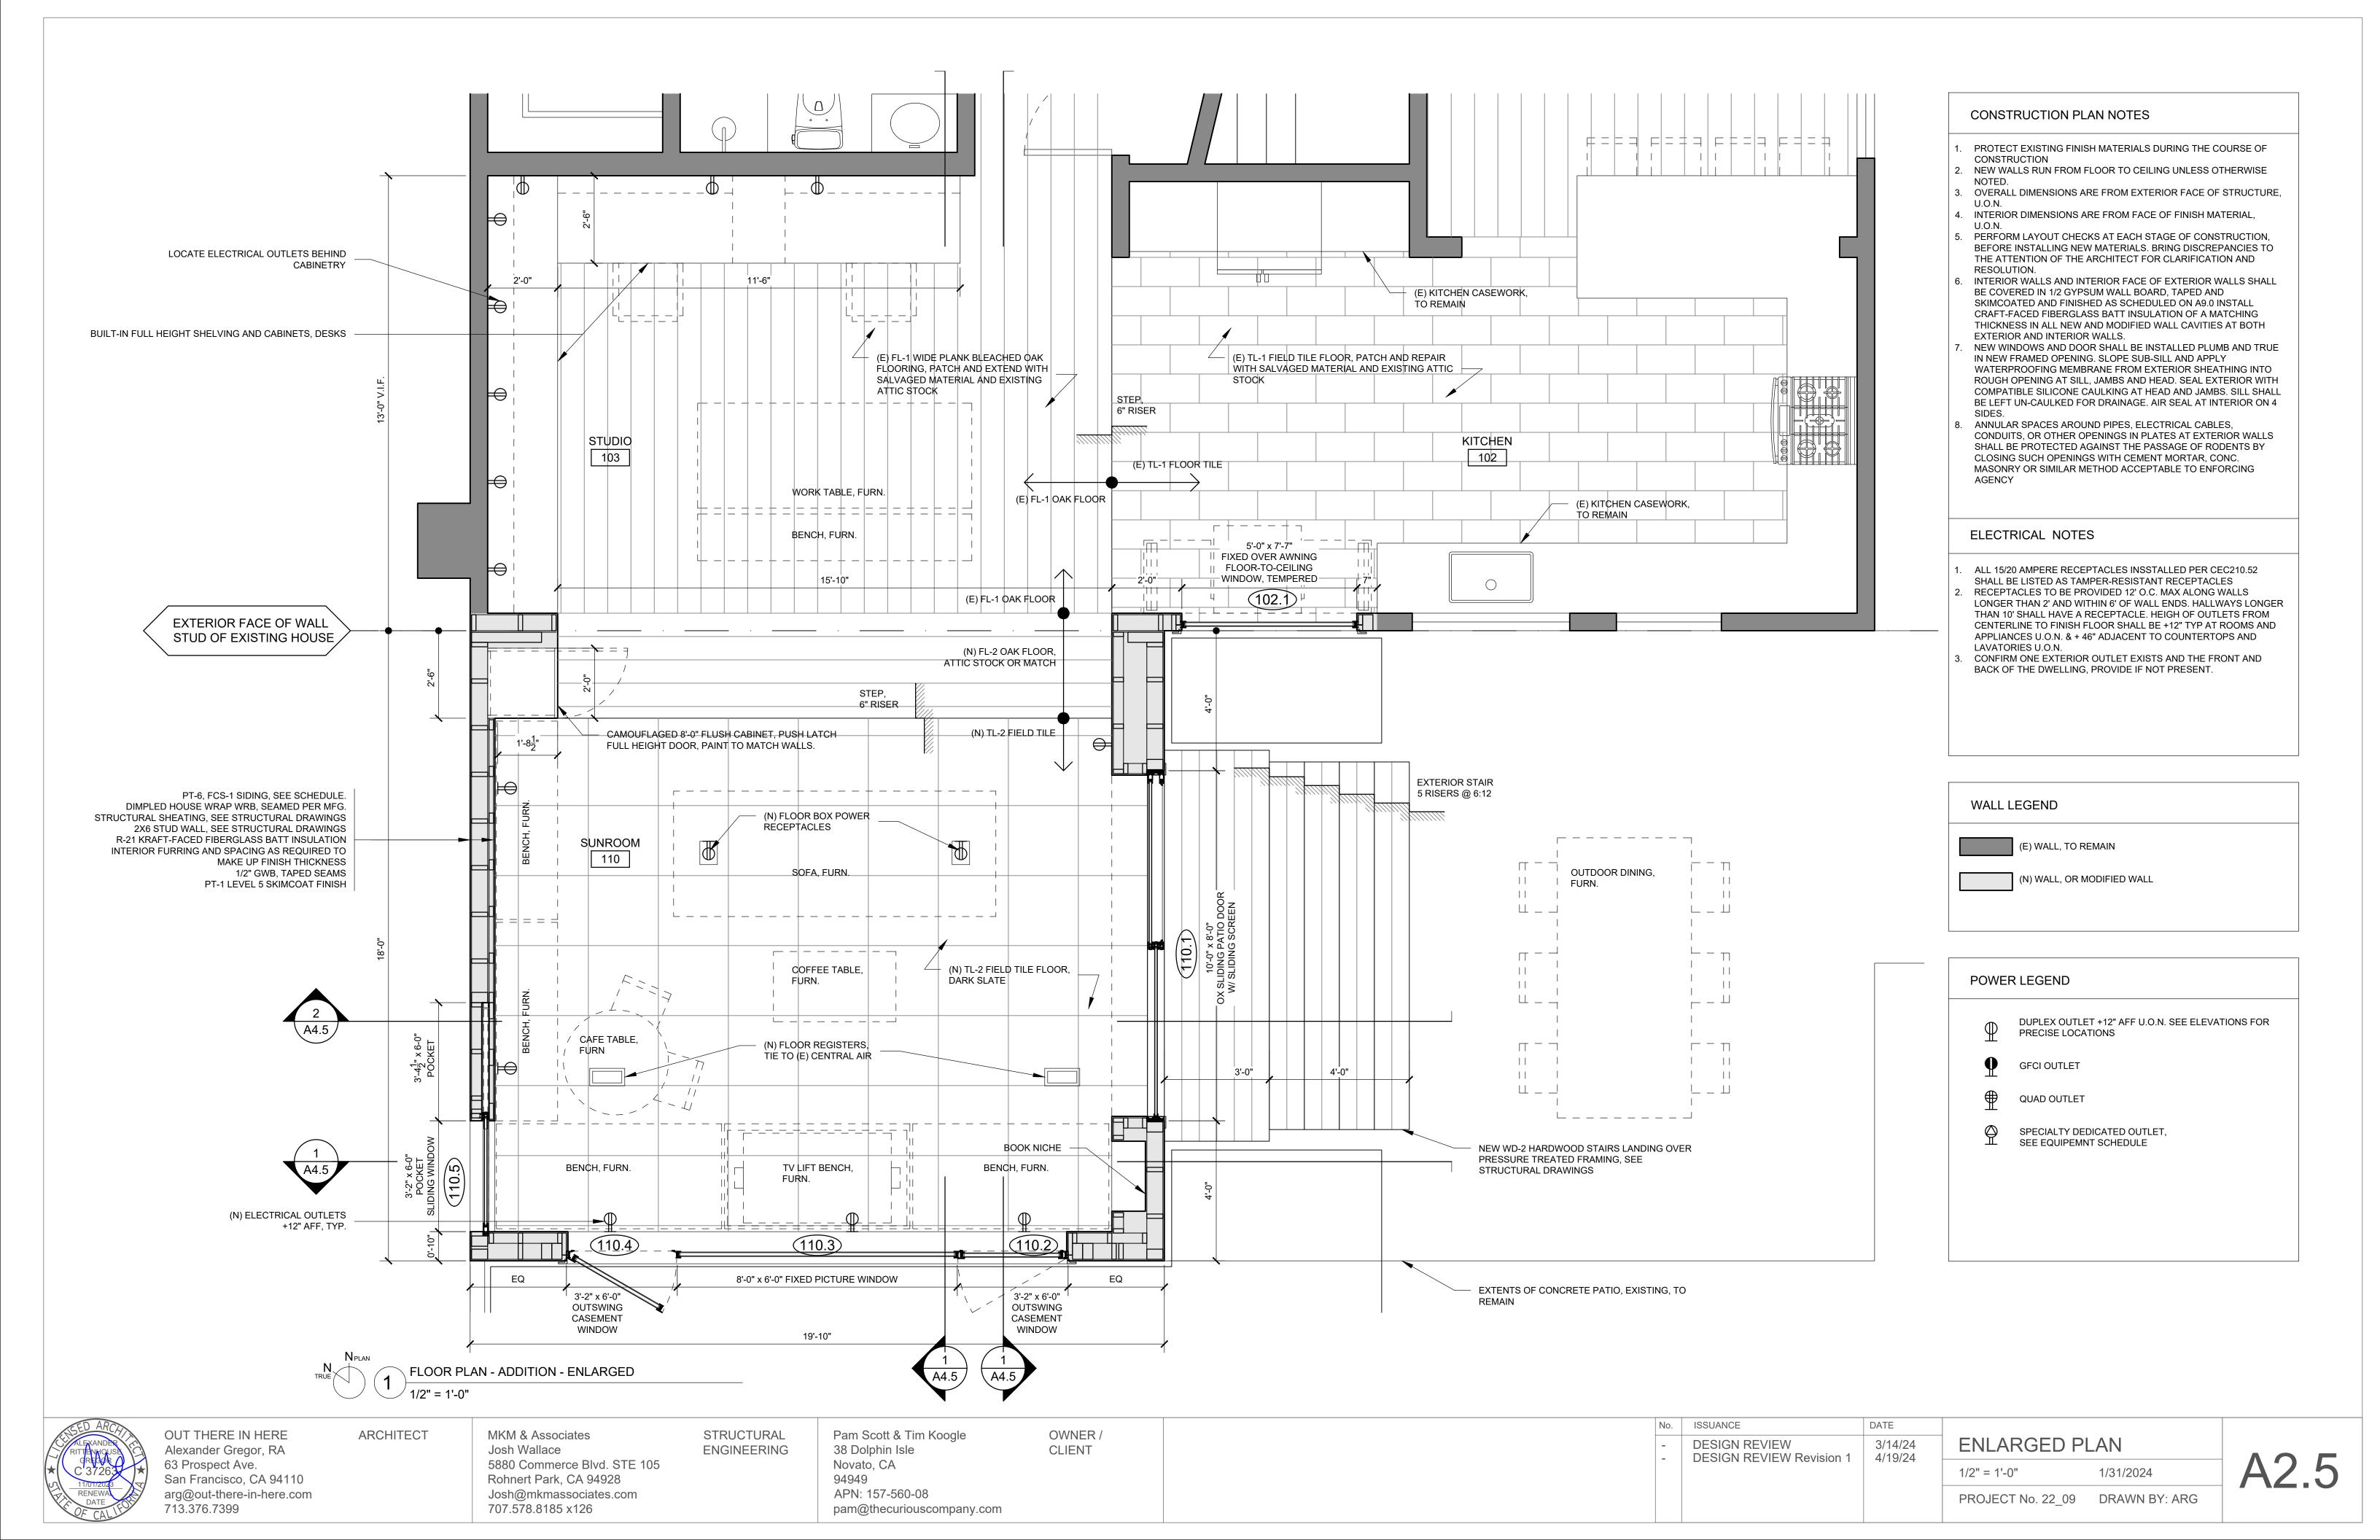
No. ISSUANCE DESIGN REVIEW **DESIGN REVIEW Revision 1**


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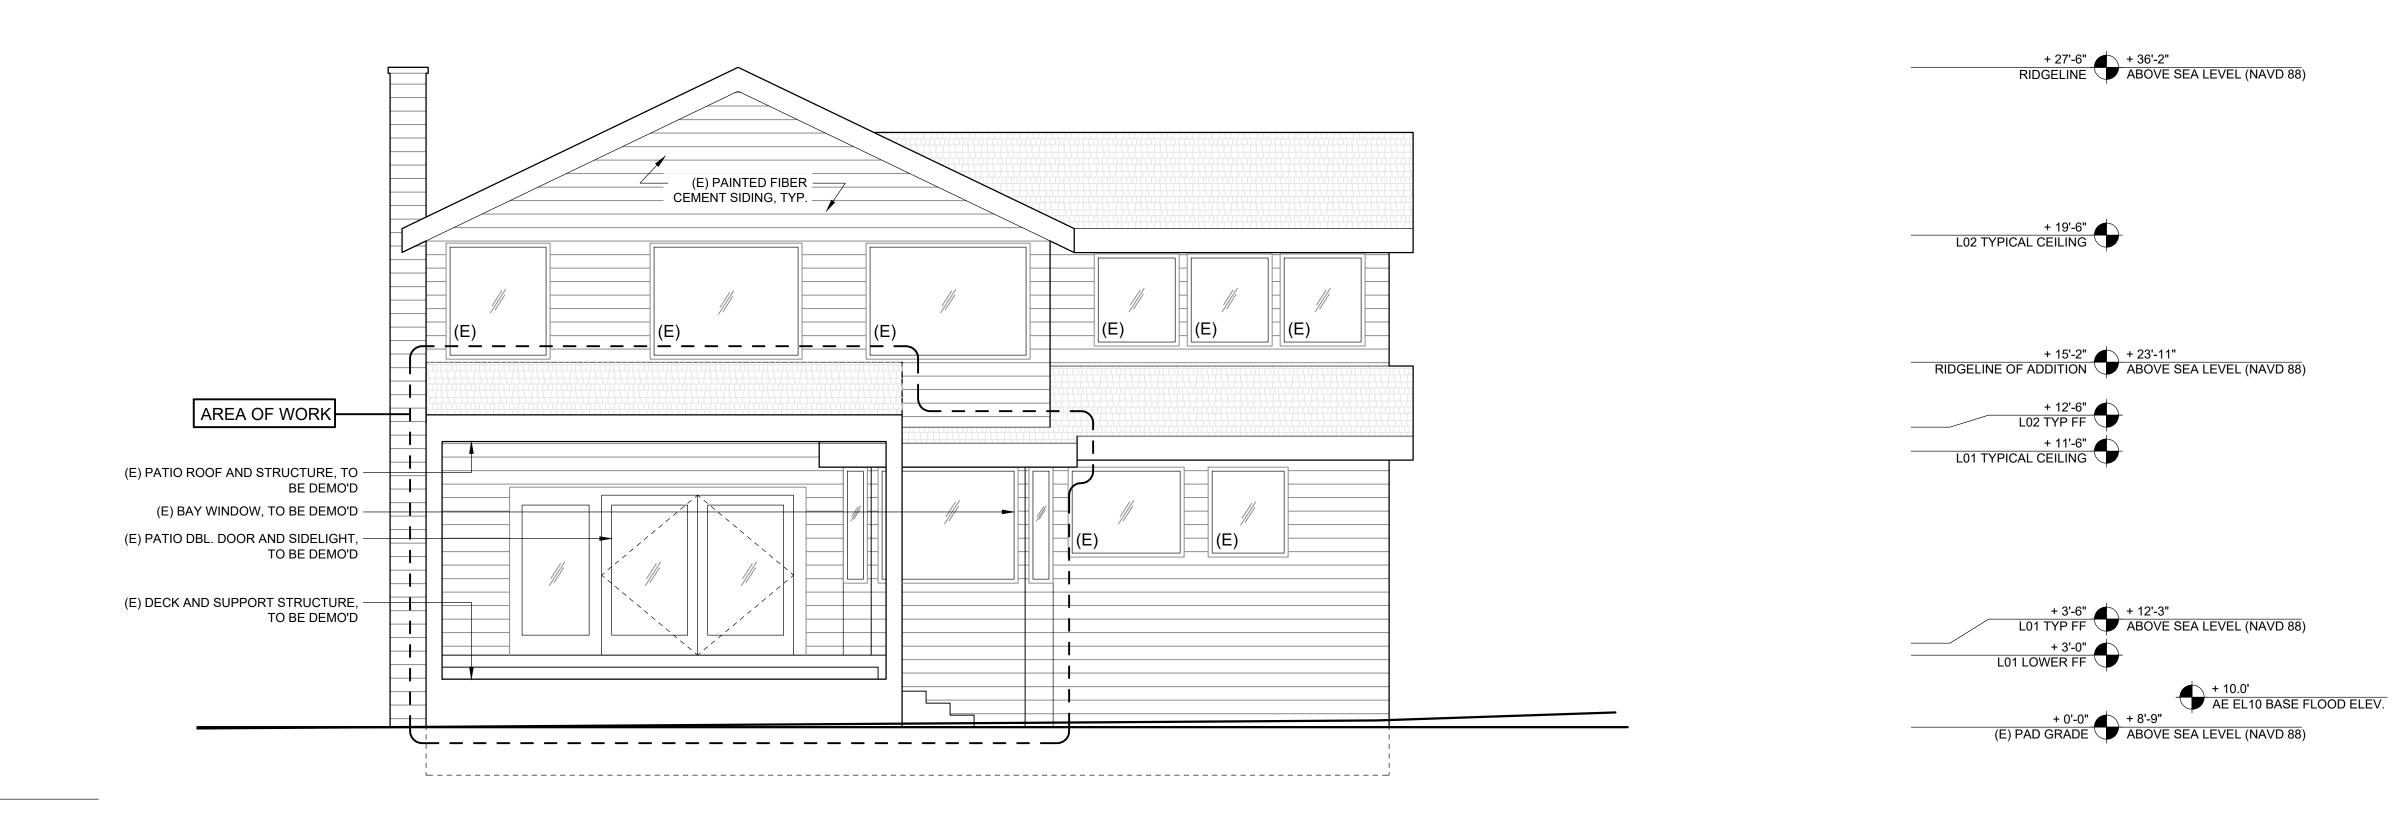
SITE SECTIONS 1/31/2024 1/8" = 1'-0"





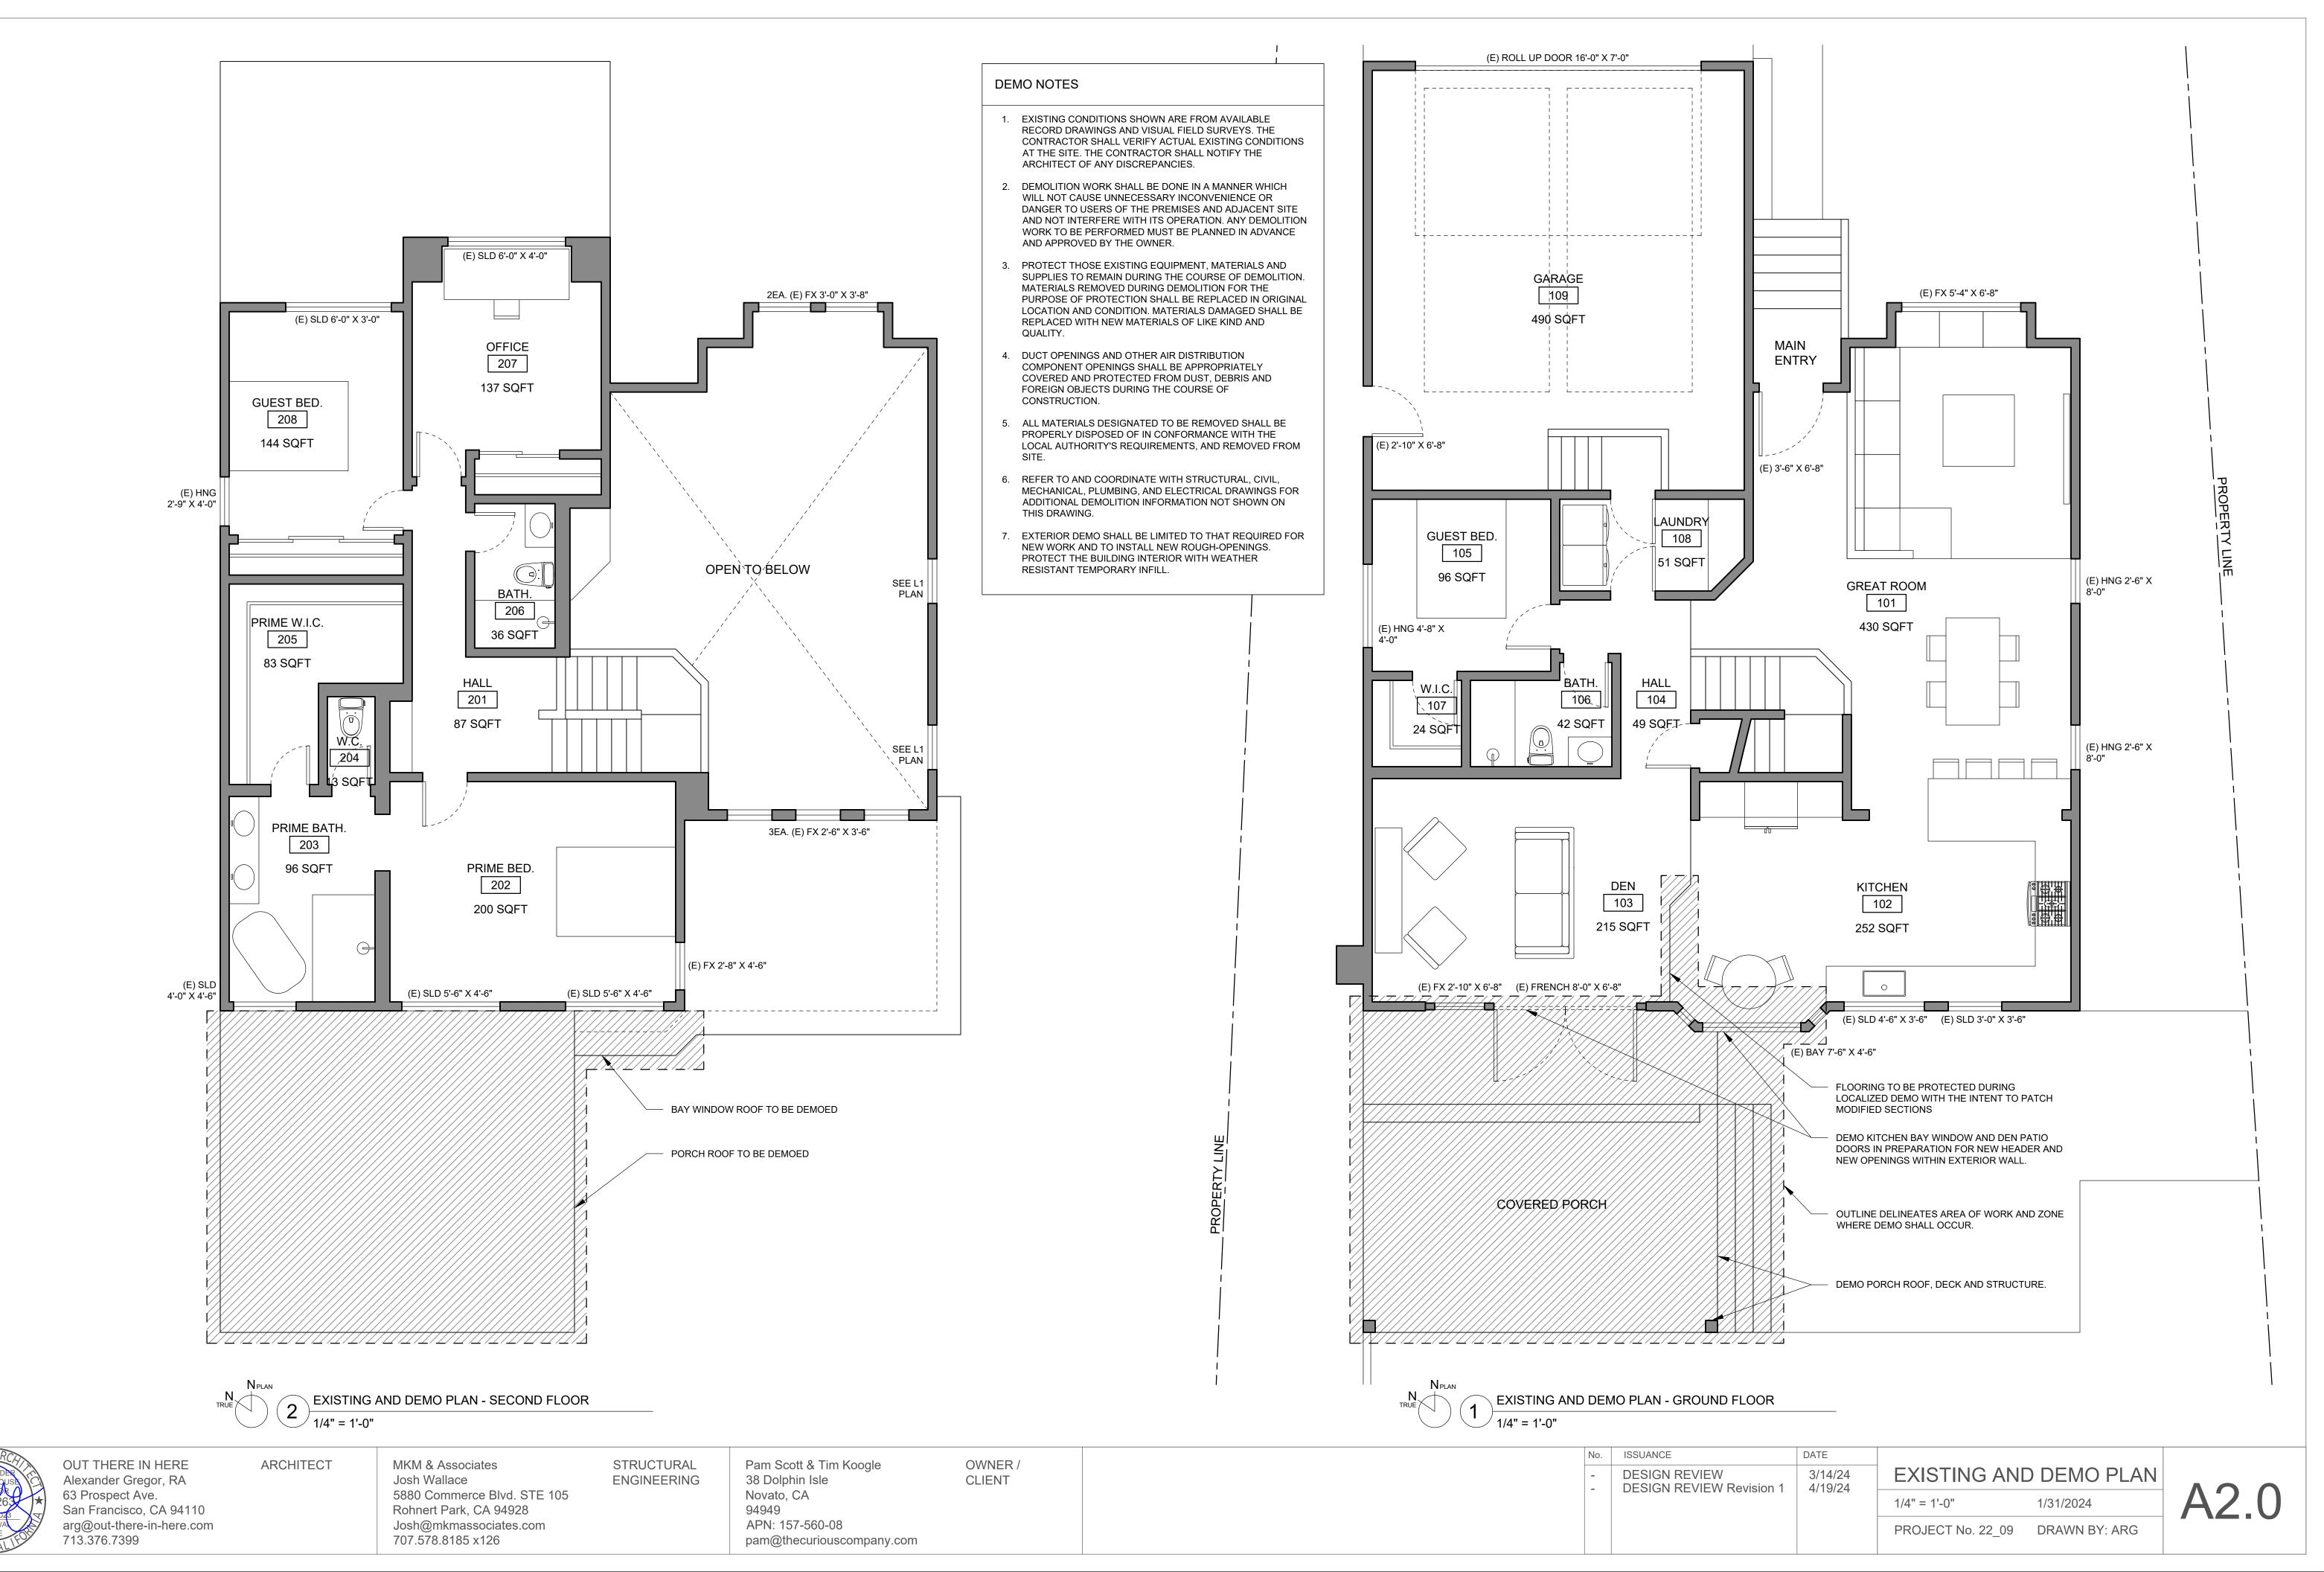

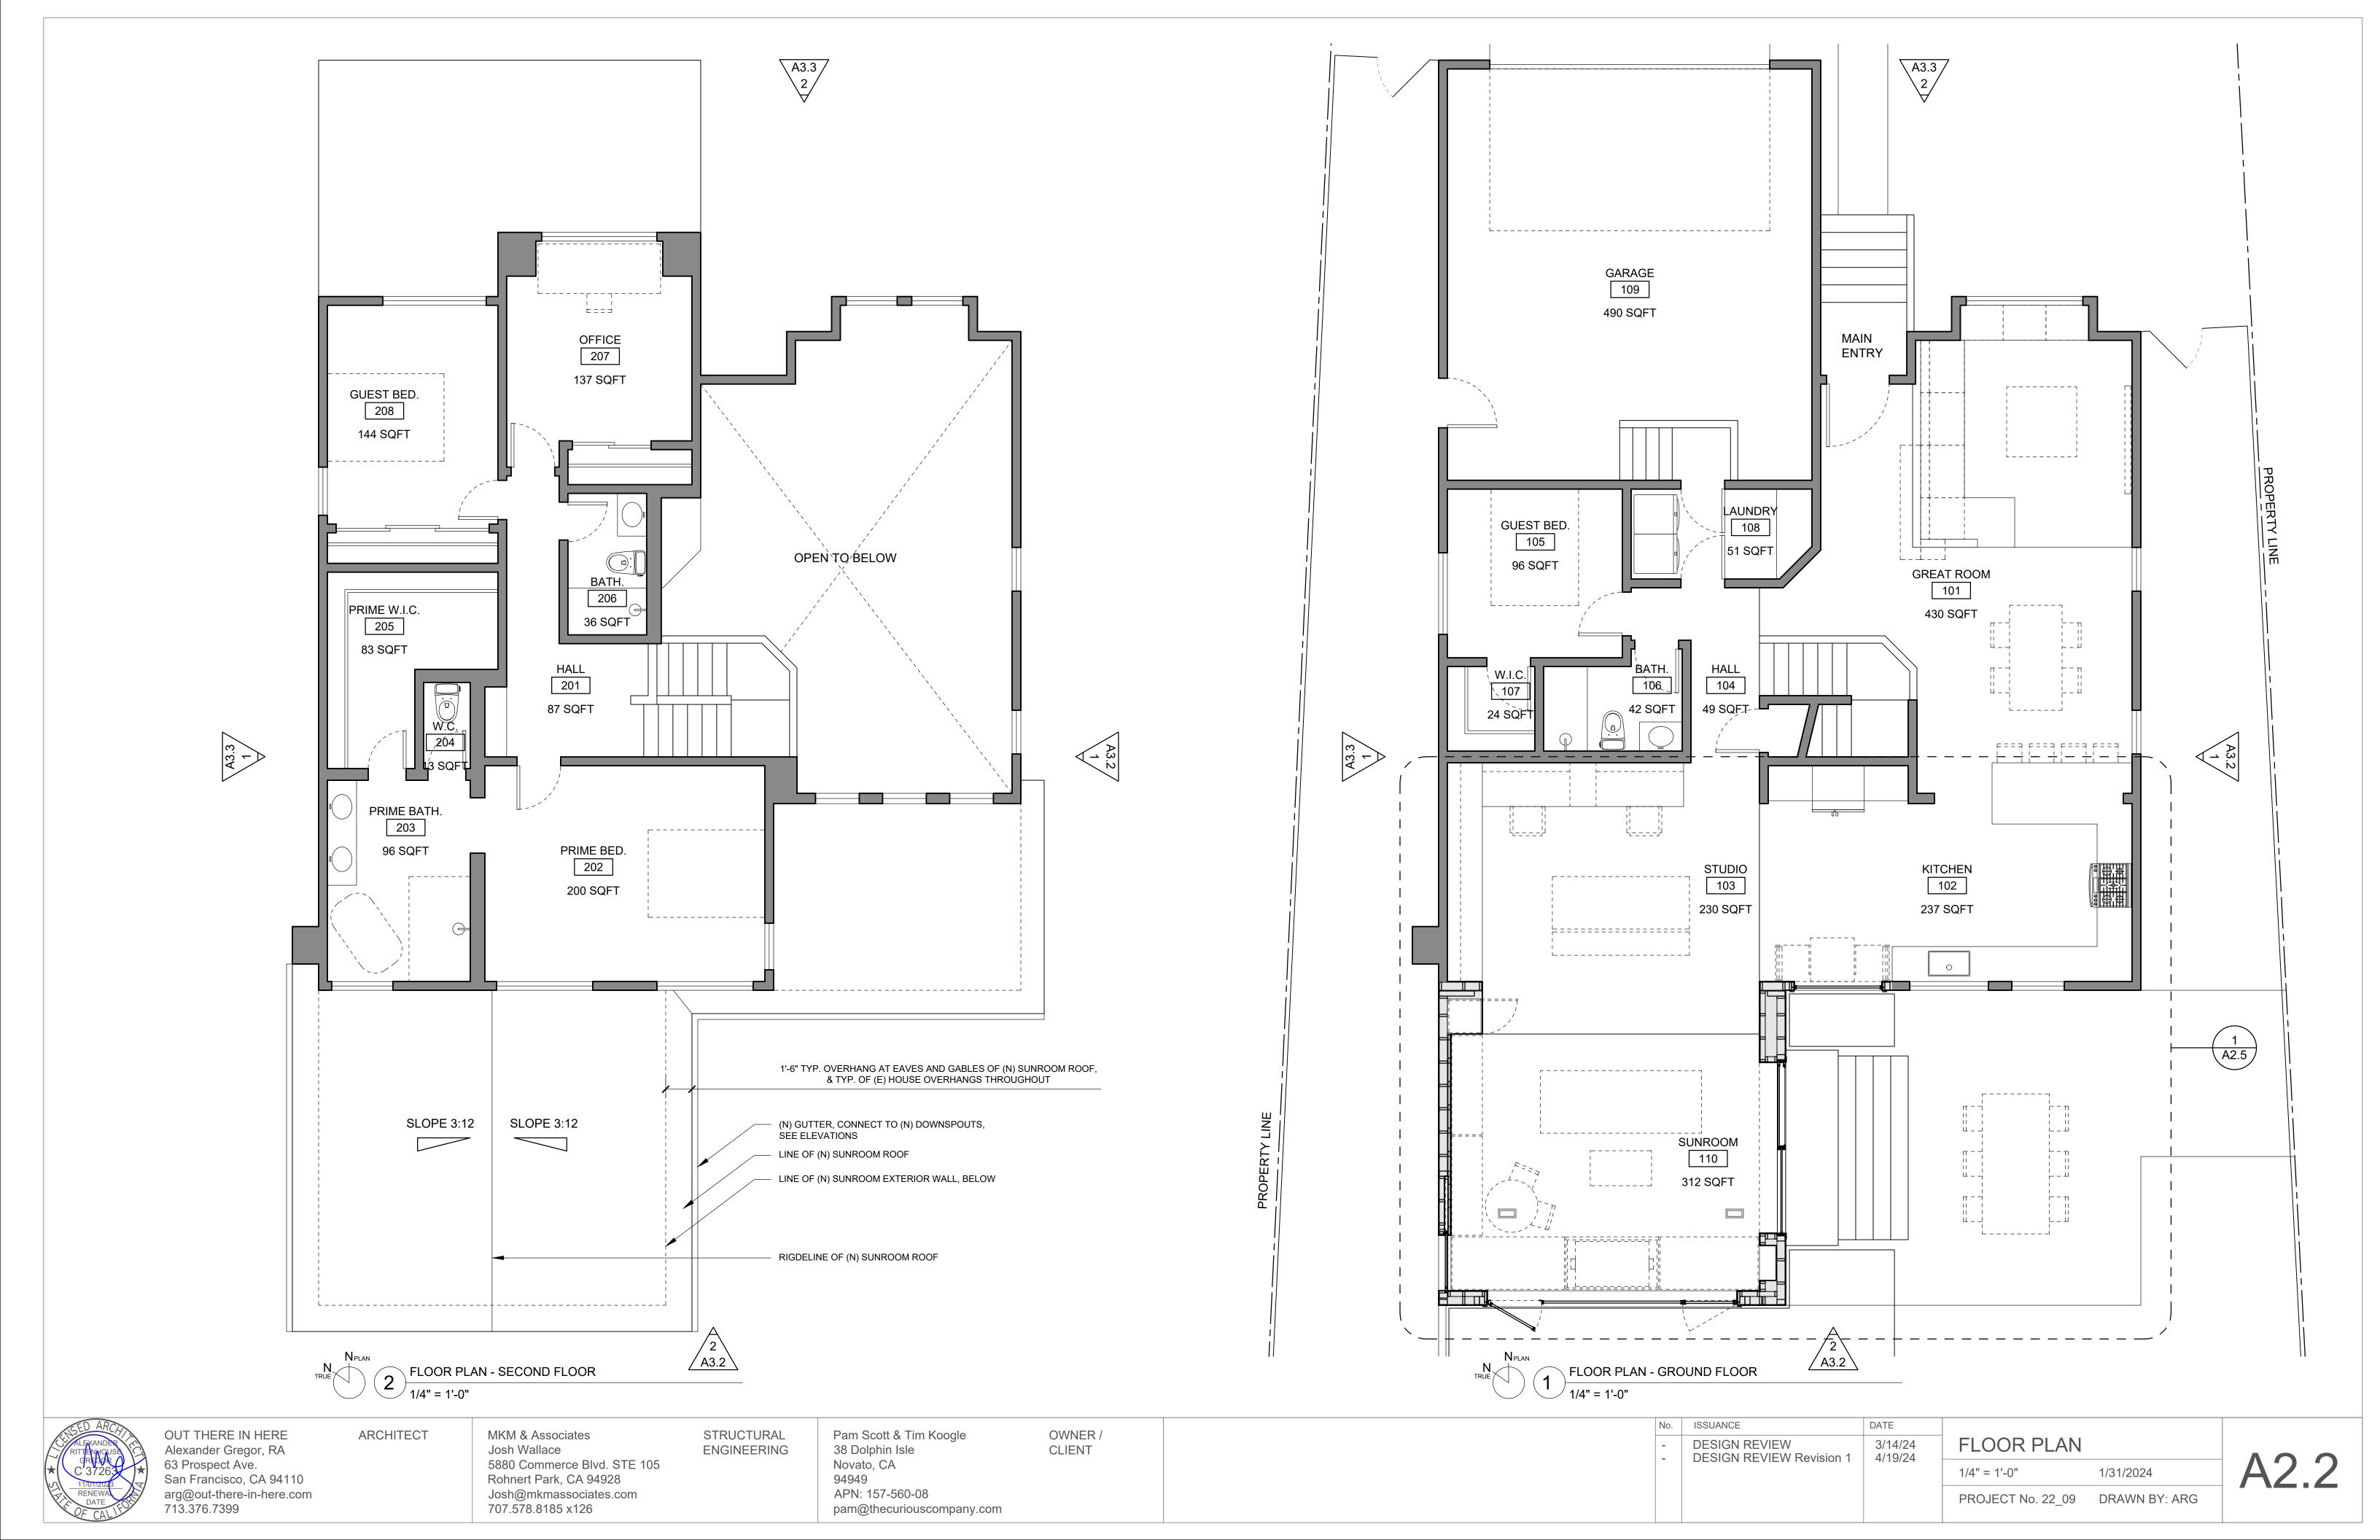

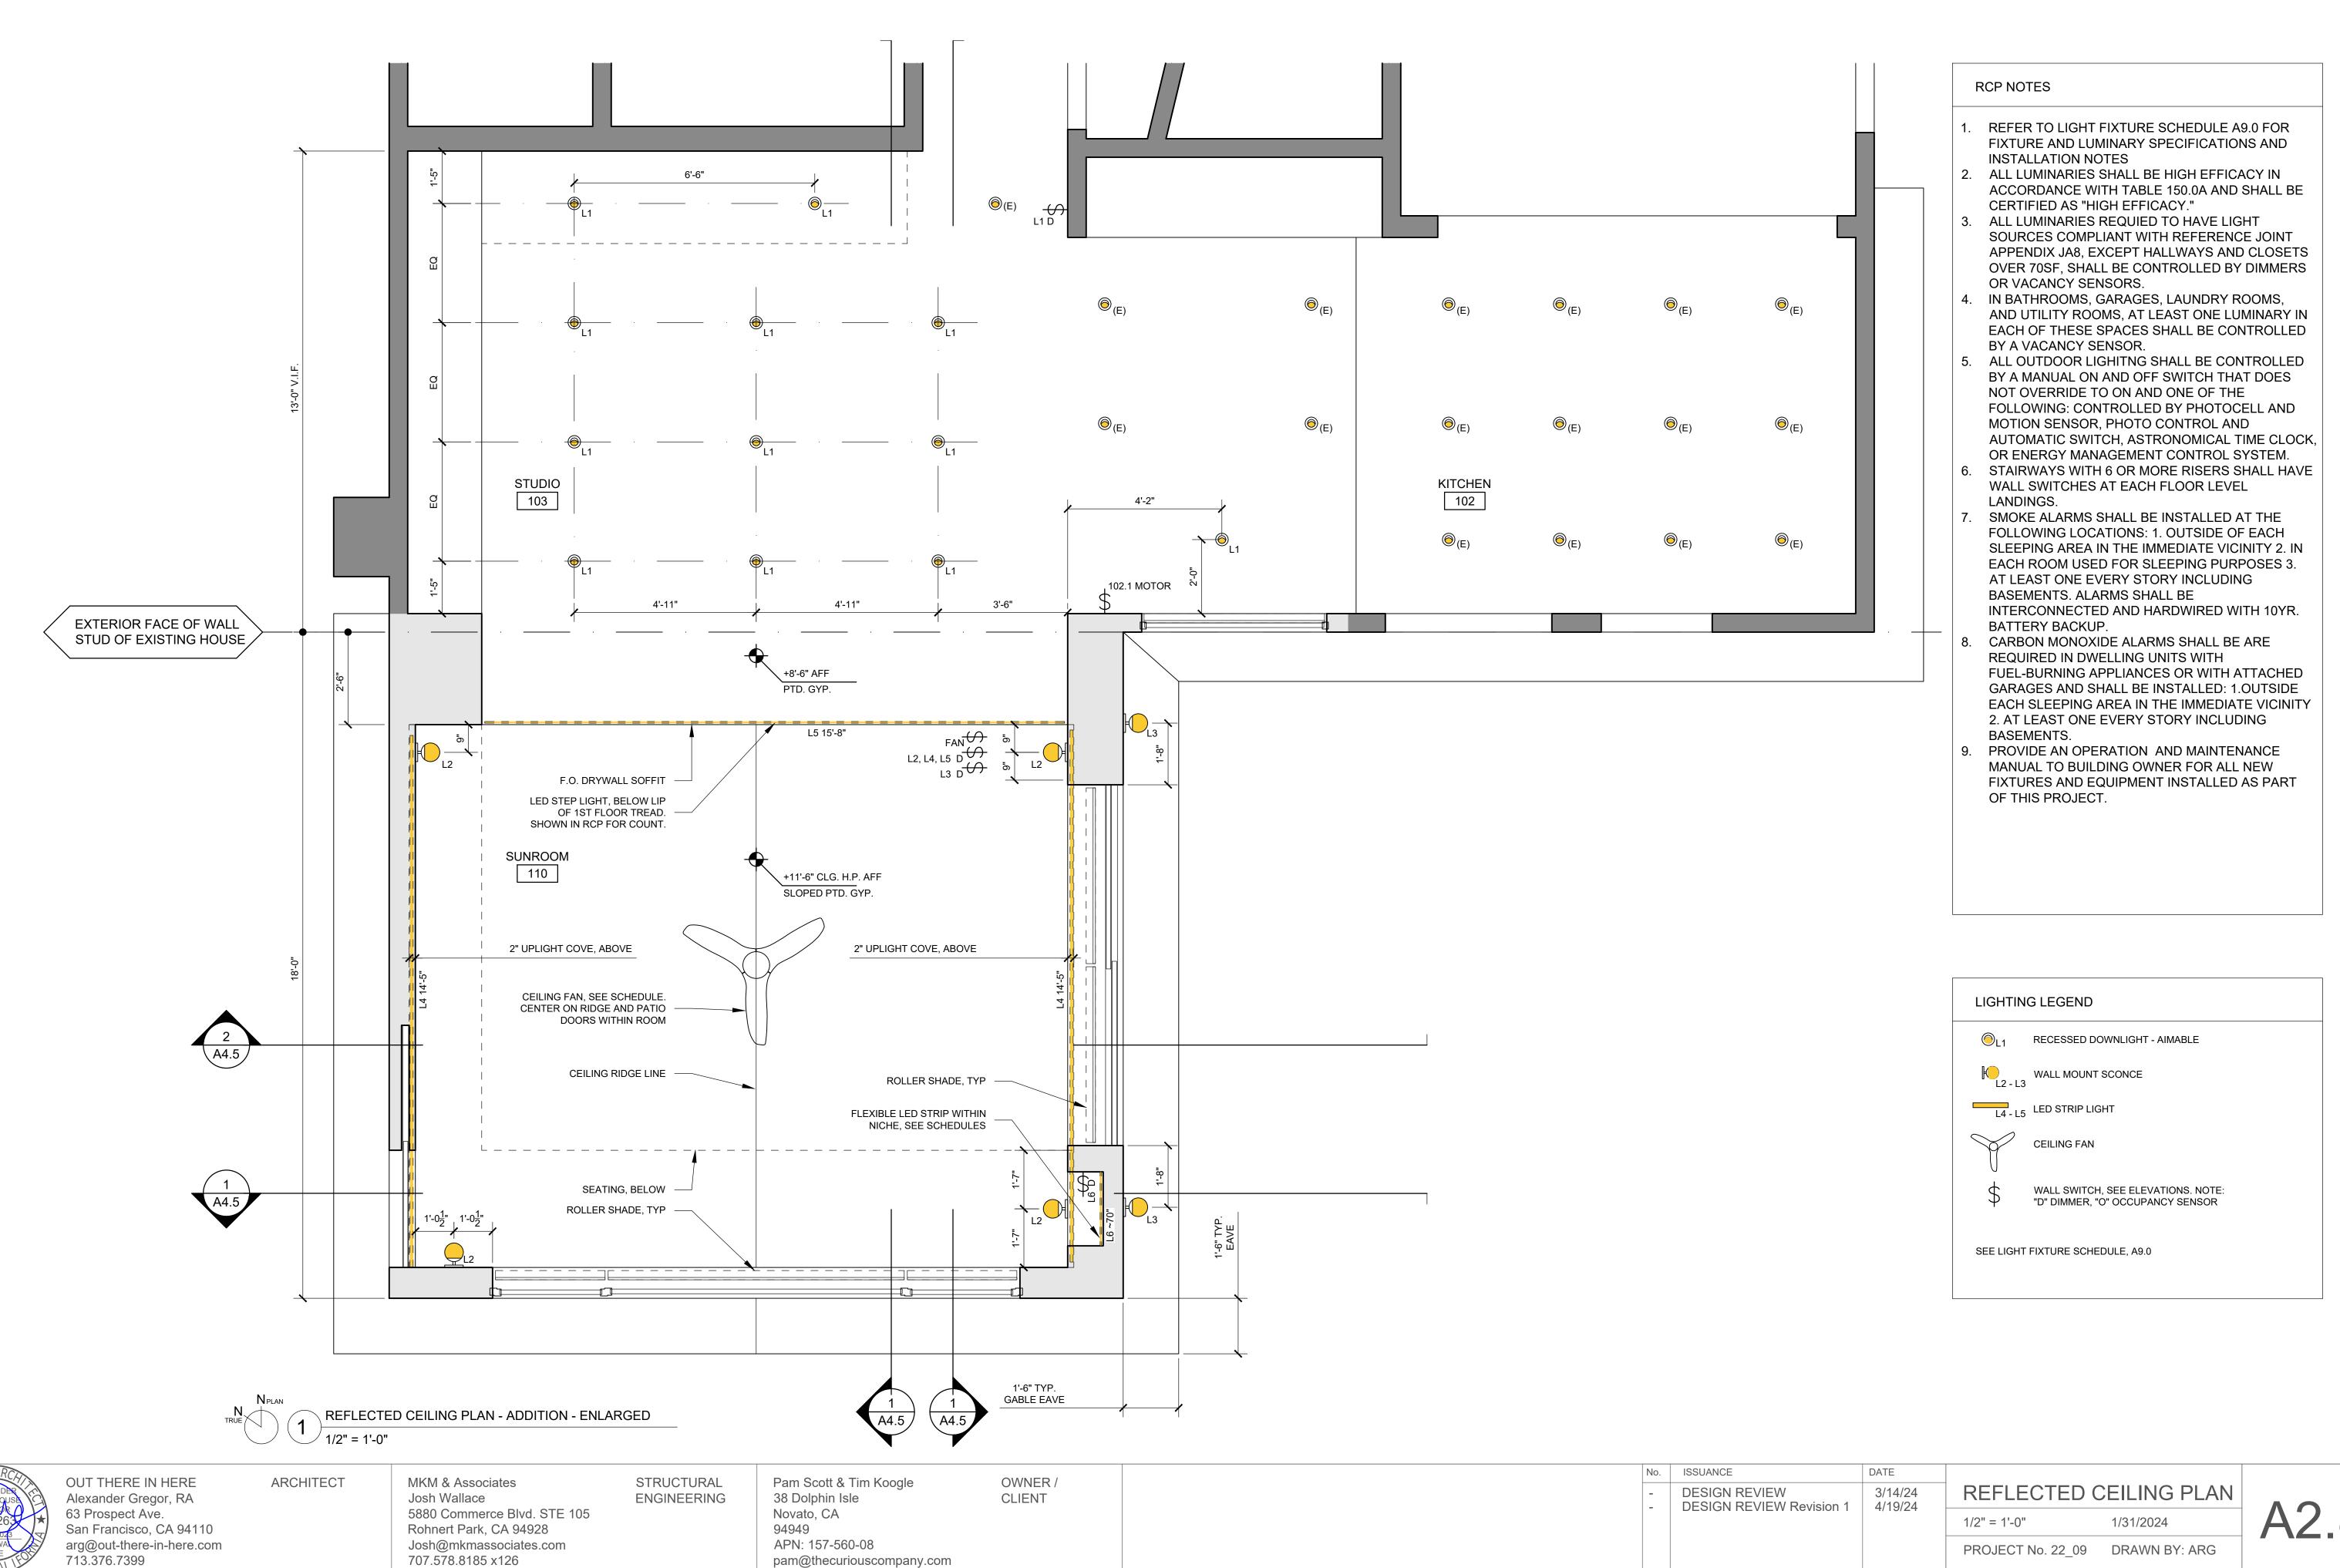

AREA OF WORK

ON HINTER, WE SHAPE ALTHREAM OF SH

ALEXANDER RITTENHOUSE GREGOR

C 37263

11/01/203

RENEWAL

DATE

OF CALL

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[/] 1/4" = 1'-0"

EXISTING EXTERIOR ELEVATION - SOUTH

2 EXISTING E 1/4" = 1'-0"

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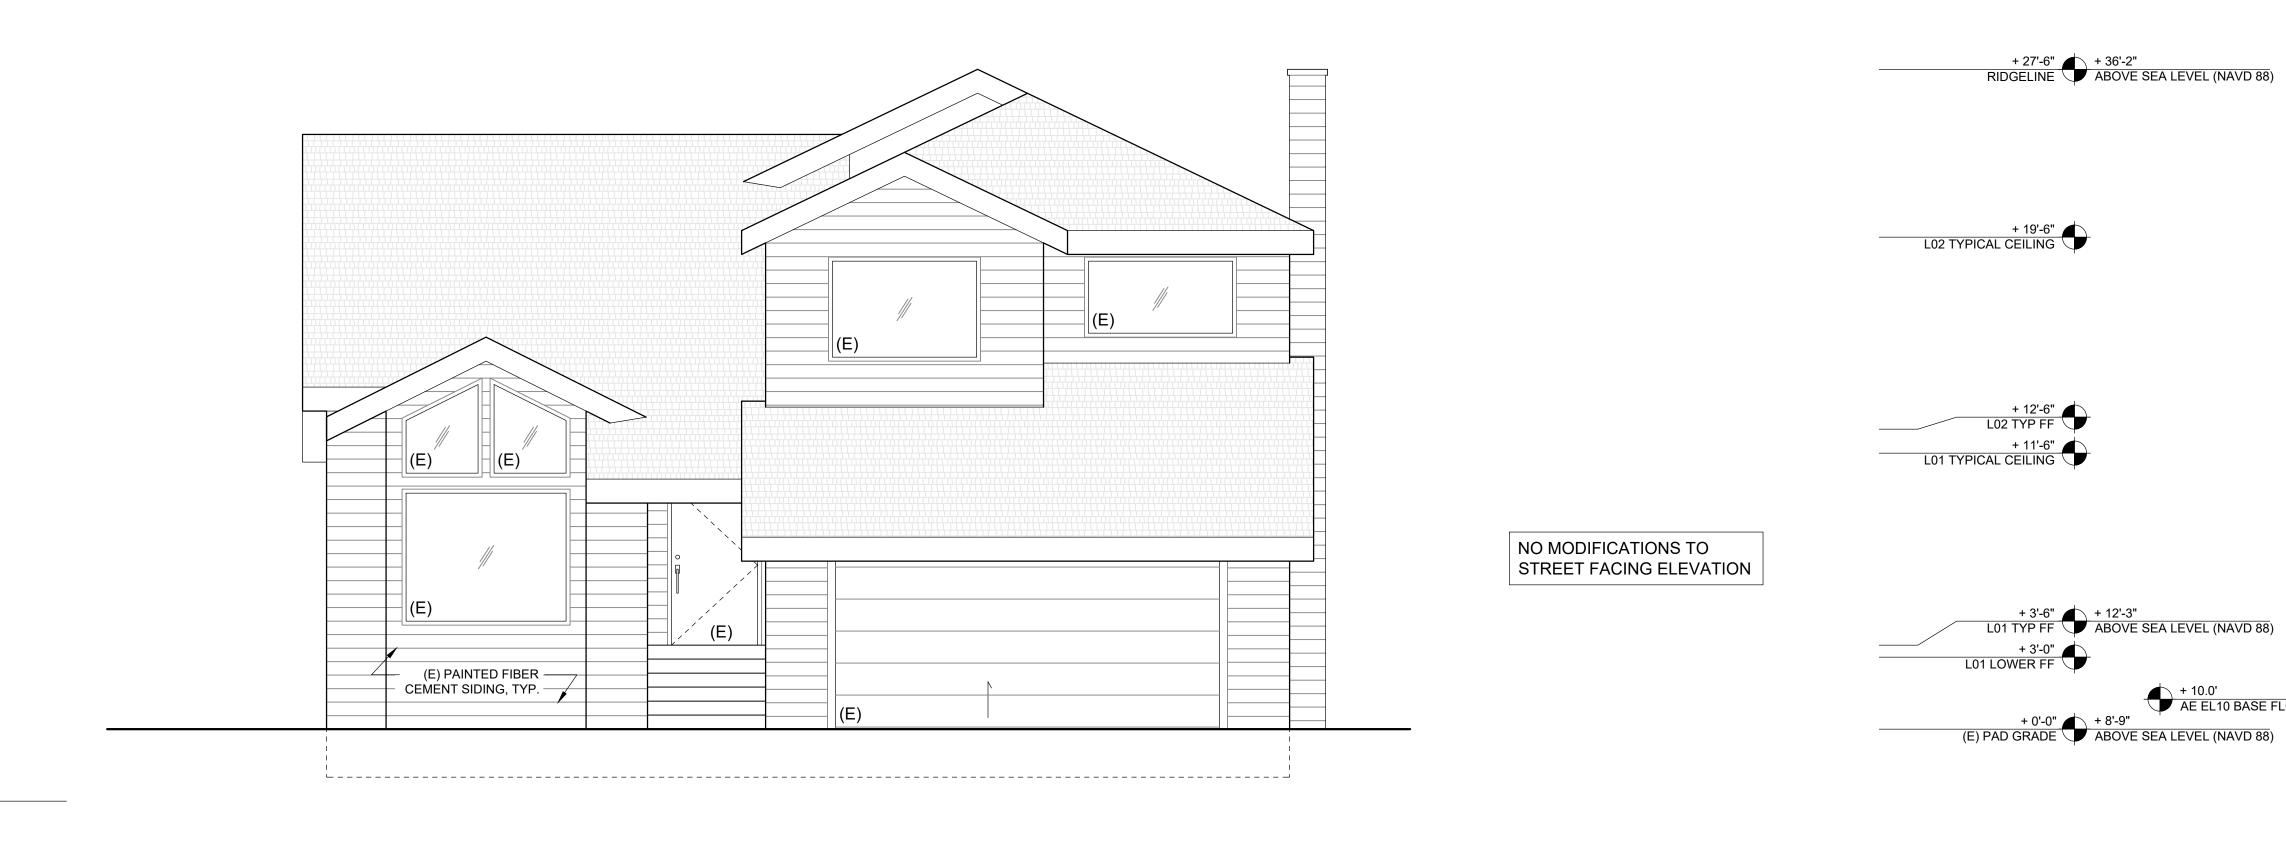
STRUCTURAL ENGINEERING


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OWNER / CLIENT No. ISSUANCE DATE

- DESIGN REVIEW 3/14/24
- DESIGN REVIEW Revision 1 4/19/24

PROJECT No. 22_09 DRAWN BY: ARG



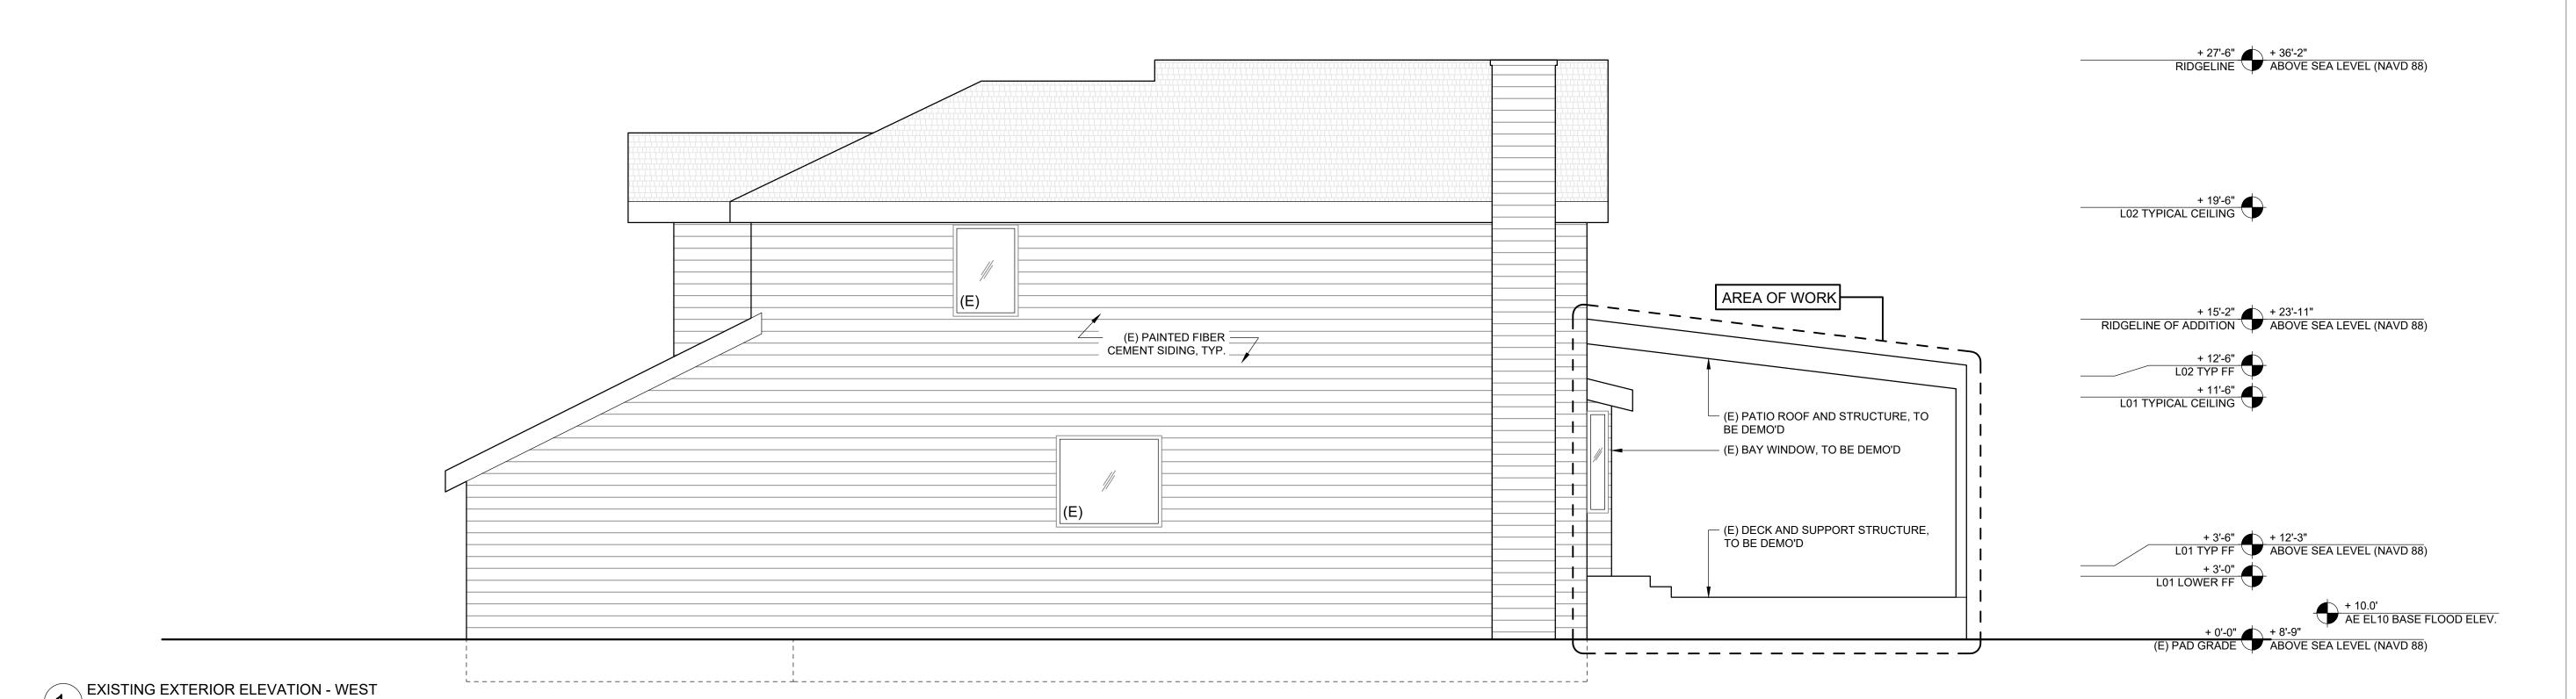

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GREGOR
C 37263
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RENEWAL
DATE

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ARCHITECT

[/] 1/4" = 1'-0"

2 EXISTING EXTERIOR ELEVATION - NORTH

1/4" = 1'-0"

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STRUCTURAL ENGINEERING


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EXIST. EXT. ELEVATIONS

1/4" = 1'-0" 1/31/2024

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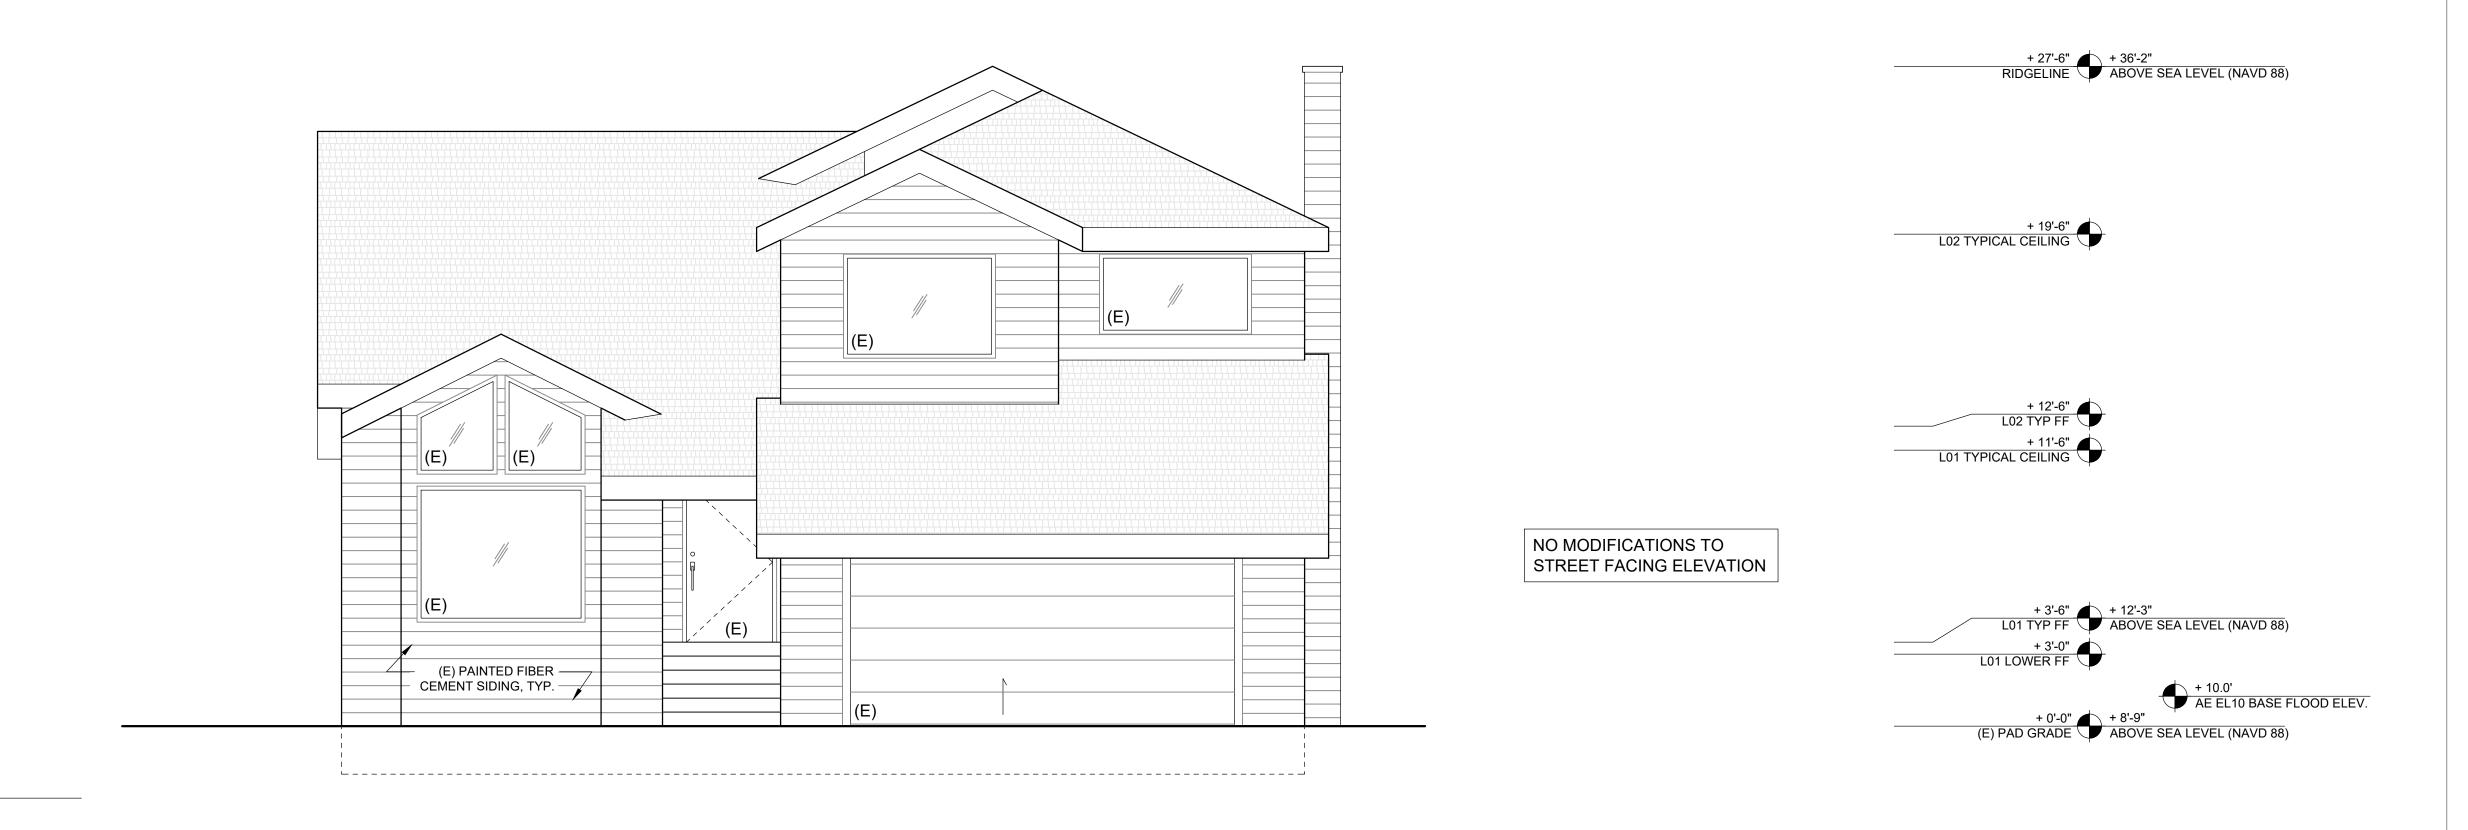
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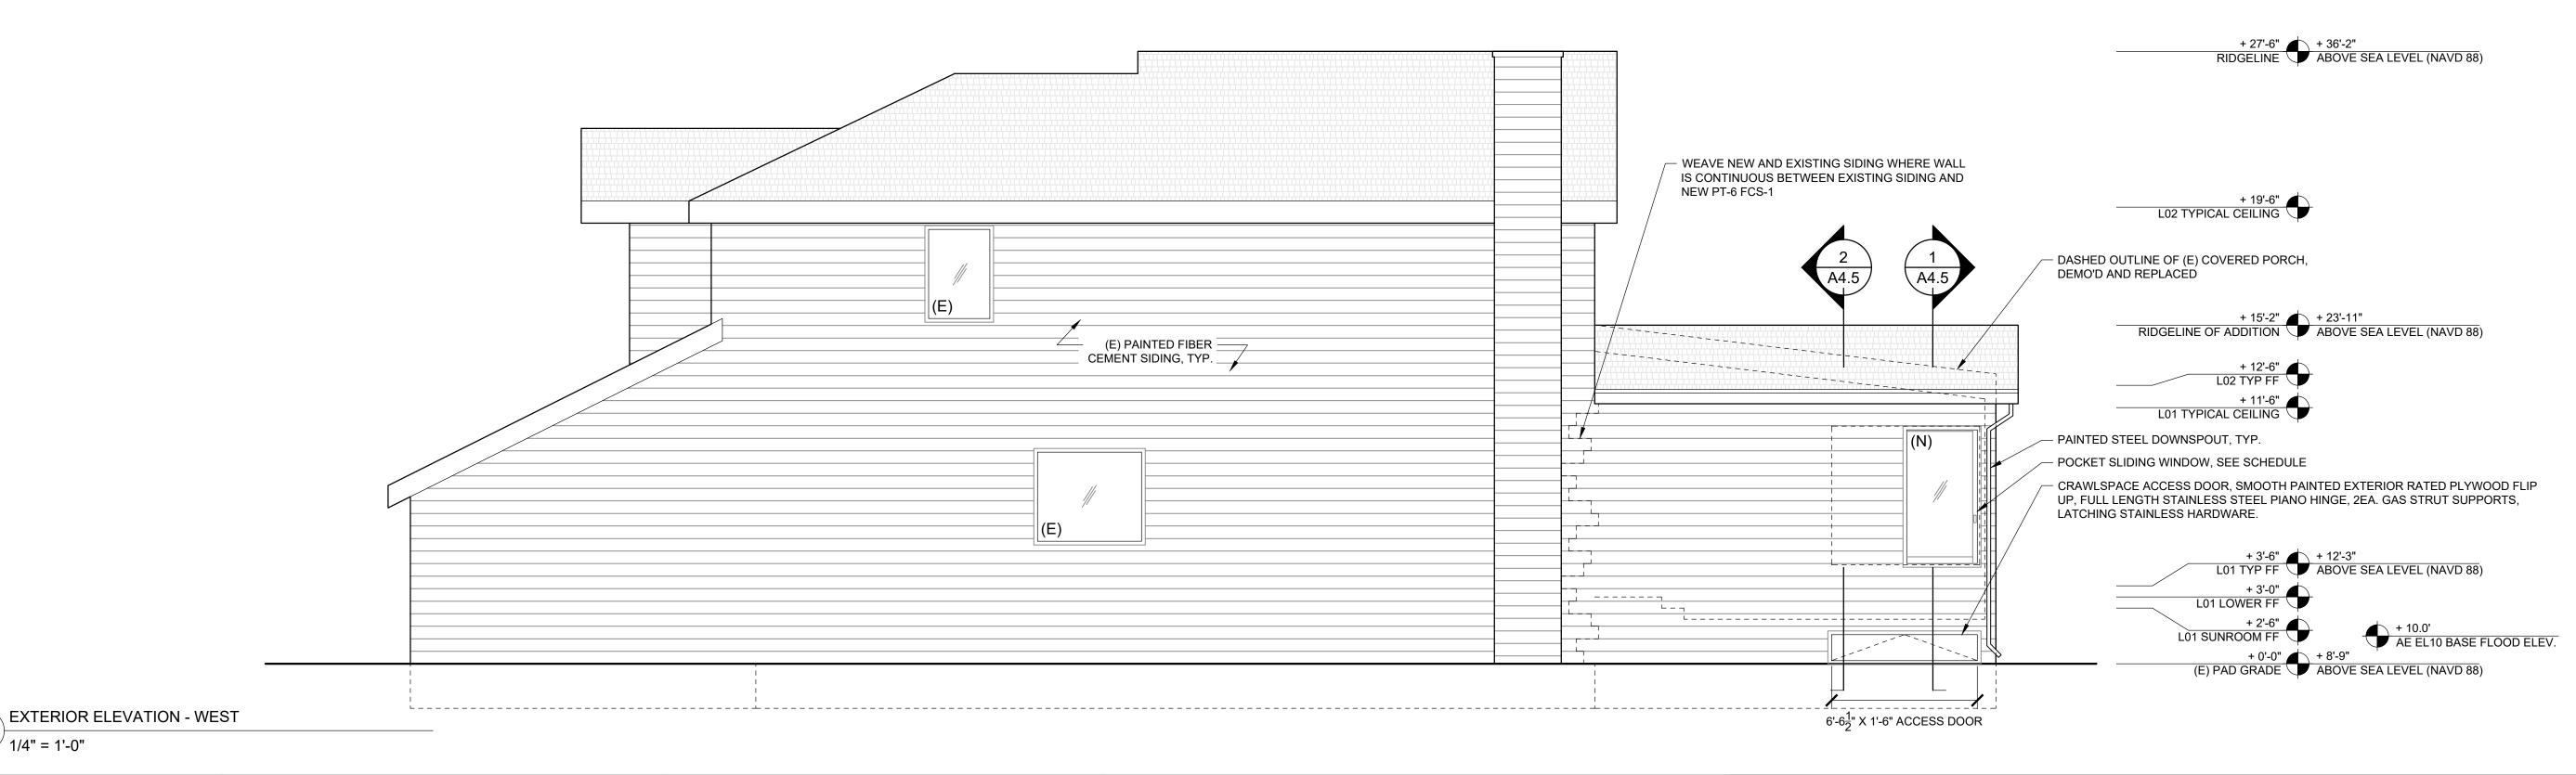
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3/14/24 4/19/24 **EXTERIOR ELEVATIONS** 1/4" = 1'-0" 1/31/2024

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 $2 \frac{\text{EXTERIOR ELEVATION - NORTH}}{1/4" = 1'-0"}$

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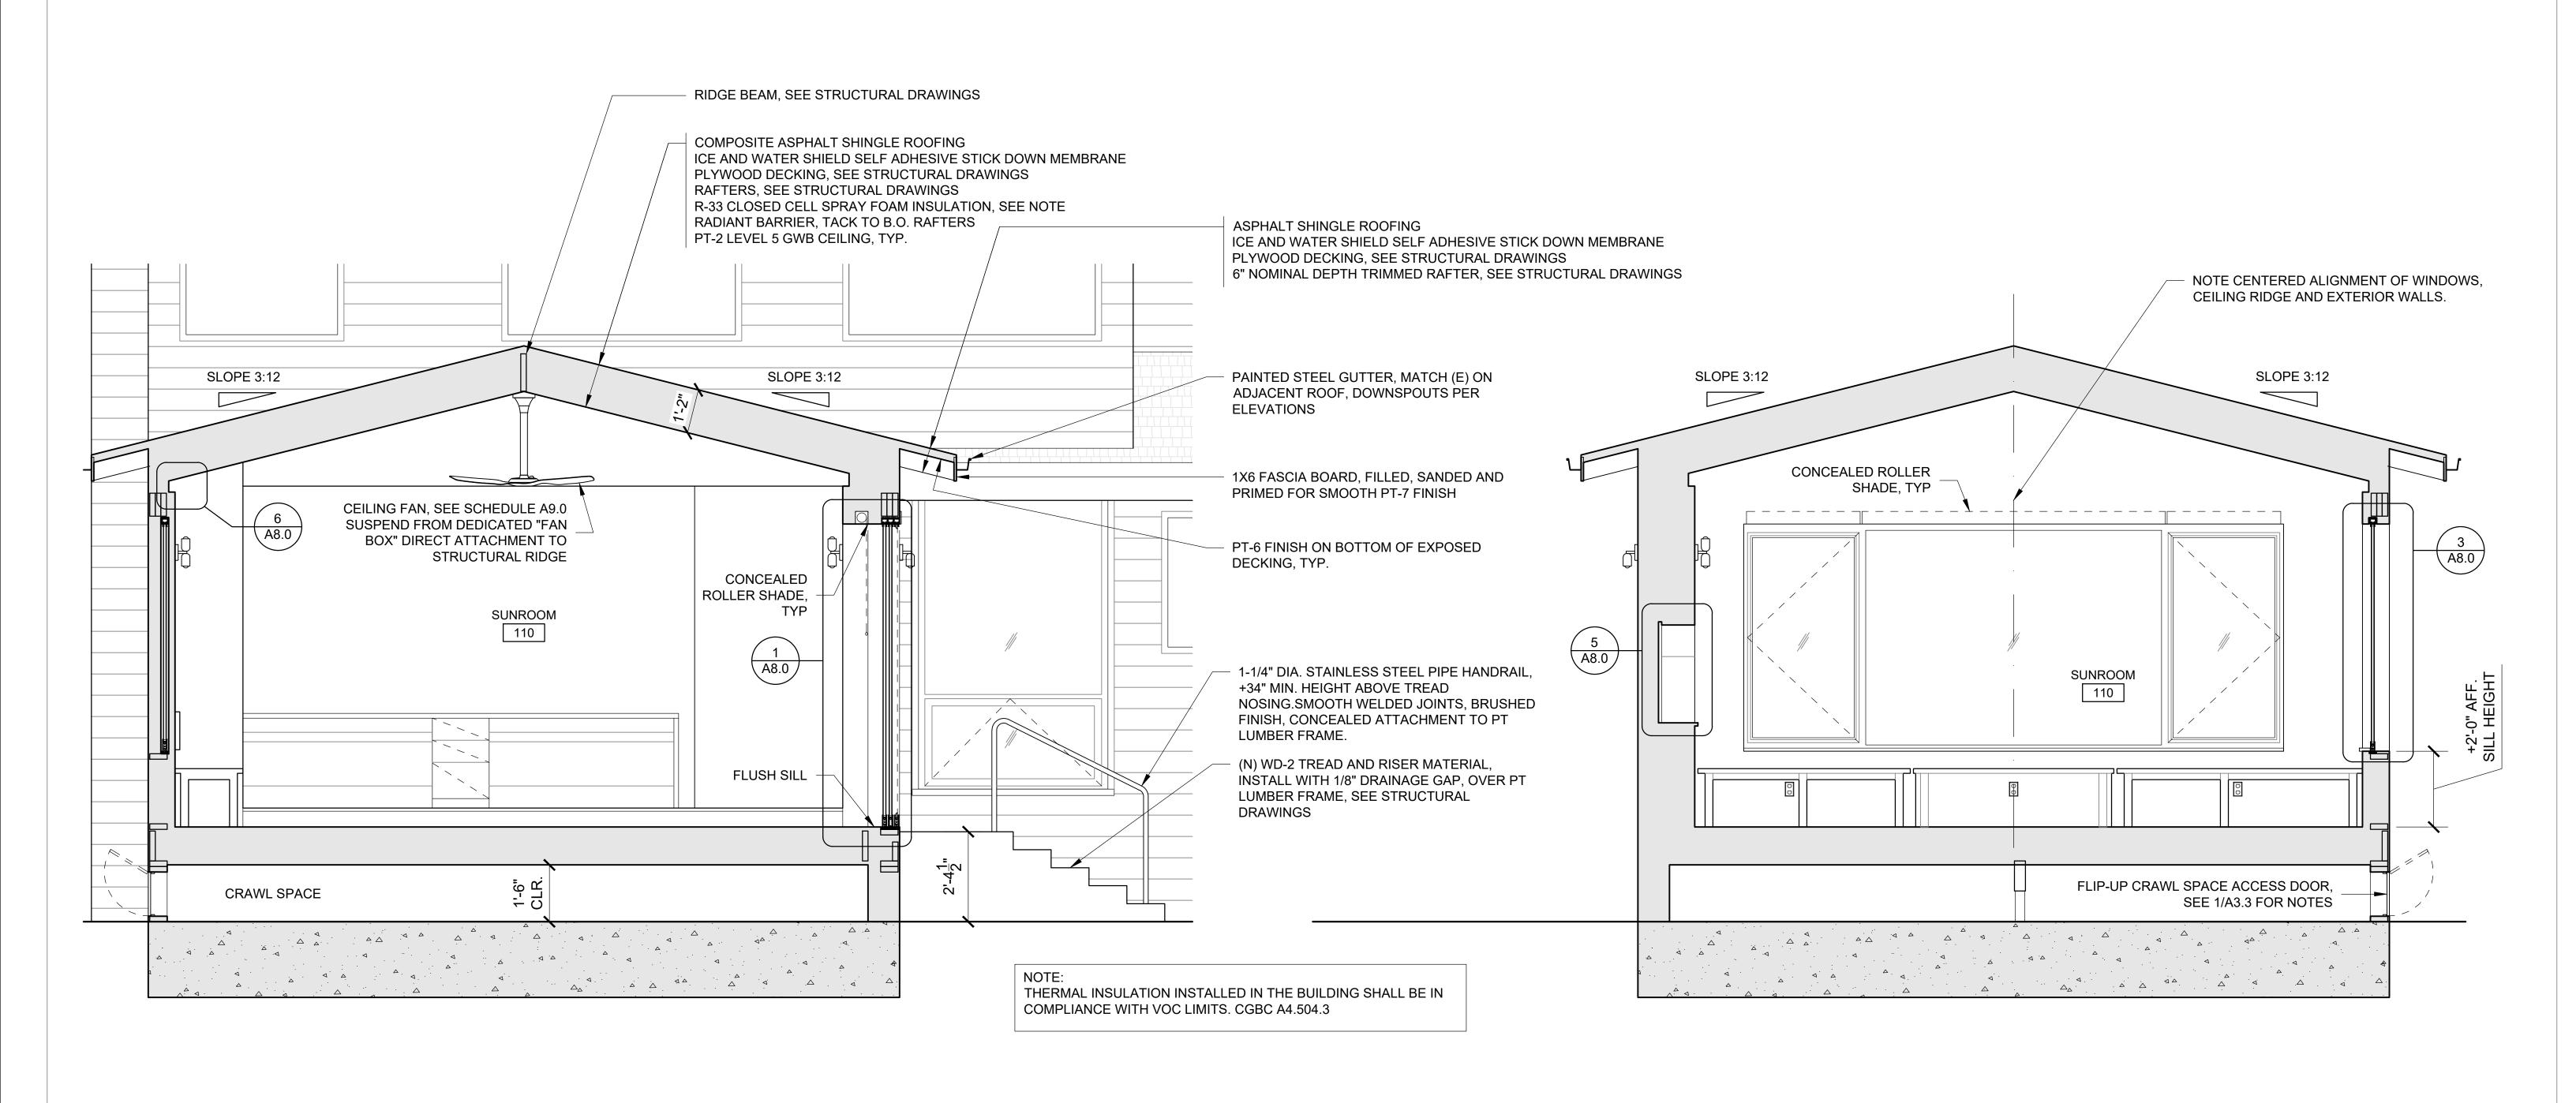
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3/14/24 4/19/24 EXTERIOR ELEVATIONS 1/4" = 1'-0" 1/31/2024
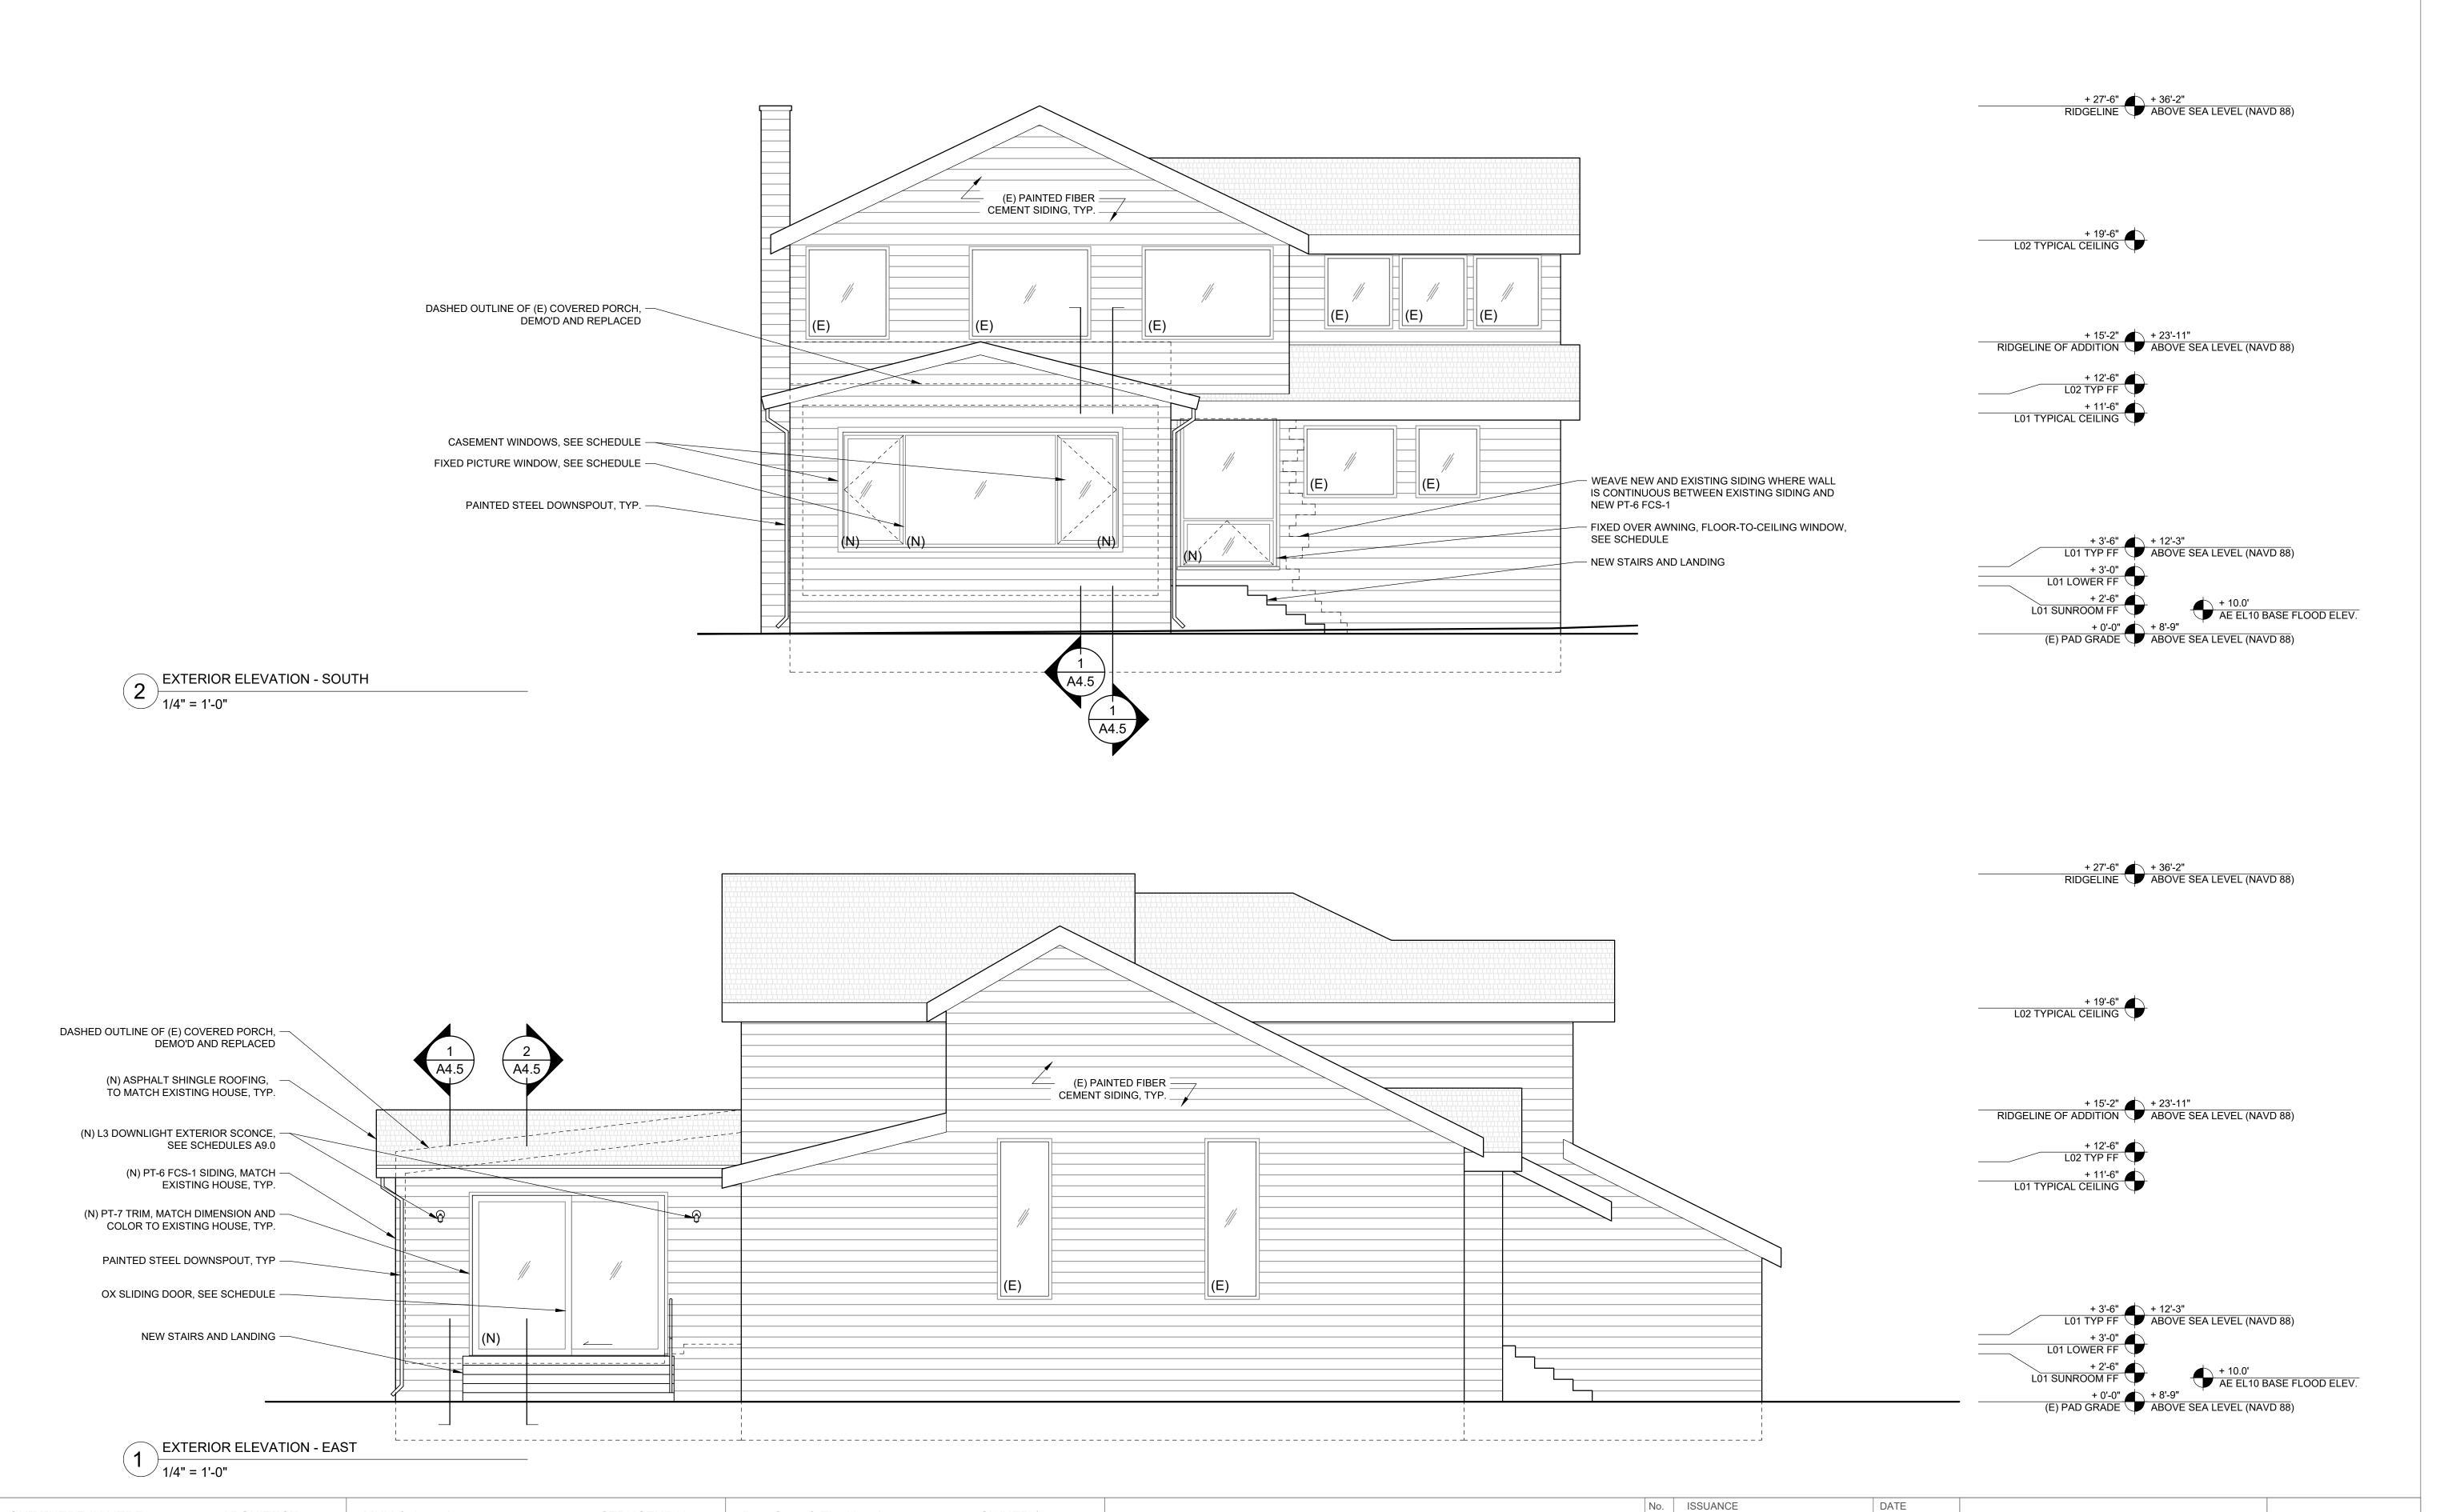
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SECTION - ADDITION - FACING SOUTH

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 $2 \frac{\text{SECTION -}}{1/2" = 1'-0"}$

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SECTION - ADDITION - FACING NORTH

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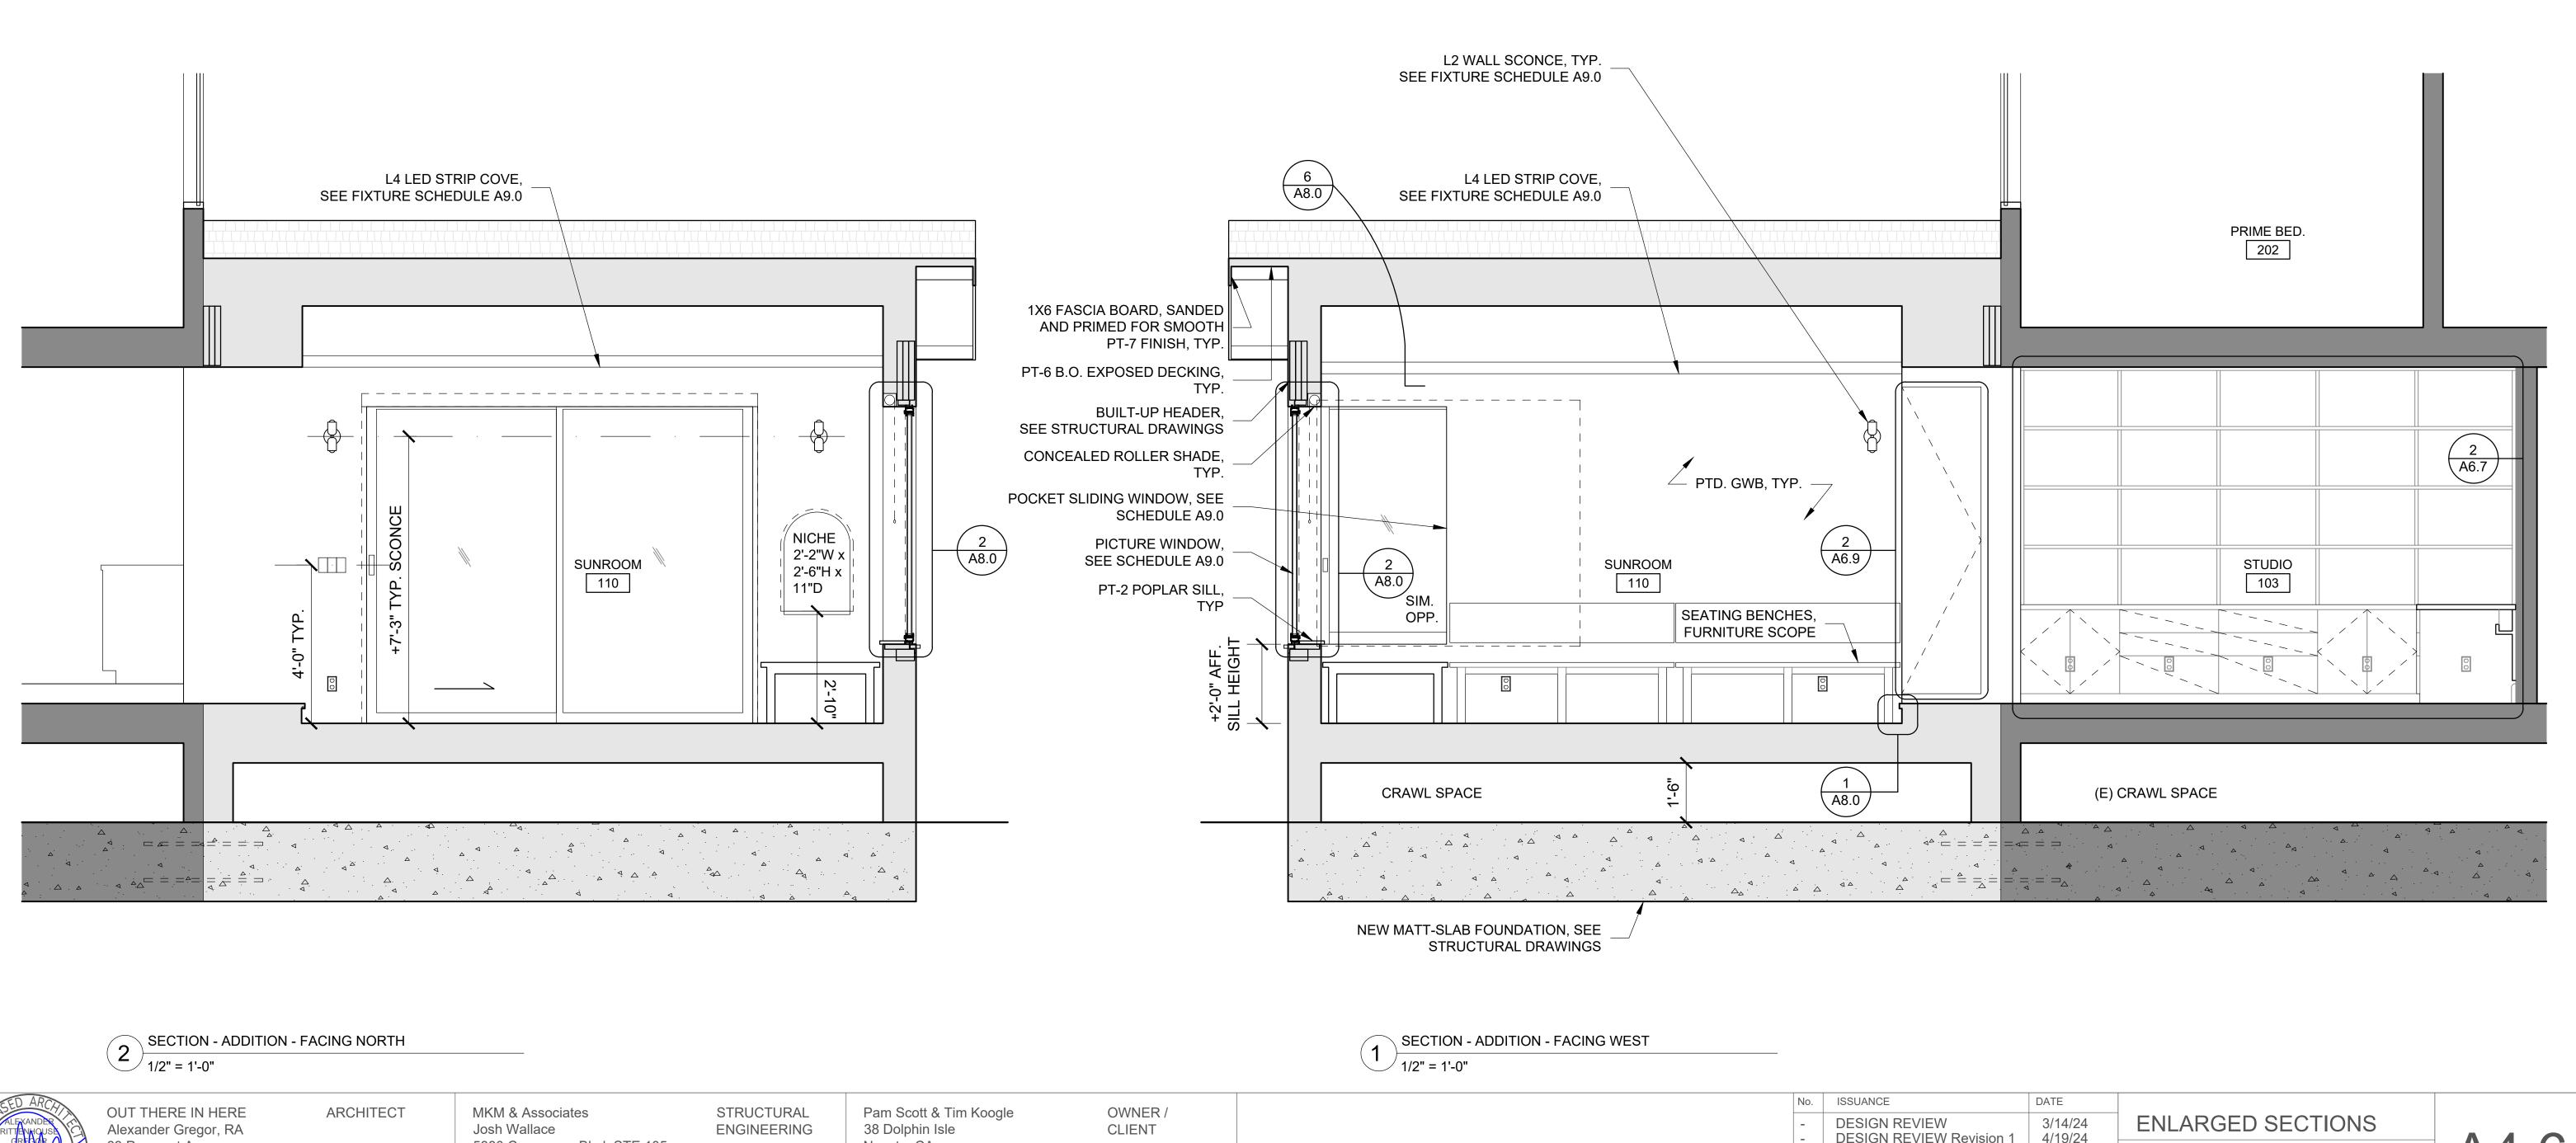
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DATE 3/14/24 4/19/24

ENLARGED SECTIONS 1/31/2024 1/2" = 1'-0"

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A4.5




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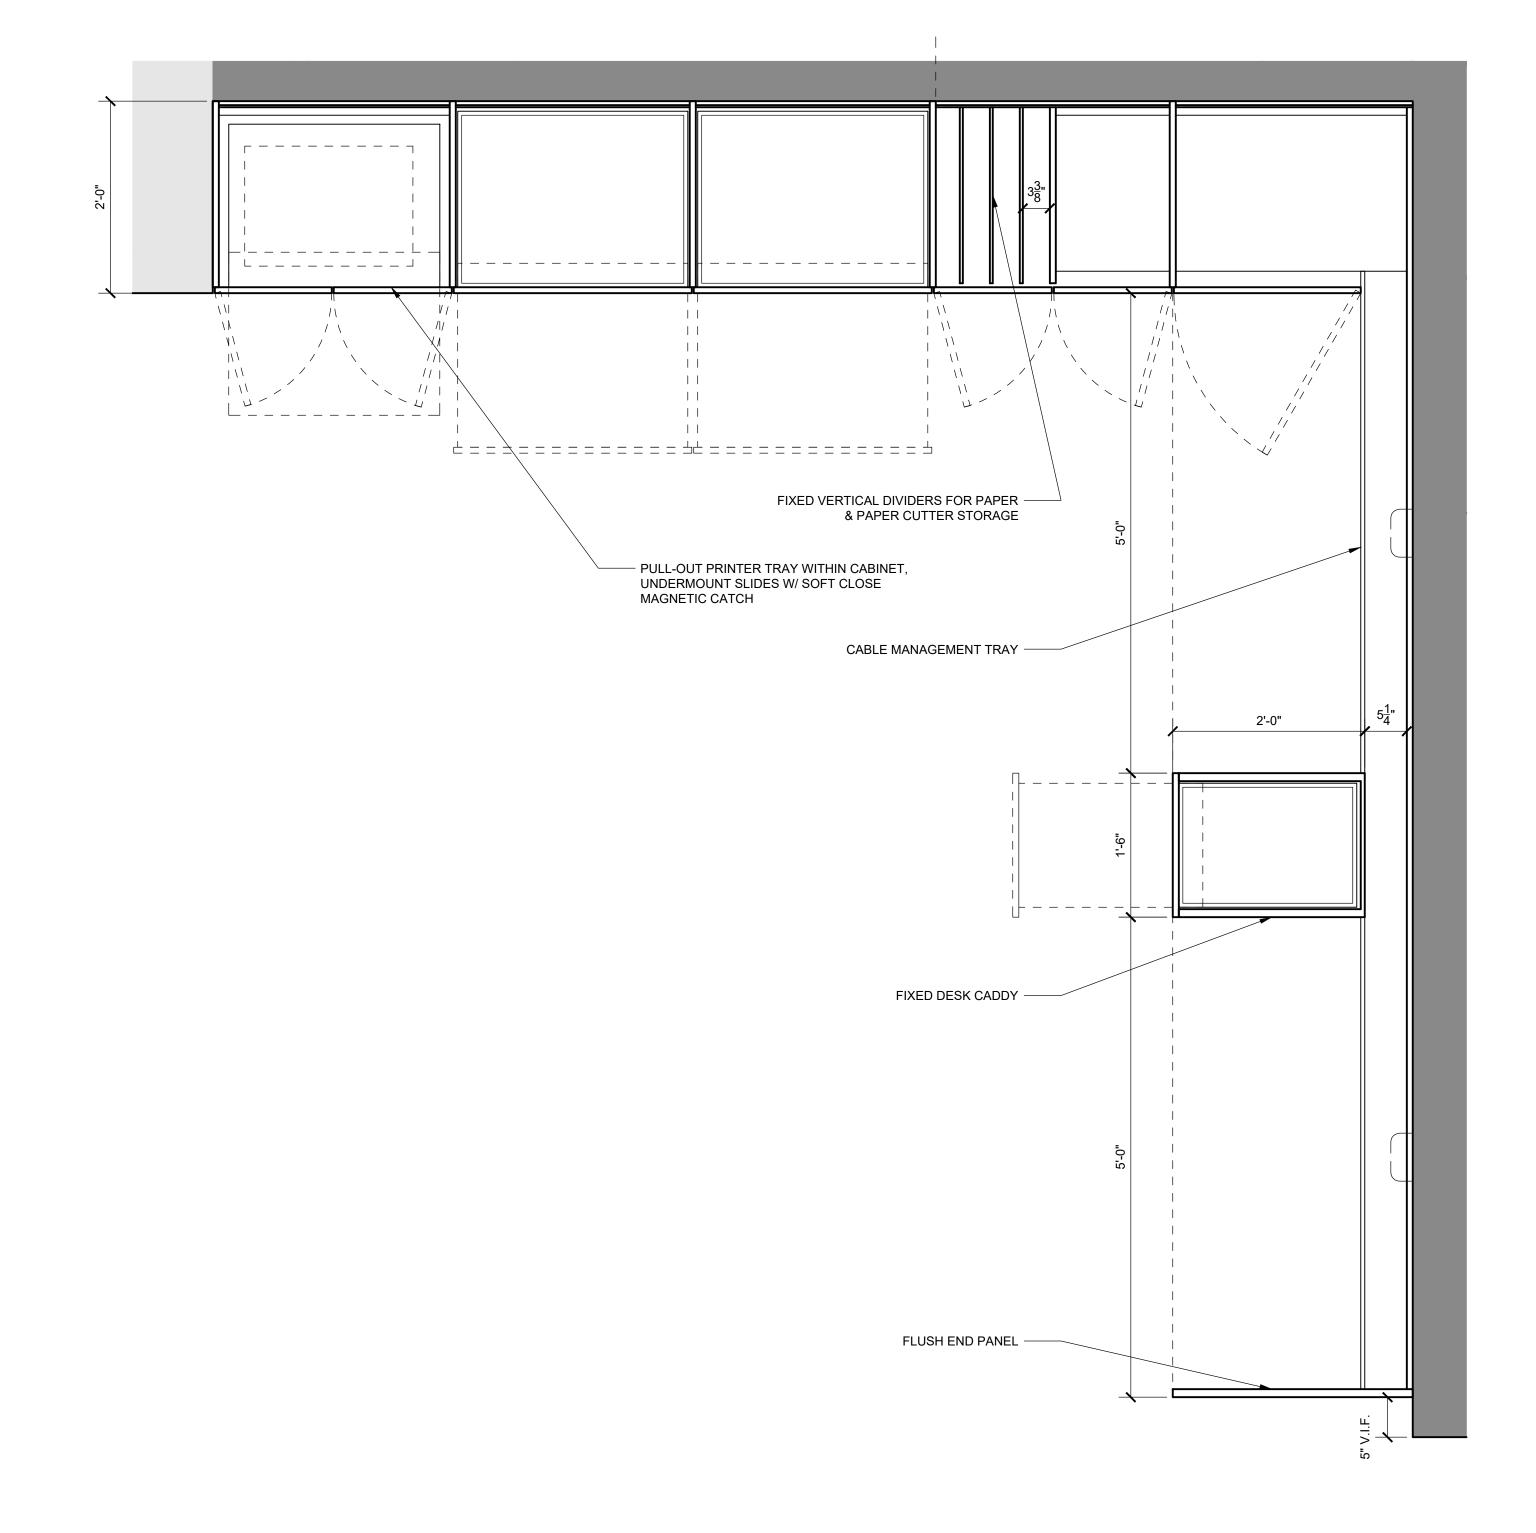
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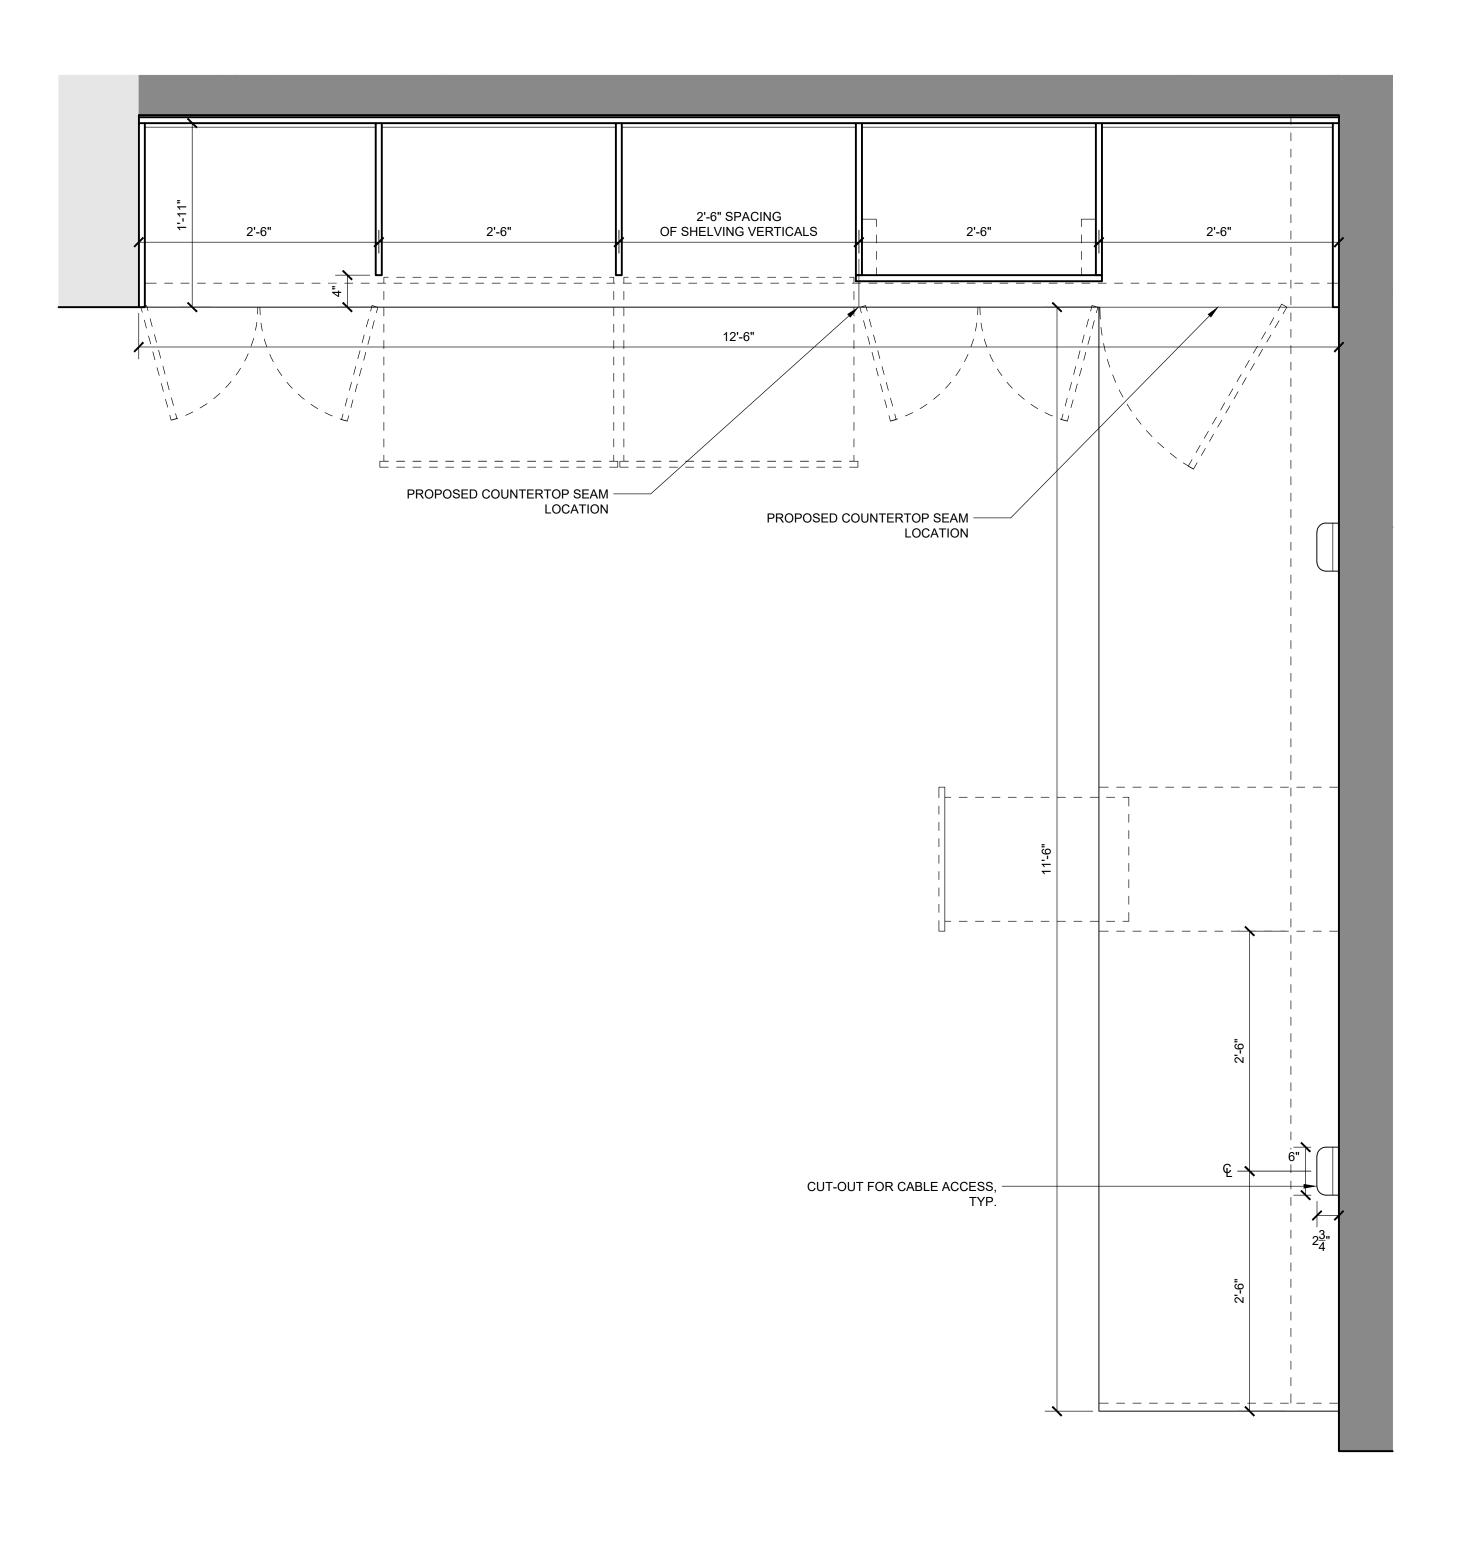
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DESIGN REVIEW Revision 1 4/19/24

1/2" = 1'-0" 1/31/2024





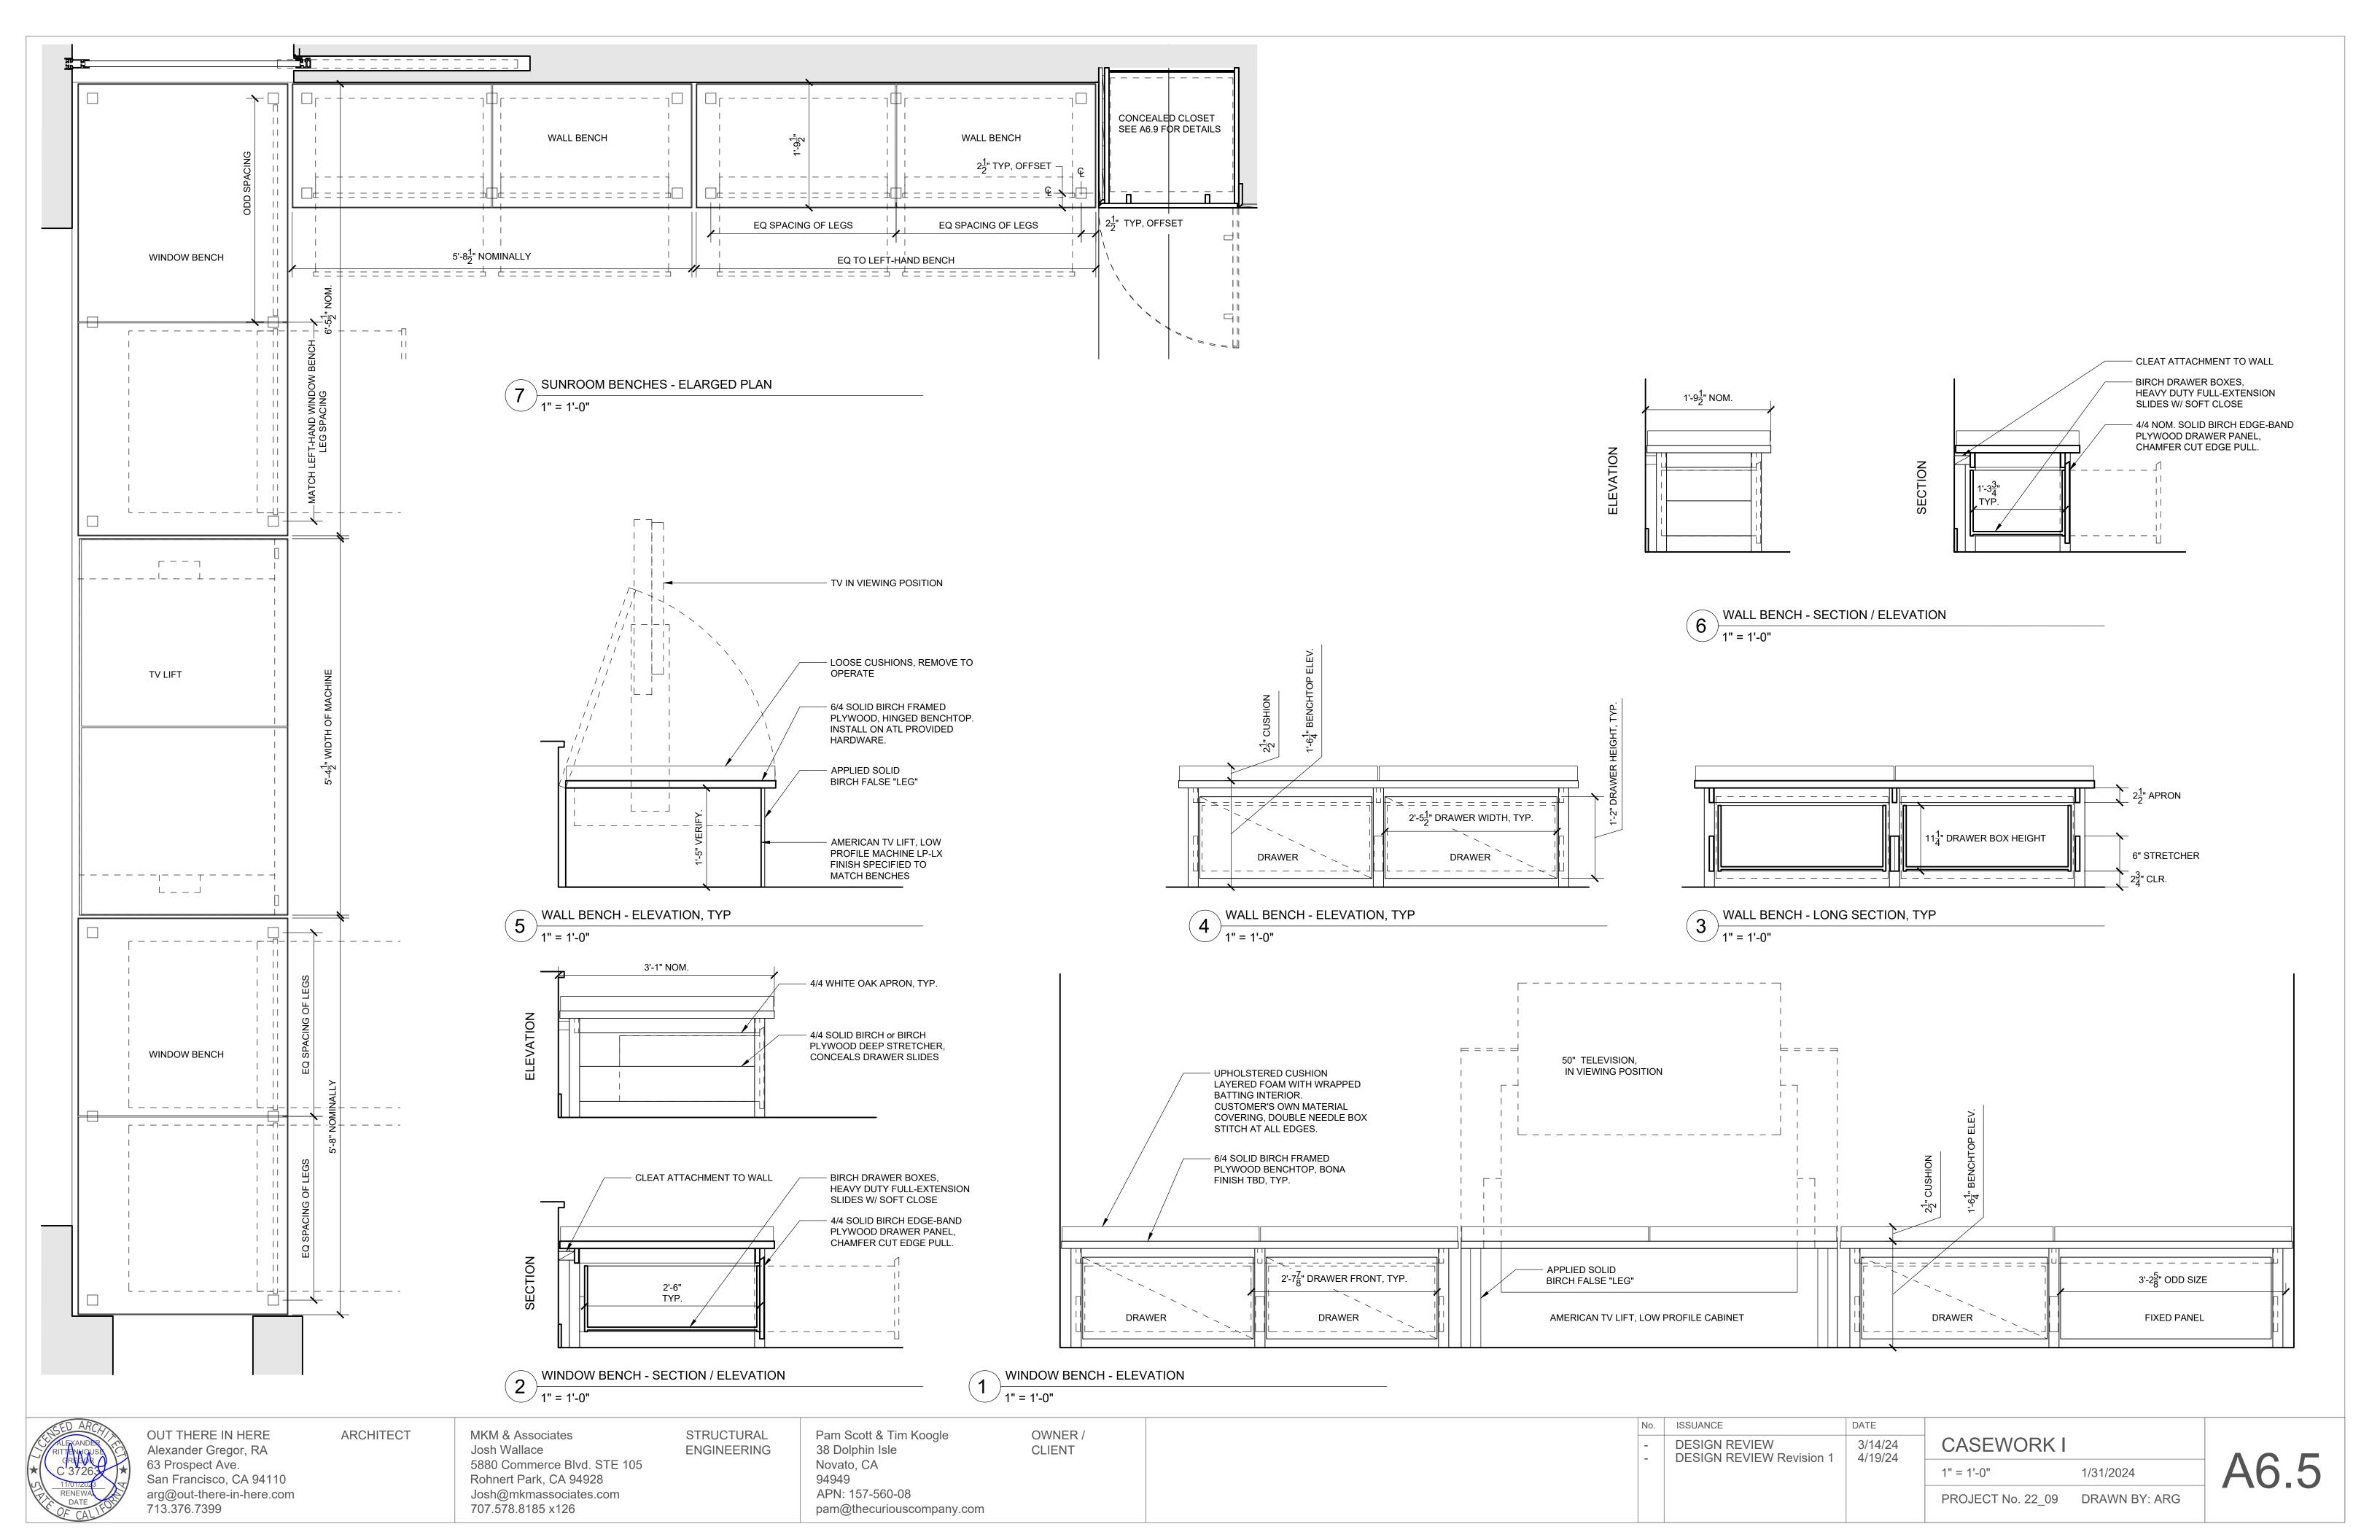

2 STUDIO CASEWORK ENLARGED PLAN - +2'-0" AFF CUT

1" = 1'-0"

STUDIO CASEWORK ENLARGED PLAN - +6'-0" AFF CUT

1" = 1'-0"

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3/14/24 4/19/24 1" = 1'-0"


CASEWORK II


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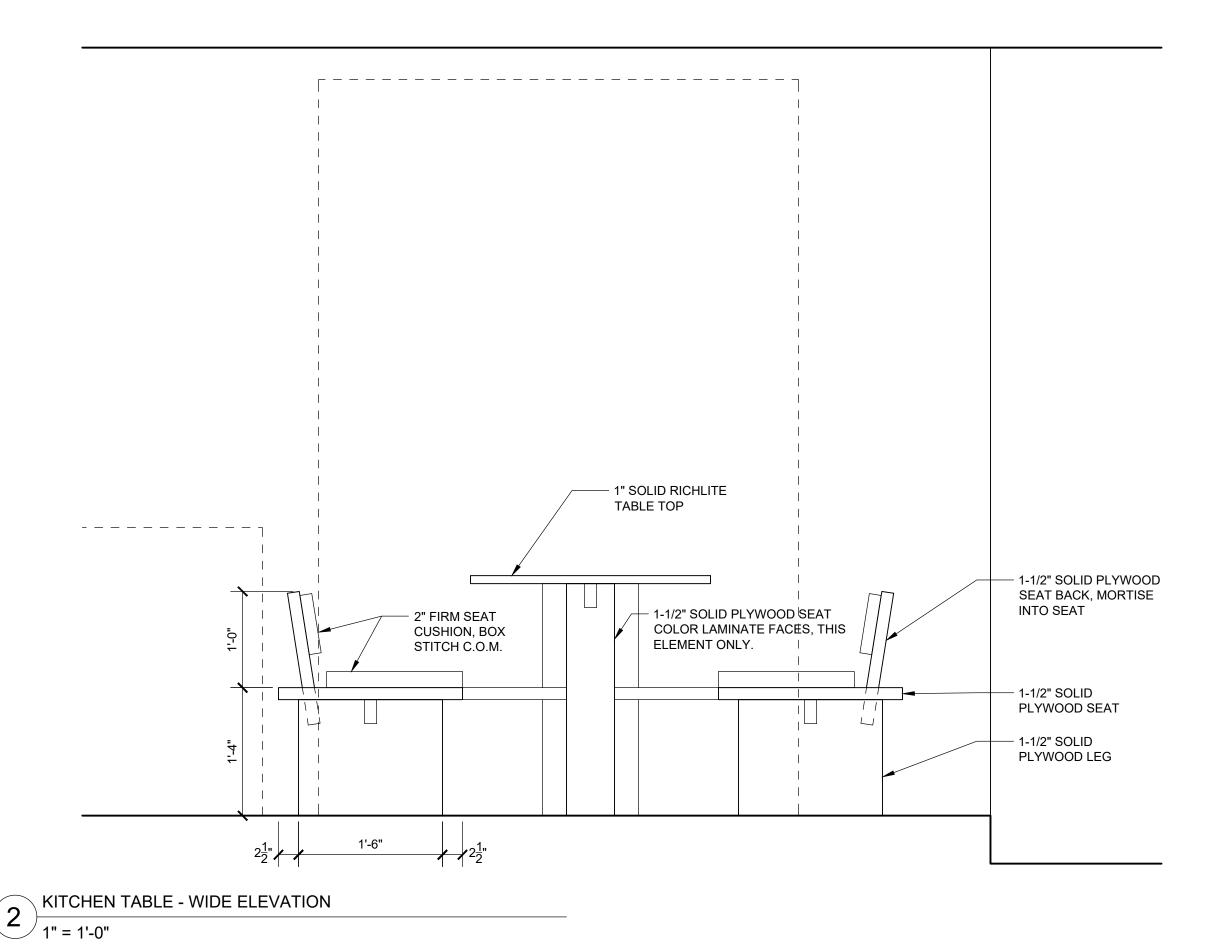
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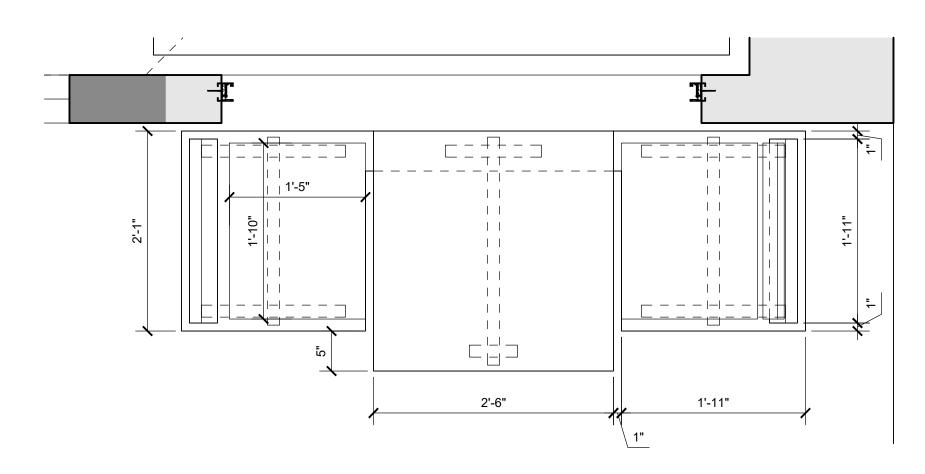
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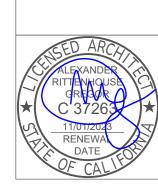






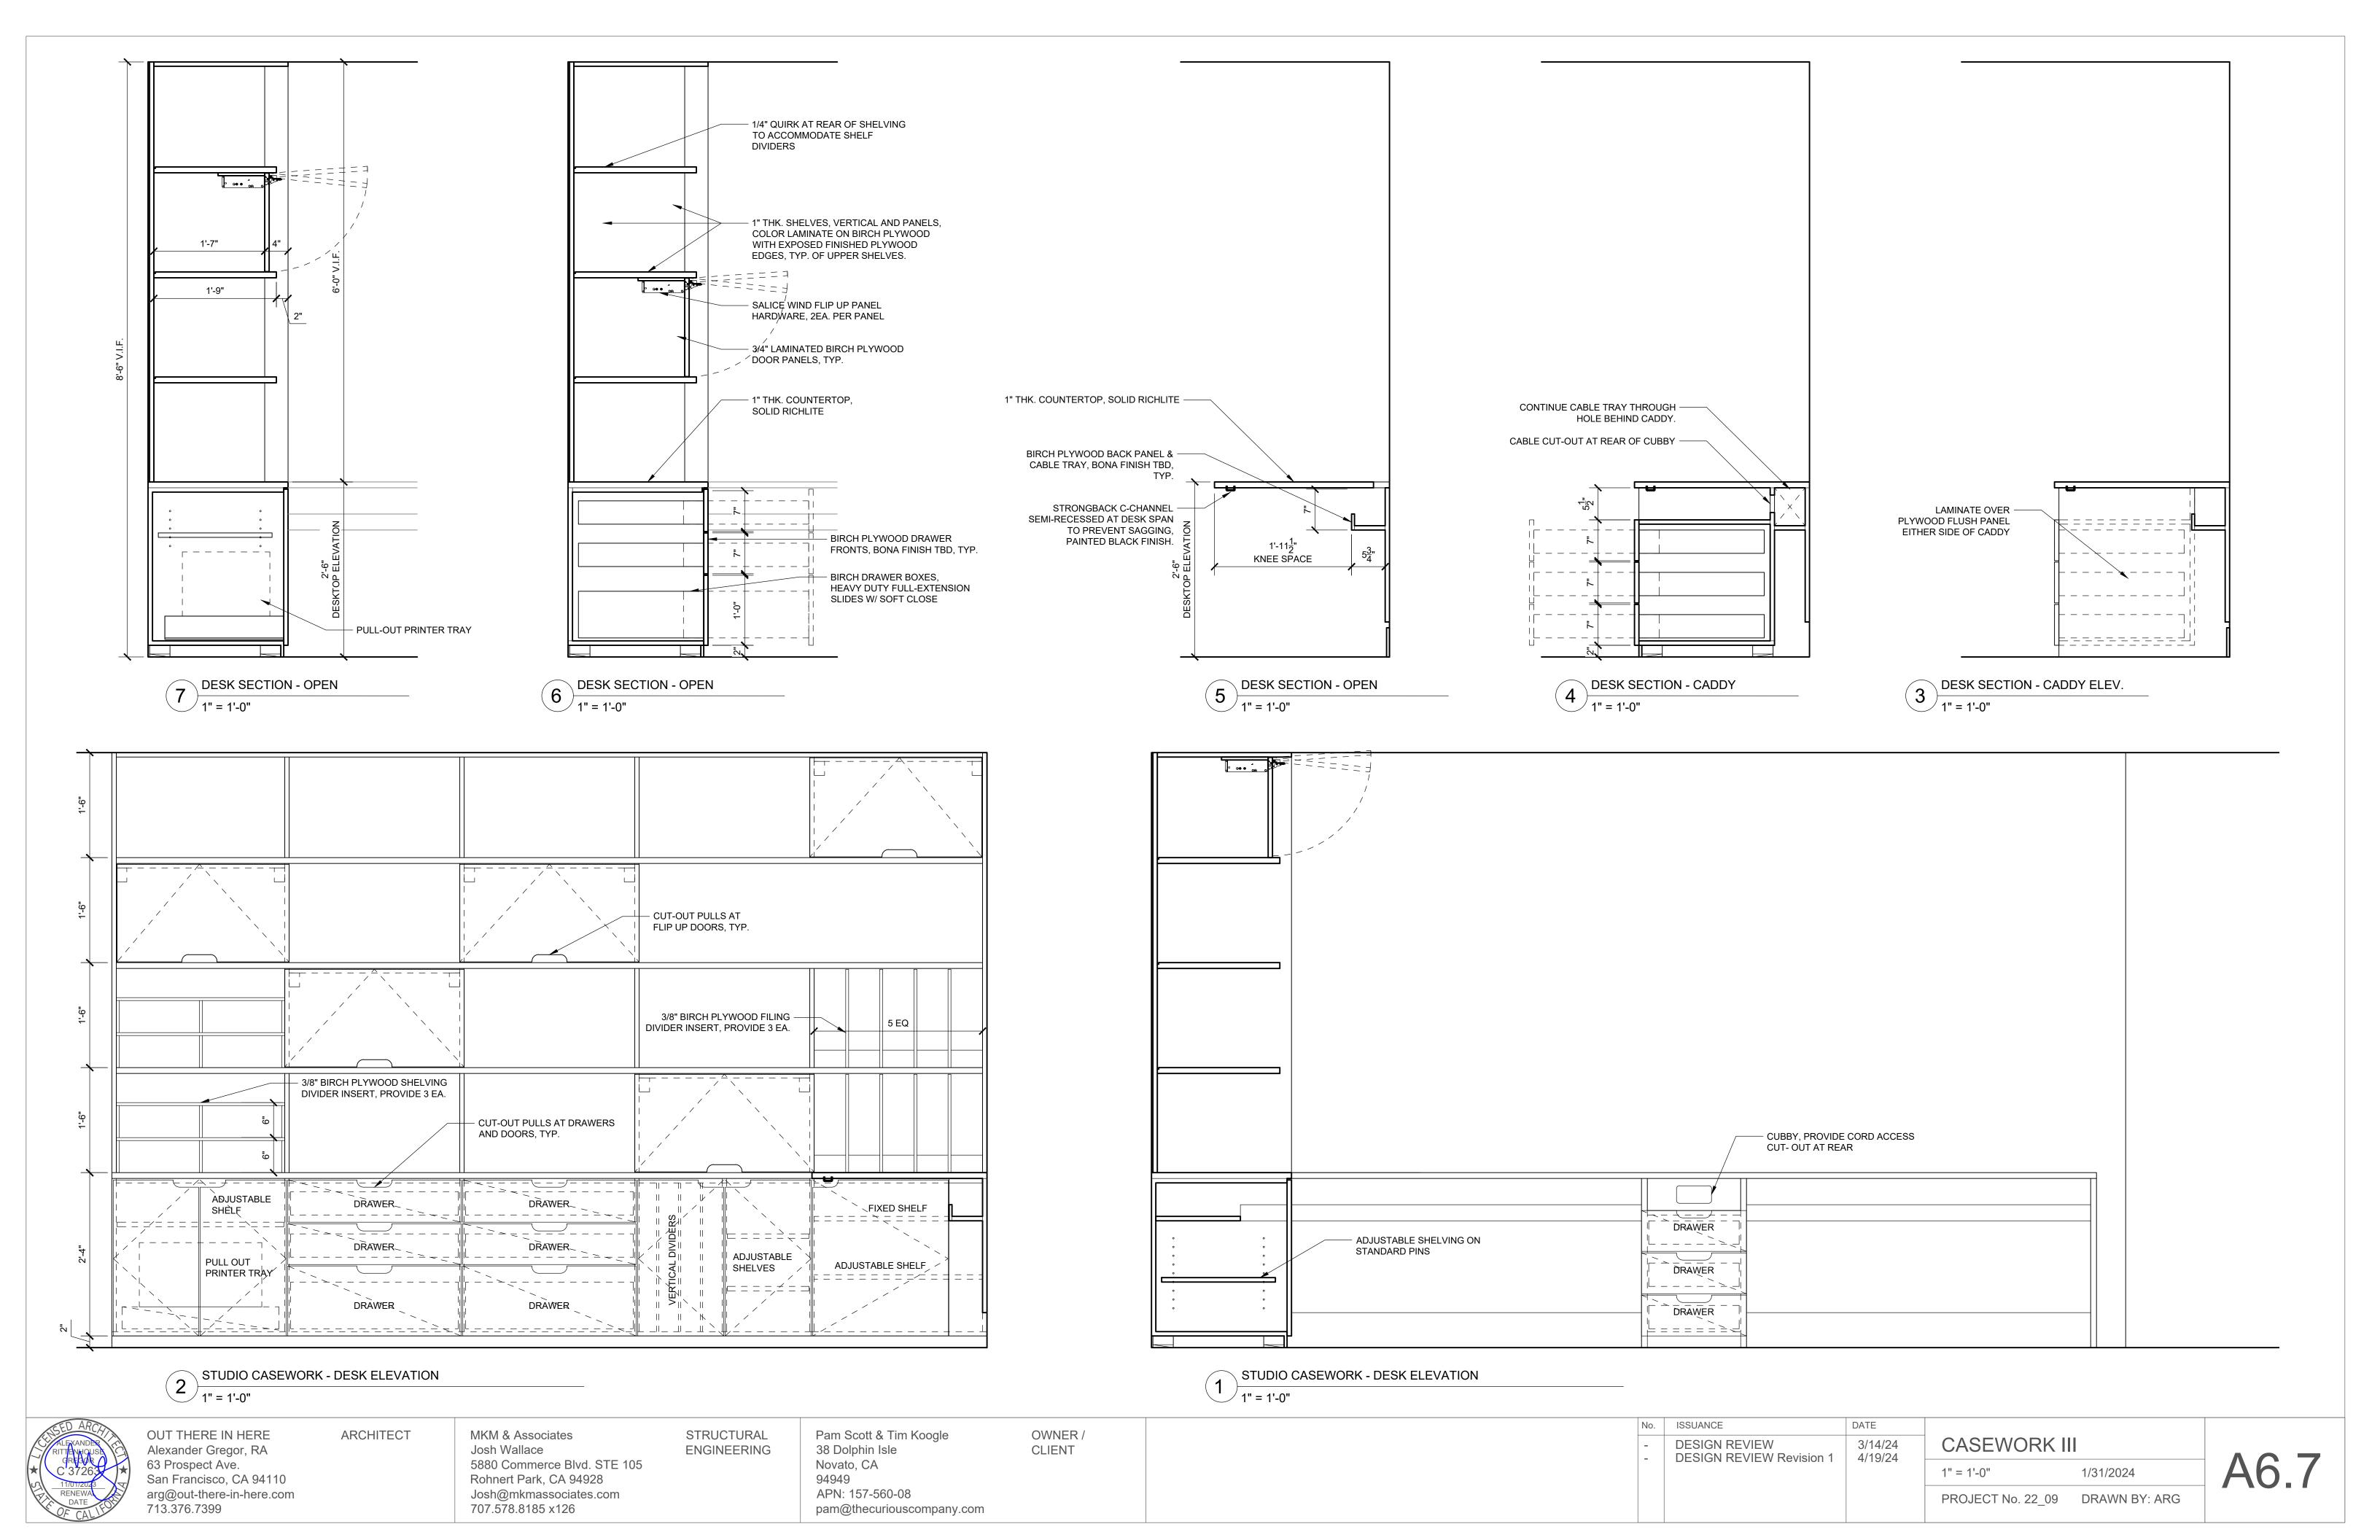

1 KITCHEN TABLE - PLAN
1" = 1'-0"

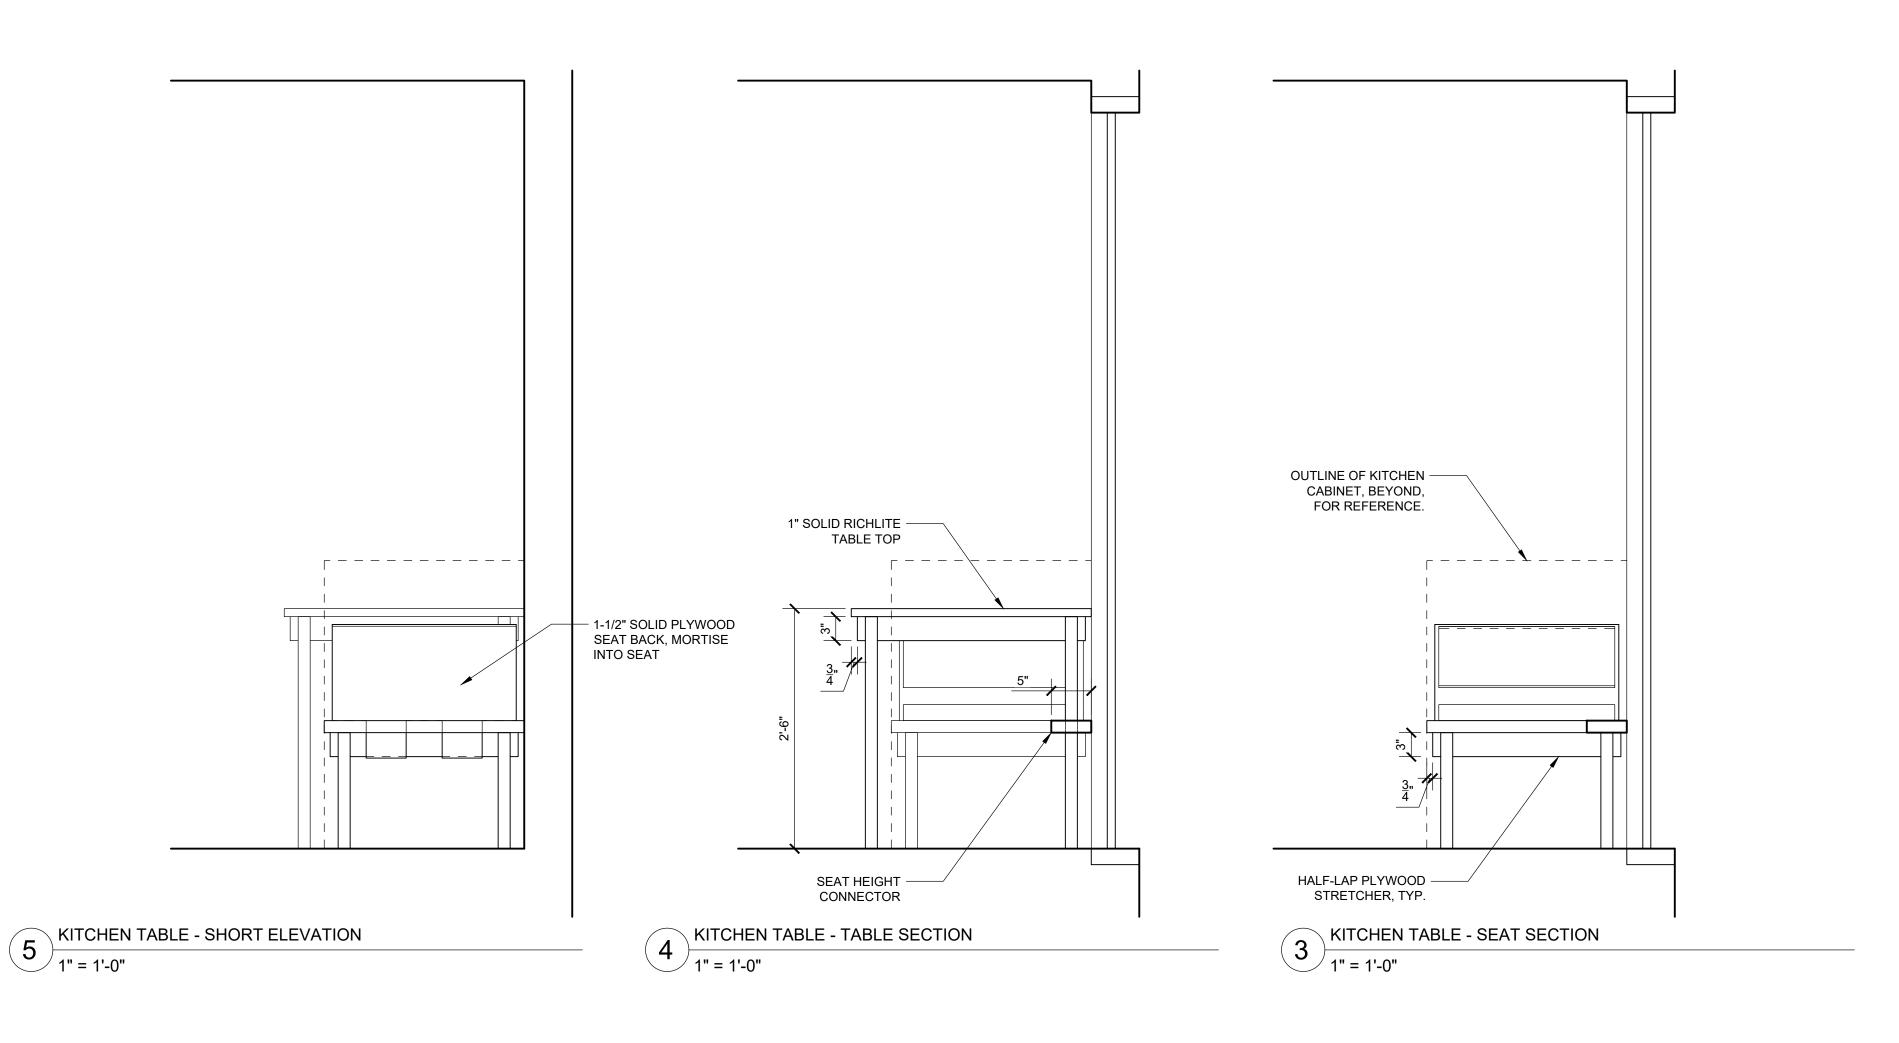

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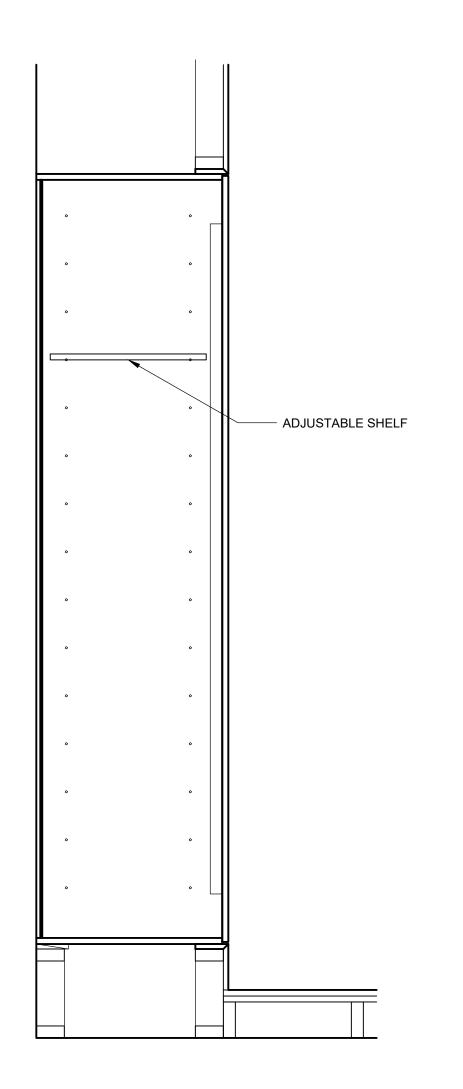
3/14/24 4/19/24 1" = 1'-0"


CASEWORK IV


1" = 1'-0"

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A6.8





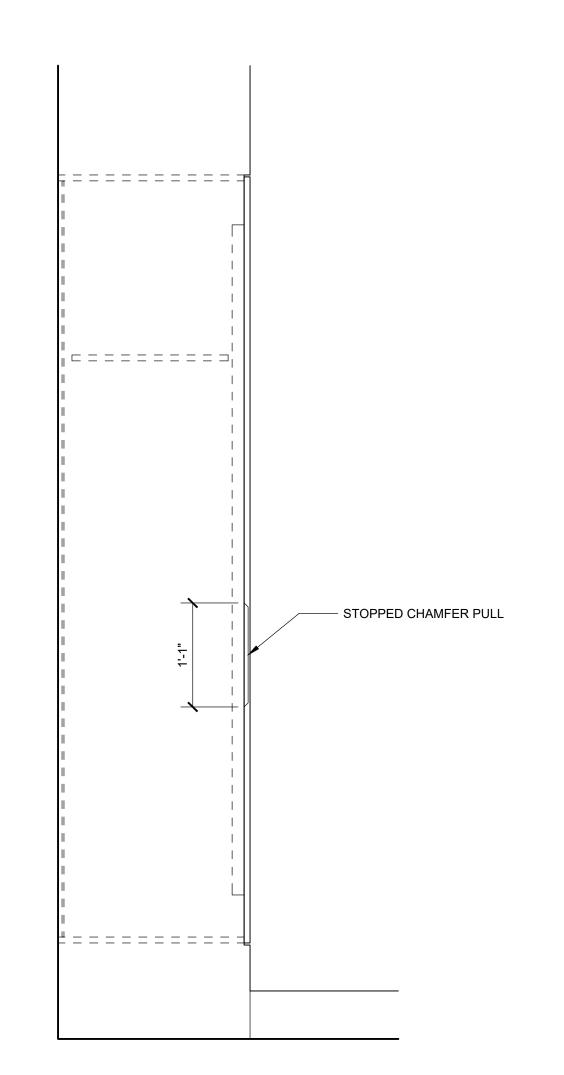


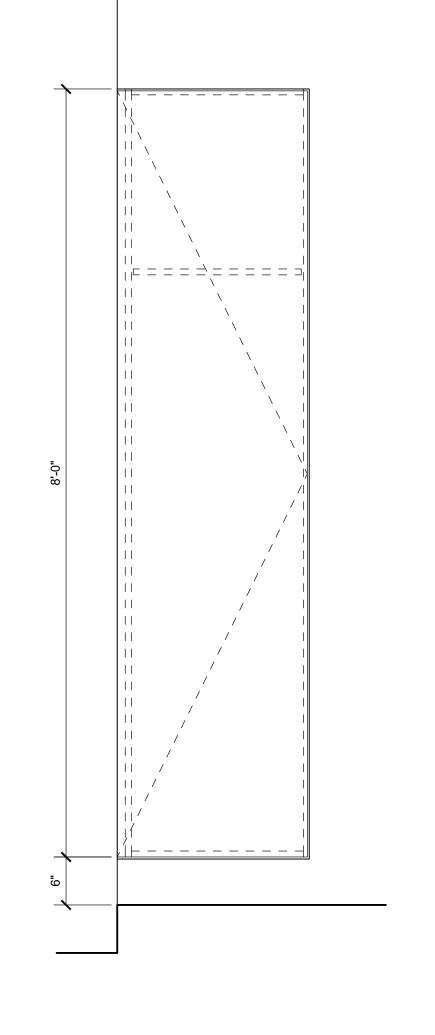TAPE-IN CABINET - SECTION

TAPE-IN CABINET - SIDE ELEVATION


TAPE-IN CABINET - FRONT ELEVATION

1" = 1'-0"

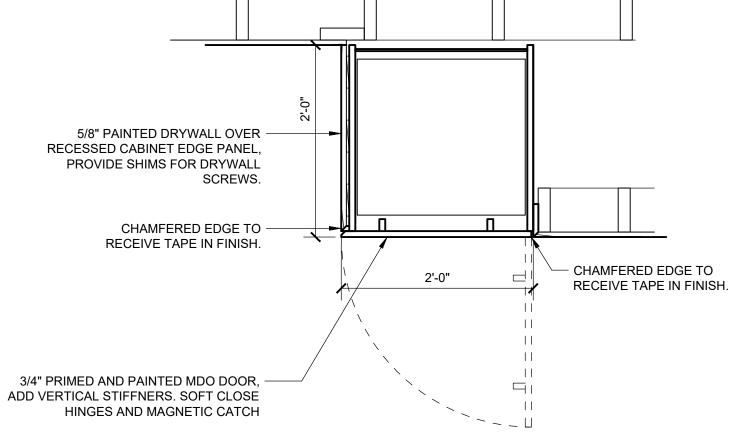

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TAPE-IN CABINET - PLAN

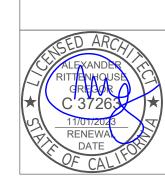

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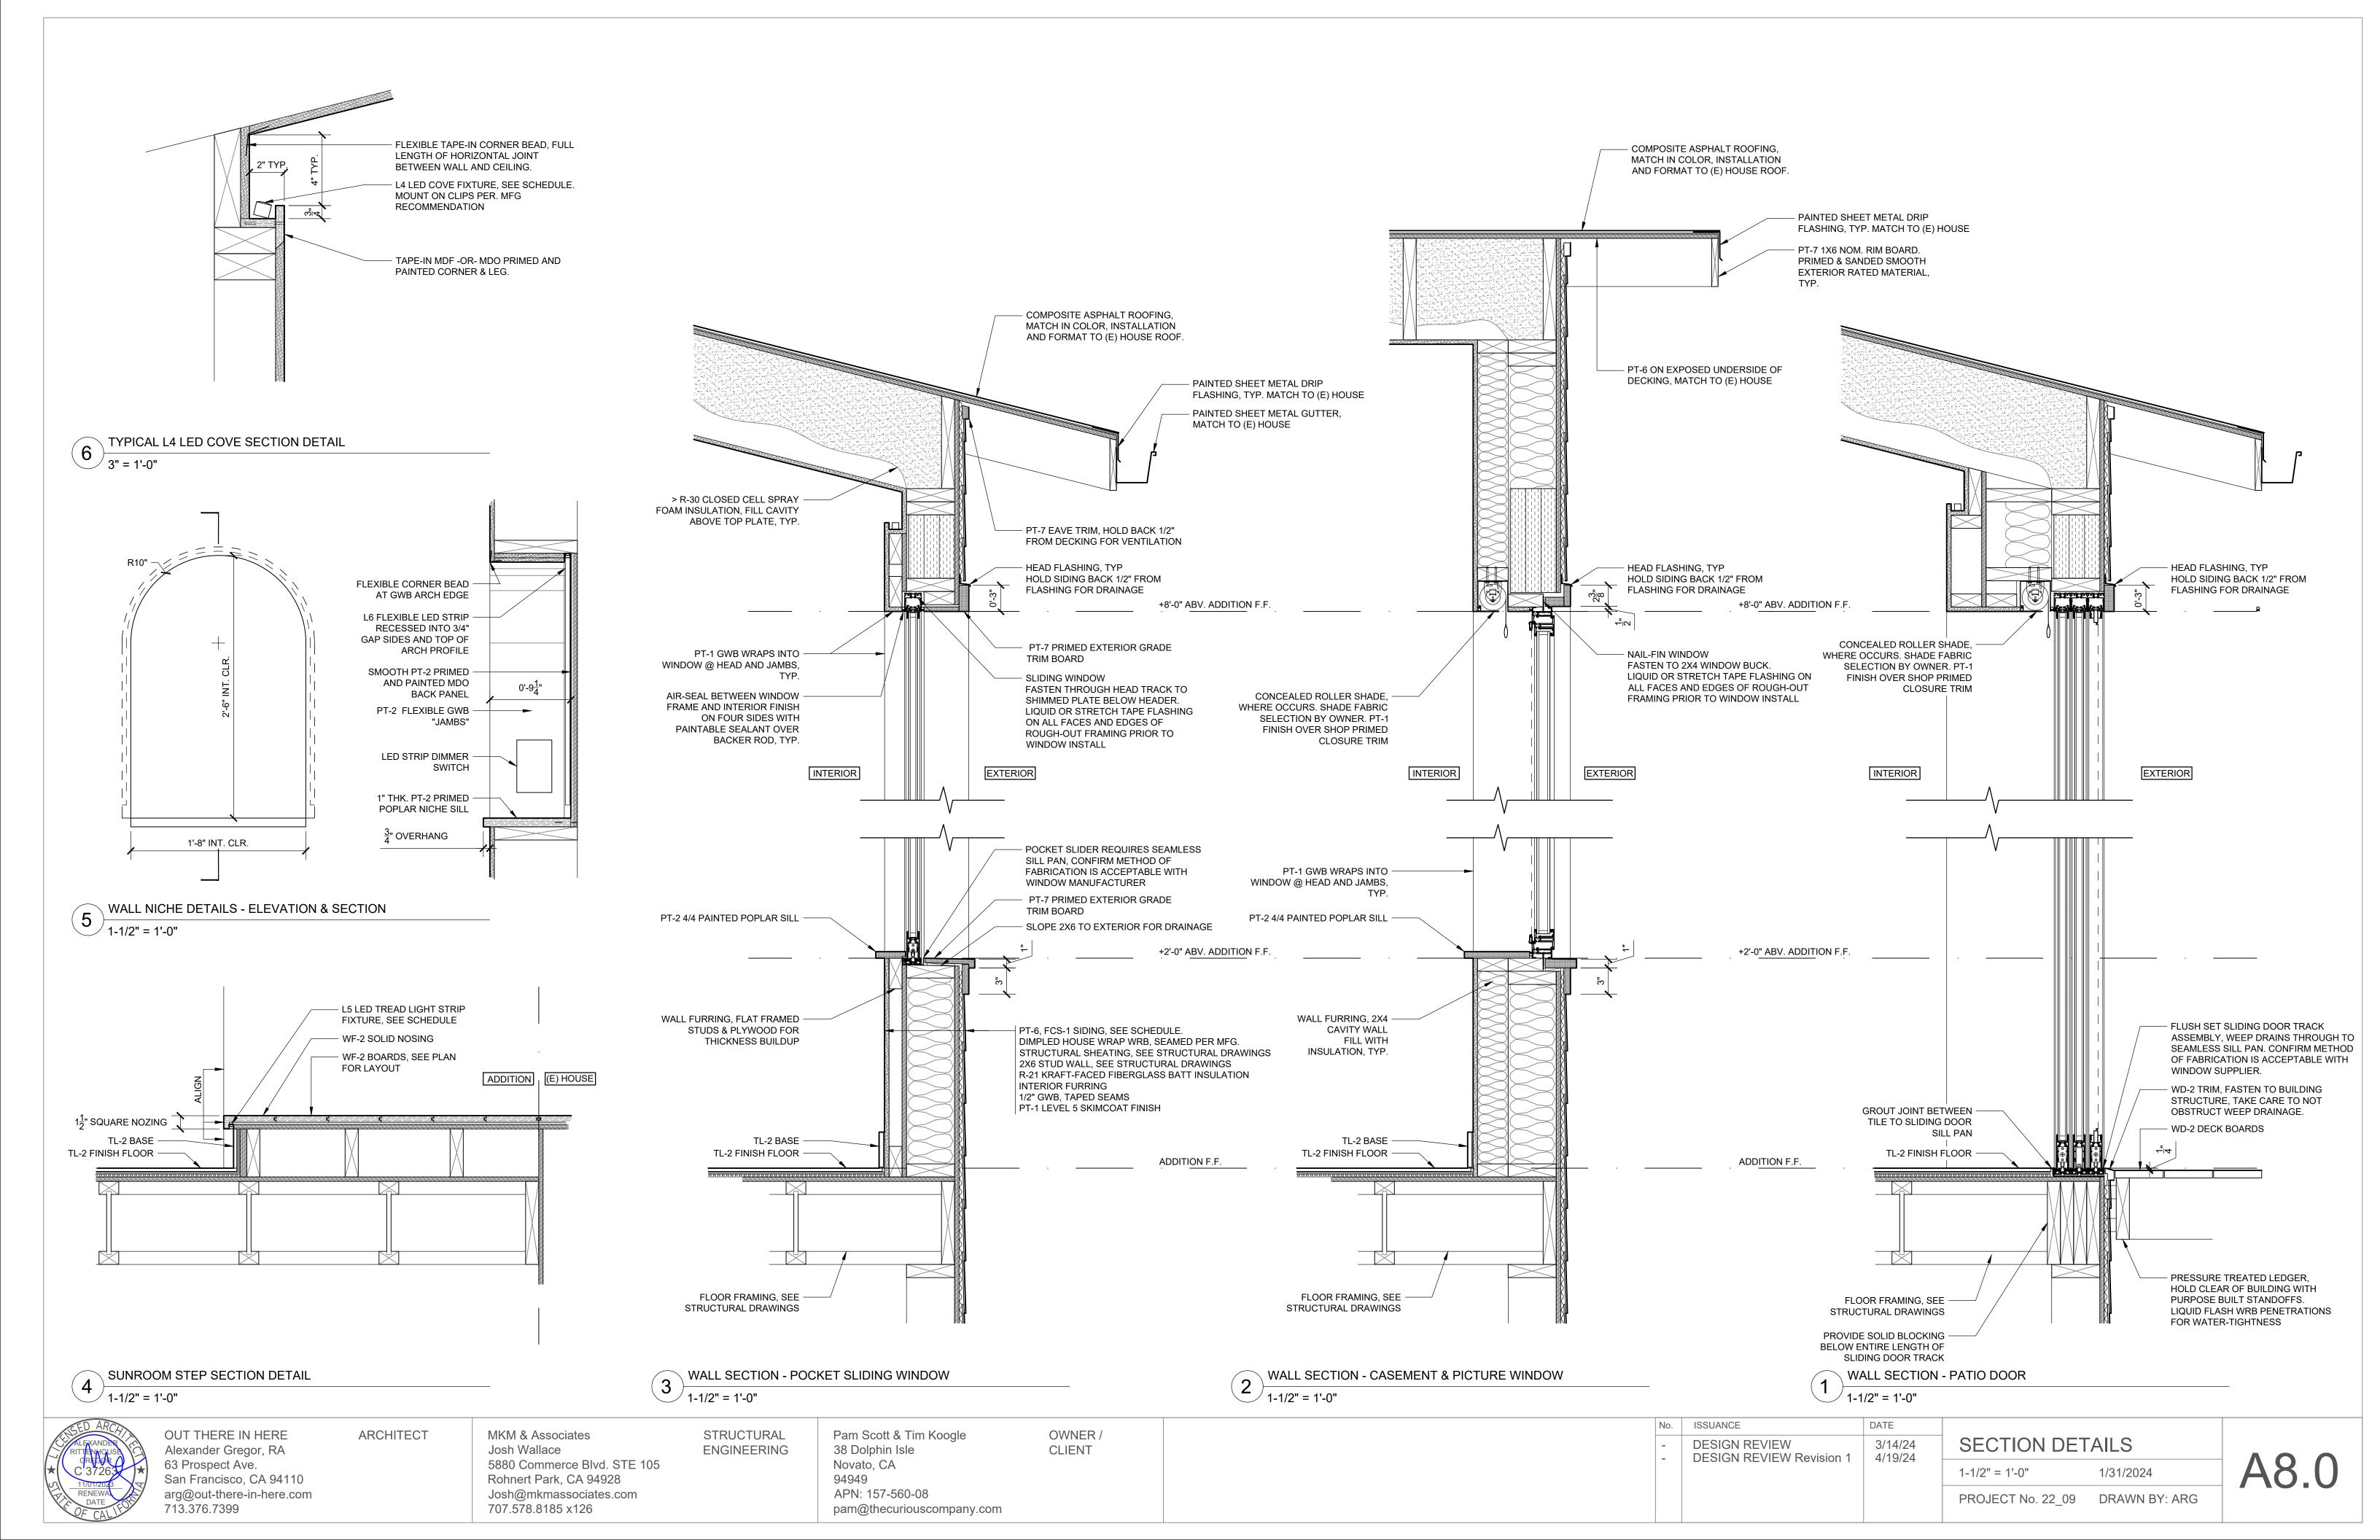
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CASEWORK V 1" = 1'-0"

1/31/2024



WINDOW & DOOR SCHEDULE OPERABLE NOMINAL EXTERIOR INTERIOR OPERATION FRAME DIM. SASH DIM. TAG HARDWARE HARDWARE FINISH ROOM ITEM GLAZING SHGC NOTES FACTOR FINISH WxH FLOOR-TO-CEILING MOTORIZED STAINLESS STEEL, 1" LOW-E IGU. MOTORIZED, CONCEALED ALUMINUM 5'-0" x 7'7" 5'-0" x 2'-4" ≤ 0.48 102 KITCHEN 102.1 FIXED-OVER-AWNING 0.19 AWNING ANODIZED ANODIZED TEMPERED BRUSHED WINDOW (2 EA.) 5'-0" | 1" LOW-E IGU. STAINLESS STEEL, 110 SUNROOM 110.1 ALUMINUM ≤ 0.35 2, 3, 4 SLIDING PATIO DOOR XO SLIDER 10'-0" x 8'-0" 0.22 ARCHETYPE NARROW x 8'-0" TEMPERED ANODIZED ANODIZED BRUSHED 1" LOW-E IGU. STAINLESS STEEL, 110.2 | CASEMENT WINDOW ALUMINUM MANUAL CRANK, FOLDING 3'-0" x 6'-0" ≤ 0.48 3'-0" x 6'-0" CRANK-OUT ANODIZED ANODIZED TEMPERED BRUSHED ALUMINUM DIRECT-GLAZED FIXED 1" LOW-E IGU. 110.3 PICTURE WINDOW 8'-0" x 6'-0" ≤ 0.34 0.24 FIXED WINDOW ANODIZED ANODIZED TEMPERED 1" LOW-E IGU. CLR. STAINLESS STEEL, 110.4 | CASEMENT WINDOW MANUAL CRANK, FOLDING ALUMINUM 3'-0" x 6'-0" ≤ 0.48 3'-0" x 6'-0" CRANK-OUT TEMPERED ANODIZED ANODIZED BRUSHED POCKET SLIDING 1" LOW-E IGU. STAINLESS STEEL, 110.5 ALUMINUM X SLIDING 3'-2" x 6'-0" 3'-2" x 6'-0" ≤ 0.35 0.22 ARCHETYPE NARROW WINDOW TEMPERED ANODIZED ANODIZED BRUSHED

1. PROVIDE "SEA VIEW" STAINLESS STEEL SCREEN WITHIN FRAME AT ALL OPERABLE WINDOWS

2. PROVIDE FULL SIZE SLIDING SCREEN AT SLIDING DOOR

3. PROVIDE FLUSH MOUNTED INTERIOR MANUAL ROLLER SHADE, LUTRON OR SIM. 4. PROVIDE CONTINUOUS SILL PAN BELOW WINDOW/DOOR AT THE RECOMMENDATION OF THE

MANUFACTURER TO BE FLASHED IN ON ALL SIDES.

LIGI	LIGHT FIXTURE SCHEDULE								
TAG	ITEM	DESCRIPTION	MANUFACTU RER	MAKE & MODEL NUMBER	UMBER WATTAGE CO		FINISH	NOTES	
L1	RECESSED DOWNLIGHT	3" ADJUSTABLE LED DOWNLIGHT	HALO / COOPER	HLA305FL9271EMW	8.6W 2700K		WHITE	JA-8 LED	
L2	DECORATIVE INTERIOR SCONCE	UP - DOWN SCONCE W/ GLASS SHADES	IN COMMON WITH	CHROMATIC GLASS UP-DOWN SCONCE, HARDWIRE	20w	2700K	TBD		
L3	EXTERIOR SCONCE	DOWN EXTERIOR SCONCE	IN COMMON WITH	PAINTED STEEL DOWN SCONCE, HARDWIRE	20w	2700K	WHITE (BONE)		
L4	COVE UP-LIGHT	LED STRIP W/ ASYMMETRICAL LENS	Q-TRAN	OP2SW-9.0-27-DRY-FT-S1-B W-CLS-WH-WL2-SST-WH-	9W / FT	2700K	WHITE	JA-8 LED	
L5	TREAD LIGHT	LOW PROFILE LED STRIP	Q-TRAN	TH1SW-3.0-27-DRY-STD-DF-S 1-BW-CLS-WH-CL2-SST-ST-	3W / FT	2700K	WHITE	JA-8 LED	
L6	NICHE COVE	FLEXIBLE LED STRIP	Q-TRAN	NEXUS-SW-WSC-DRY-27-1.0- ENC/TL-S1-BW-N/A-WH-	1W / FT	2700K	WHITE	JA-8 LED	
CF	CEILING FAN	NON-ILLUMINATED AIRFOIL CEILING FAN	BIG-ASS FANS	MK-HK4-042406A259F259G10 I20		-	WHITE		

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FINISF	I MATERIAL SCHE	DULE			_			
TAG	ITEM	DESCRIPTION	MANUFACTURER	STYLE	COLOR / FINISH	DMENSION	INSTALLATION	NOTES
TL-1 (E)	KITCHEN FLOOR TILE - EXISTING	STONE-EFFECT FLOOR TILE, RECTANGULAR, ASHLAR PATTERN	-UNKONWN-	- UNKNOWN -	GRAY SLATE EFFECT	12X24	ASHLAR SET	
TL-2	SUNROOM FLOOR TILE	STONE-EFFECT FLOOR TILE, SQUARE, GRID PATTERN	LEA CERAMICHE	BASALTINA NATURALE 24X24 RECTIFIED	"NATURALE"	24"x24" 11mm THK.	SQUARE SET, QUARTER TURN, SEE FLOOR PLAN FOR JOINT ALIGNMENTS. INSTALL OVER DE-COUPLING MAT DITRA OR SIM. TO DISCOURAGE CRACKING.	4" HIGH TL-2 BASE AT TL-2 FLOOR PERIMITER, TYP.
FL-1 (E)	WIDE PLANK OAK FLOOR - EXISTING	ENGINEERED T&G OAK FLOORING		MEDIUM WHITE PRE-FINISH, LIGHT WIRE BRUSH, MICRO V-GROOVE JOINTS	50% WHITE	7.5" WIDTHS, V.I.F.		
FL-2	WIDE PLANK OAK FLOOR	ENGINEERED T&G OAK FLOORING		SEEK AS CLOSE A MATCH AS POSSIBLE TO FL-1	50% WHITE	7.5" WIDTHS, V.I.F.	ADHESIVE AND CONCEALED FASTENING TO SUBFLOOR, TIGHT JOINTS.	NOTE SOLID NOSING AT ELEVATION CHANGE BETWEEN STUDIO AND SUNROOM
WD-1	SOLID BIRCH	SOLID KILN DRIED BIRCH LUMBER FOR FURNITURE		SELECT CLEAR, QUARTERED BIRCH, S4S, SANDED SMOOTH	BONA TRAFFIC HD	6/4 STOCK	CONCEALED FASTENING W/ DOMINOS, TYP.	
WD-2	SOLID IPE	SOLID IPE DECKING FOR EXTERIOR		SELECT CLEAR, PLAIN SAWN IPE, S4S, SANDED SMOOTH	EXTERIOR DECK OIL	1X6 NOMINAL	HIDDEN FASTENING PER MFGOR- CAPPED TRI- HEAD DECK SCREWS	
WD-3	BIRCH PLYWOOD	MARINE GRADE "BALTIC BIRCH" VENEER-CORE PLYWOOD		B/BB GRADE: NO KNOTS, PATCHES OR DEFECTS ON PRESENTATION SURFACE.	BONA TRAFFIC HD	3/4 & 1-1/2 PANEL	CONCEALED FASTENING W/ DOMINOS, TYP.	
PL-1	LAMINATE FACE BIRCH PLYWD	HIGH PRESSURE LAMINATE OVER BIRCH PLY CORE, EXPOSED CORE ON EDGES	FORMICA	1485-58 MATTE FINISH HPL BB/BB GRADE CORE	CHROME YELLOW	3/4 PANEL		
GWB	GYPSUM WALL BOARD	1/2" PAPER FACED GYPSUM BOARD	USG			1/2" THK.	LEVEL 5 SMOOTH, TAPED AND SKIMCOAT FINISH, TYP.	
FCS-1	FIBER CEMENT SIDING	PAINTED SMOOTH PLANK LAP SIDING	JAMES HARDIE	HARDIE PLANK - SMOOTH	PRIMED	8.25" x 144" x 0.312" 7" EXPOSURE, TYP.	MATCH BUILDING TYPICAL SIDING IN SIZE, SPACING, FASTENING AND FINISH	
PT-1	INTERIOR WALL PAINT	WHITE PAINT, MATTE FINISH	SHERWIN WILLIAMS		TBD			
PT-2	INTERIOR CEILING PAINT	WHITE PAINT, MATTE FINISH	SHERWIN WILLIAMS		TBD			
PT-3	INTERIOR TRIM PAINT	WHITE PAINT, EGGSHELL FINISH	SHERWIN WILLIAMS		TBD			
PT-4	- NOT USED -							
PT-5	- NOT USED -							
PT-6	EXTERIOR SIDING PAINT	GRAY PAINT, EGGSHELL FINISH	SHERWIN WILLIAMS		SW6277 SPECIAL GRAY	′		
PT-7	EXTERIOR TRIM PAINT	WHITE PAINT, EGGSHELL FINISH	SHERWIN WILLIAMS		SW6203 SPARE WHITE			

ISSUANCE DATE SCHEDULES 3/14/24 4/19/24 1/31/2024 1/2" = 1'-0" PROJECT No. 22_09 DRAWN BY: ARG

MATERIAL NOTES

CGBC 4.504.5

POSTCONSUMER OR PRECONSUMER RECYCLED CONTENT VALUE MATERIALS ARE TO BE USED ON THE PROJECT, NOT LESS THAN A

ALL FINISH MATERIALS, INCLUDING BUT NOT LIMITED TO: RESILIENT FLOORING, CARPET, PATRICLEBOARD, MDF, PLYWOOD, PAINTS,

10 PERCENT RECYCLED CONTENT VALUE. CGBC A4.405.3

STAINS AND OTHER COATINGS, ADHESIVES, SEALANTS AND

CAULKS, AS CALLED OUT IN CALIFORNIA GREEN BUILDING CODE CH4.5 ENVIRONMENTAL QUALITY, SHALL BE COMPLIANT WITH VOC

AND OTHER TOXIC COMPOUND LIMITS AS SET BY CALIFORNIA

AEROSOL PAINTS AND COATINGS SHALL ADDITIONALLY BE

5. 80% OF FLOOR AREA RECIEVING RESILIENT FLOORING SHALL

COMPLY WITH SPECIFIED VOC CRITERIA. CGBG 4.504.4 6. PARTICLEBOARD, MEDIUM DENSITY FIBERBOARD (MDF), AND HARDWOOD PLYWOOD USED IN INTERIOR FINISHING SYSTEMS SHALL COMPLY WITH LOW FORMALDEHYDE EMISSION STANDARDS.

DOCUMENTATION FOR MATERIALS SHALL BE SUBMITTED PRIOR TO

THE PURCHASE AND/OR INSTALLATION OF SUCH MATERIALS FOR

COMPLIANT WITH PRODUCT WEIGHTED MIR LIMITS FOR ROC AND

INSTALL VOC COMPLIANT RESILIENT FLOORING SYSTEMS. 90% OF FLOOR AREA RECEIVING RESILIENT FLOORING SHALL COMPLY WITH THE VOC-EMISSION LIMITS ESTABLISHED IN CGBC A4.504.2 8. THERMAL INSULATION INSTALLED IN THE BUILDING SHALL BE IN

GREEN BUILDING CODE CH4 504.2.1 - 3

RECORD AND REVIEW, CGBC 4.504.2.4

OTHER TOXIC COMPOUNDS. CGBC 4.504.2.3

COMPLIANCE WITH VOC LIMITS. CGBC A4.504.3

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DESIGN REVIEW DESIGN REVIEW Revision 1



EXTERIOR MATERIAL - REFERENCE IMAGES

WD-2 IPE DECKING



ANODIZED ALUM. WINDOW FRAMES, PT-6 FCS-1 GRAY PAINTED FIBER TYP OF ALL NEW WINDOWS CEMENT SIDING



PT-6 FCS-1 GRAY PAINTED FIB CEMENT SIDING SHERWIN WILLIAMS SW6277 SPECIAL GRAY





PT-7 WHITE PAINTED TRIM SHERWIN WILLIAMS SW6203 SPARE WHITE



L3 EXTERIOR SCONCE - "BONE" WHITE FINISH $7\frac{1}{2}$ " TALL x $4\frac{7}{8}$ " WIDTH

EXTERIOR LIGHTING - SCONCES

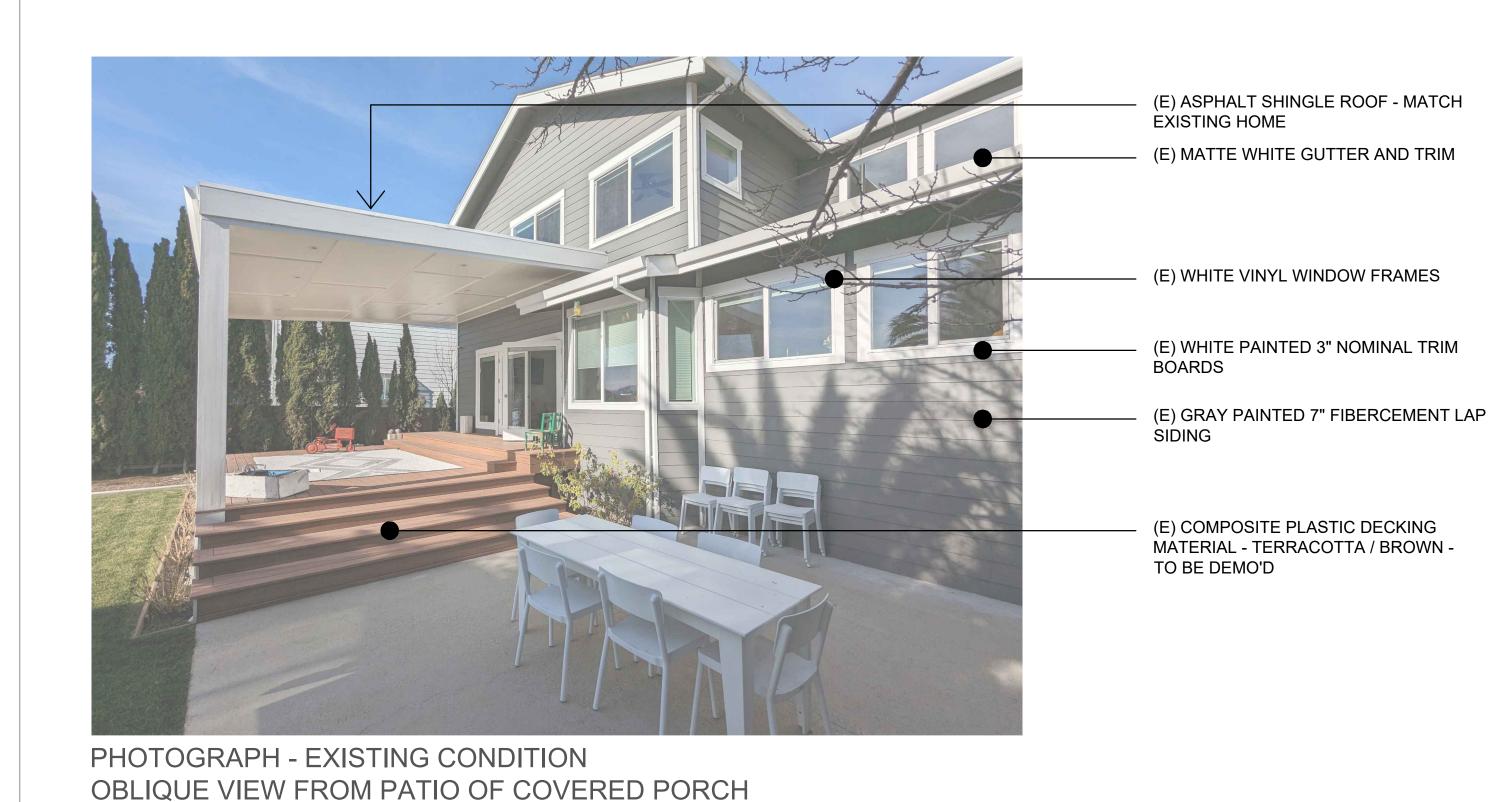

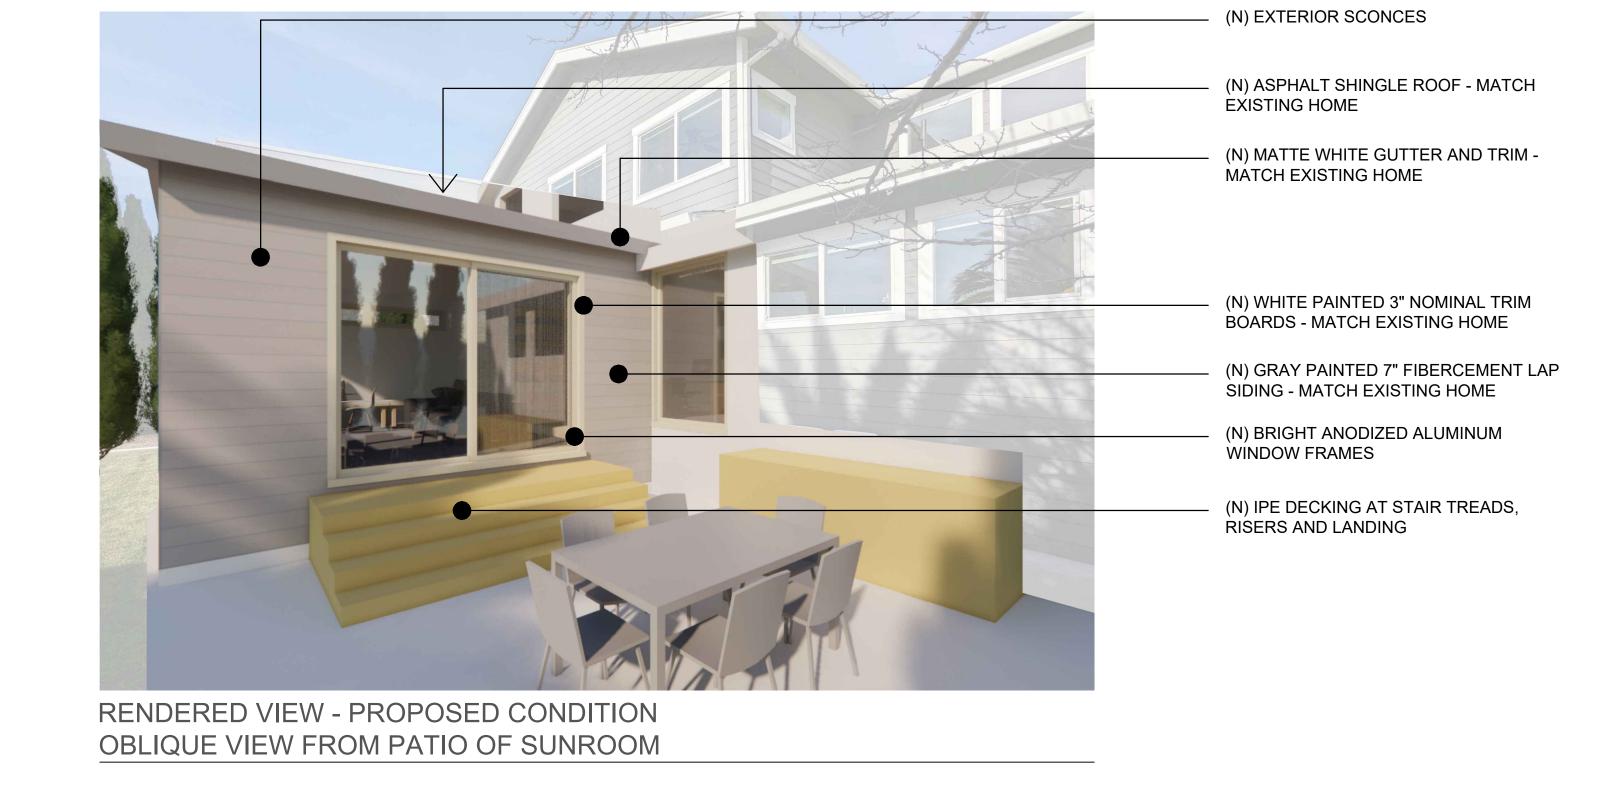



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24 EXTERIOR MATERIALS

N.T.S.

PROJECT No. 22_09 DRAWN BY: ARG

1/31/2024

A9.1