

SEADRIFT PROPERTY OWNERS DATA

Lot Size 11,248 sq. ft.
(25' beyond rear setback)

FAR 28%

Roof Volume Calculation:
Max. allowed volume over (25.29') 5,133 cu. ft.
(= 50% of building Area x 3'-0")
Proposed volume over (25.29'): 663 cu. ft.

SEPTIC






Net Square Footage: 2795
System design: 2800

VERTICAL DATUM

All Vertical Datum Called out on all plans and elevations as MLLW and (NAVD-88).

Conversion:
NAVD-88 = MLLW + 0.83
NAVD-88 = NGVD-29 + 2.69'
Example: 9.17 (10)

LANDSCAPE LEGEND

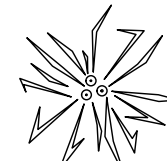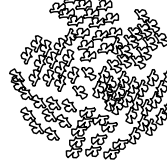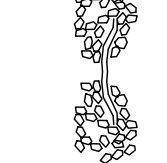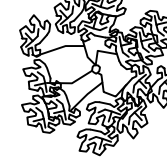-  **P** - Pennisetum (Fountain grass) 5 gal (grass 48" spacing)
-  **L** - Lavandula stoechas (Spanish lavender) 5 gal (shrub 48" spacing)
-  **J** - Trachelospermum Jasminoides (Star Jasmine) 3 gal (train as a vine 36" spacing)
-  **R** - Rosa (Cécile Brünner Rose) 3 gal (train as a vine 36" spacing)
-  **A** - Agave (Blue Flame) 5 gal

OWNER

Mr. Pete Jensen
Mrs. Danielle Jensen
43 Dipsea Road
Stinson Beach, CA 94970

ARCHITECT OF RECORD

Steve Wisenbaker AIA
300 Tamal Plaza, #200
Corte Madera, CA 94925

ZONING AND PROJECT DATA

AP # 195-090-43
Zoning: C-RSPS-4.39
FEMA Zone: X

Total Lot Size 11,248 sq. ft.
Dry Lot Size 10,083 sq. ft.

Latitude 37°54'23.5"N
Longitude 122°39'20.3"W

	EXISTING	PROPOSED
FLOOR AREA IN SQUARE FEET:	16%	28%
Conditioned floor area	1835	3102
Garage	276	320
Garage Credit	(540)	(540)
Total floor area	1835	3102
Total Building area	2111	3422

COVERAGE AND IMPERVIOUS SURFACE

Buildings	4118
Patios and Walkways	1340
TOTAL	5458

CUT AND FILL

Total cut	0 cu yd
Total fill	0 cu yd
Total off haul	0 cu yd

HEIGHT

Max Elevations - Max Above Grade - PARKING -	2 Resident	1 Guest	14'-7"
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STORY POLES


1. 21.25' ±9'-9" FROM (E) GRADE
2. 21.25' ±10'-0" FROM (E) GRADE
3. 21.25' ±10'-0" FROM (E) GRADE
4. 27.25' *VIF FROM (E) ROOF*
5. 21.25' *VIF FROM (E) ROOF*
6. 23.75' *VIF FROM (E) ROOF*
7. 23.75' *VIF FROM (E) ROOF*
8. 23.75' *VIF FROM (E) ROOF*
9. 23.75' *VIF FROM (E) ROOF*
10. 21.25' ±9'-6" FROM (E) GRADE
11. 27.25' 15'-9" FROM (E) GRADE
12. 21.25' ±9'-9" FROM (E) GRADE
13. 21.25' *VIF TO AVOID (E) HOT TUB*
14. 27.25' ±16'-3" FROM (E) GRADE
15. 21.25' ±8'-6" FROM (E) GRADE
16. 23.75' *VIF FROM (E) ROOF*
17. 23.75' *VIF FROM (E) ROOF*
18. 21.25' *VIF FROM (E) ROOF*
19. 27.25' *VIF FROM (E) ROOF*
20. 21.25' ±10'-3" FROM (E) GRADE
21. 21.25' ±10'-3" FROM (E) GRADE
22. 21.25' ±10'-3" FROM (E) GRADE

INDEX TO DRAWINGS

- ARCHITECTURAL:**
1. Cover and Site Plan
 2. Floor Plan
 3. Elevations, Fence detail and elevation
 4. Elevations
 5. Sections
 6. Sections
 7. Existing Floor Plan
 8. Existing Elevations
 9. Existing Sections

- CIVIL:**
- C1. Survey

- SEPTIC:**
1. Layout
 2. Details

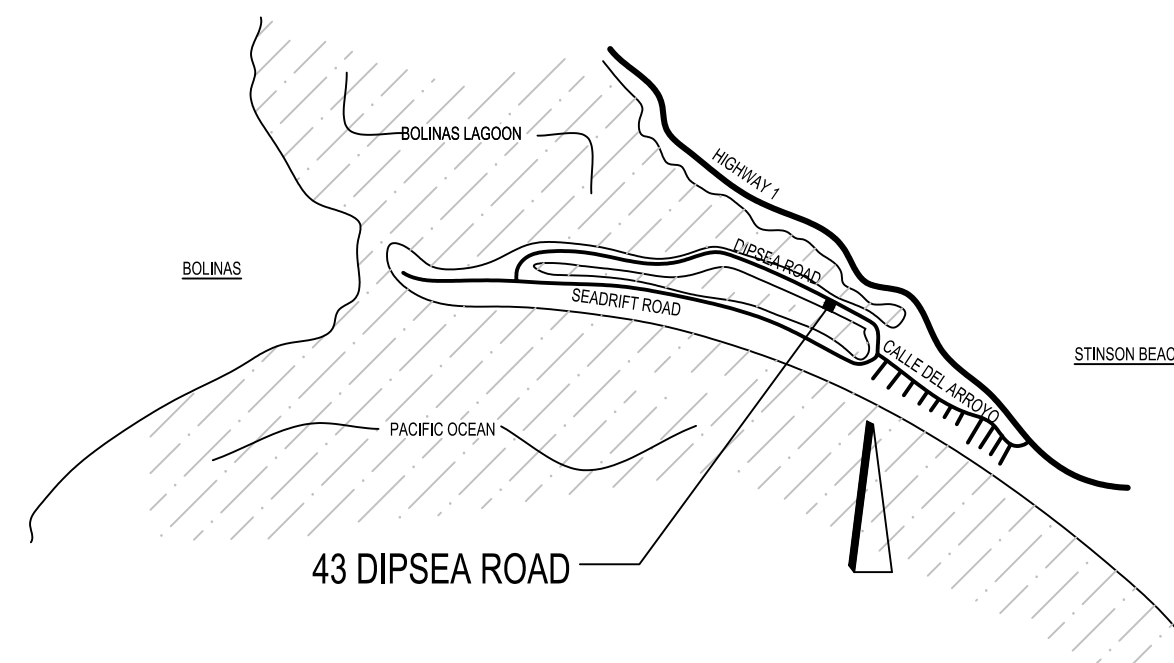

VICINITY MAP

NO SCALE


FROM HIGHWAY ONE TURN ONTO 'CALLE DEL ARROYO.' PASS THROUGH THE SECURITY GATE AND TURN RIGHT ONTO 'DIPSEA ROAD.' 43 DIPSEA WILL BE ON YOUR LEFT.

LIGHTING LEGEND

- WALL MOUNTED SCONCE: LED, Aurora Light "Telluride" (HWM16-1) 12V 3000K, Copper
- RECESSED CEILING: LED, Nora "Iolite" 5" (NJO-4RG), Black baffle
- ▣ LOW LEVEL PATH LIGHTS: LED, Aurora Light "Vertex" (LSR5-L) 12V 3000K, Copper

DRAINAGE LEGEND

- ALL LEADERS TERMINATE AT SPLASH BLOCKS.
- SLOPE ALL GRADES AWAY FROM STRUCTURE, 5% FOR THE FIRST 10'-0"

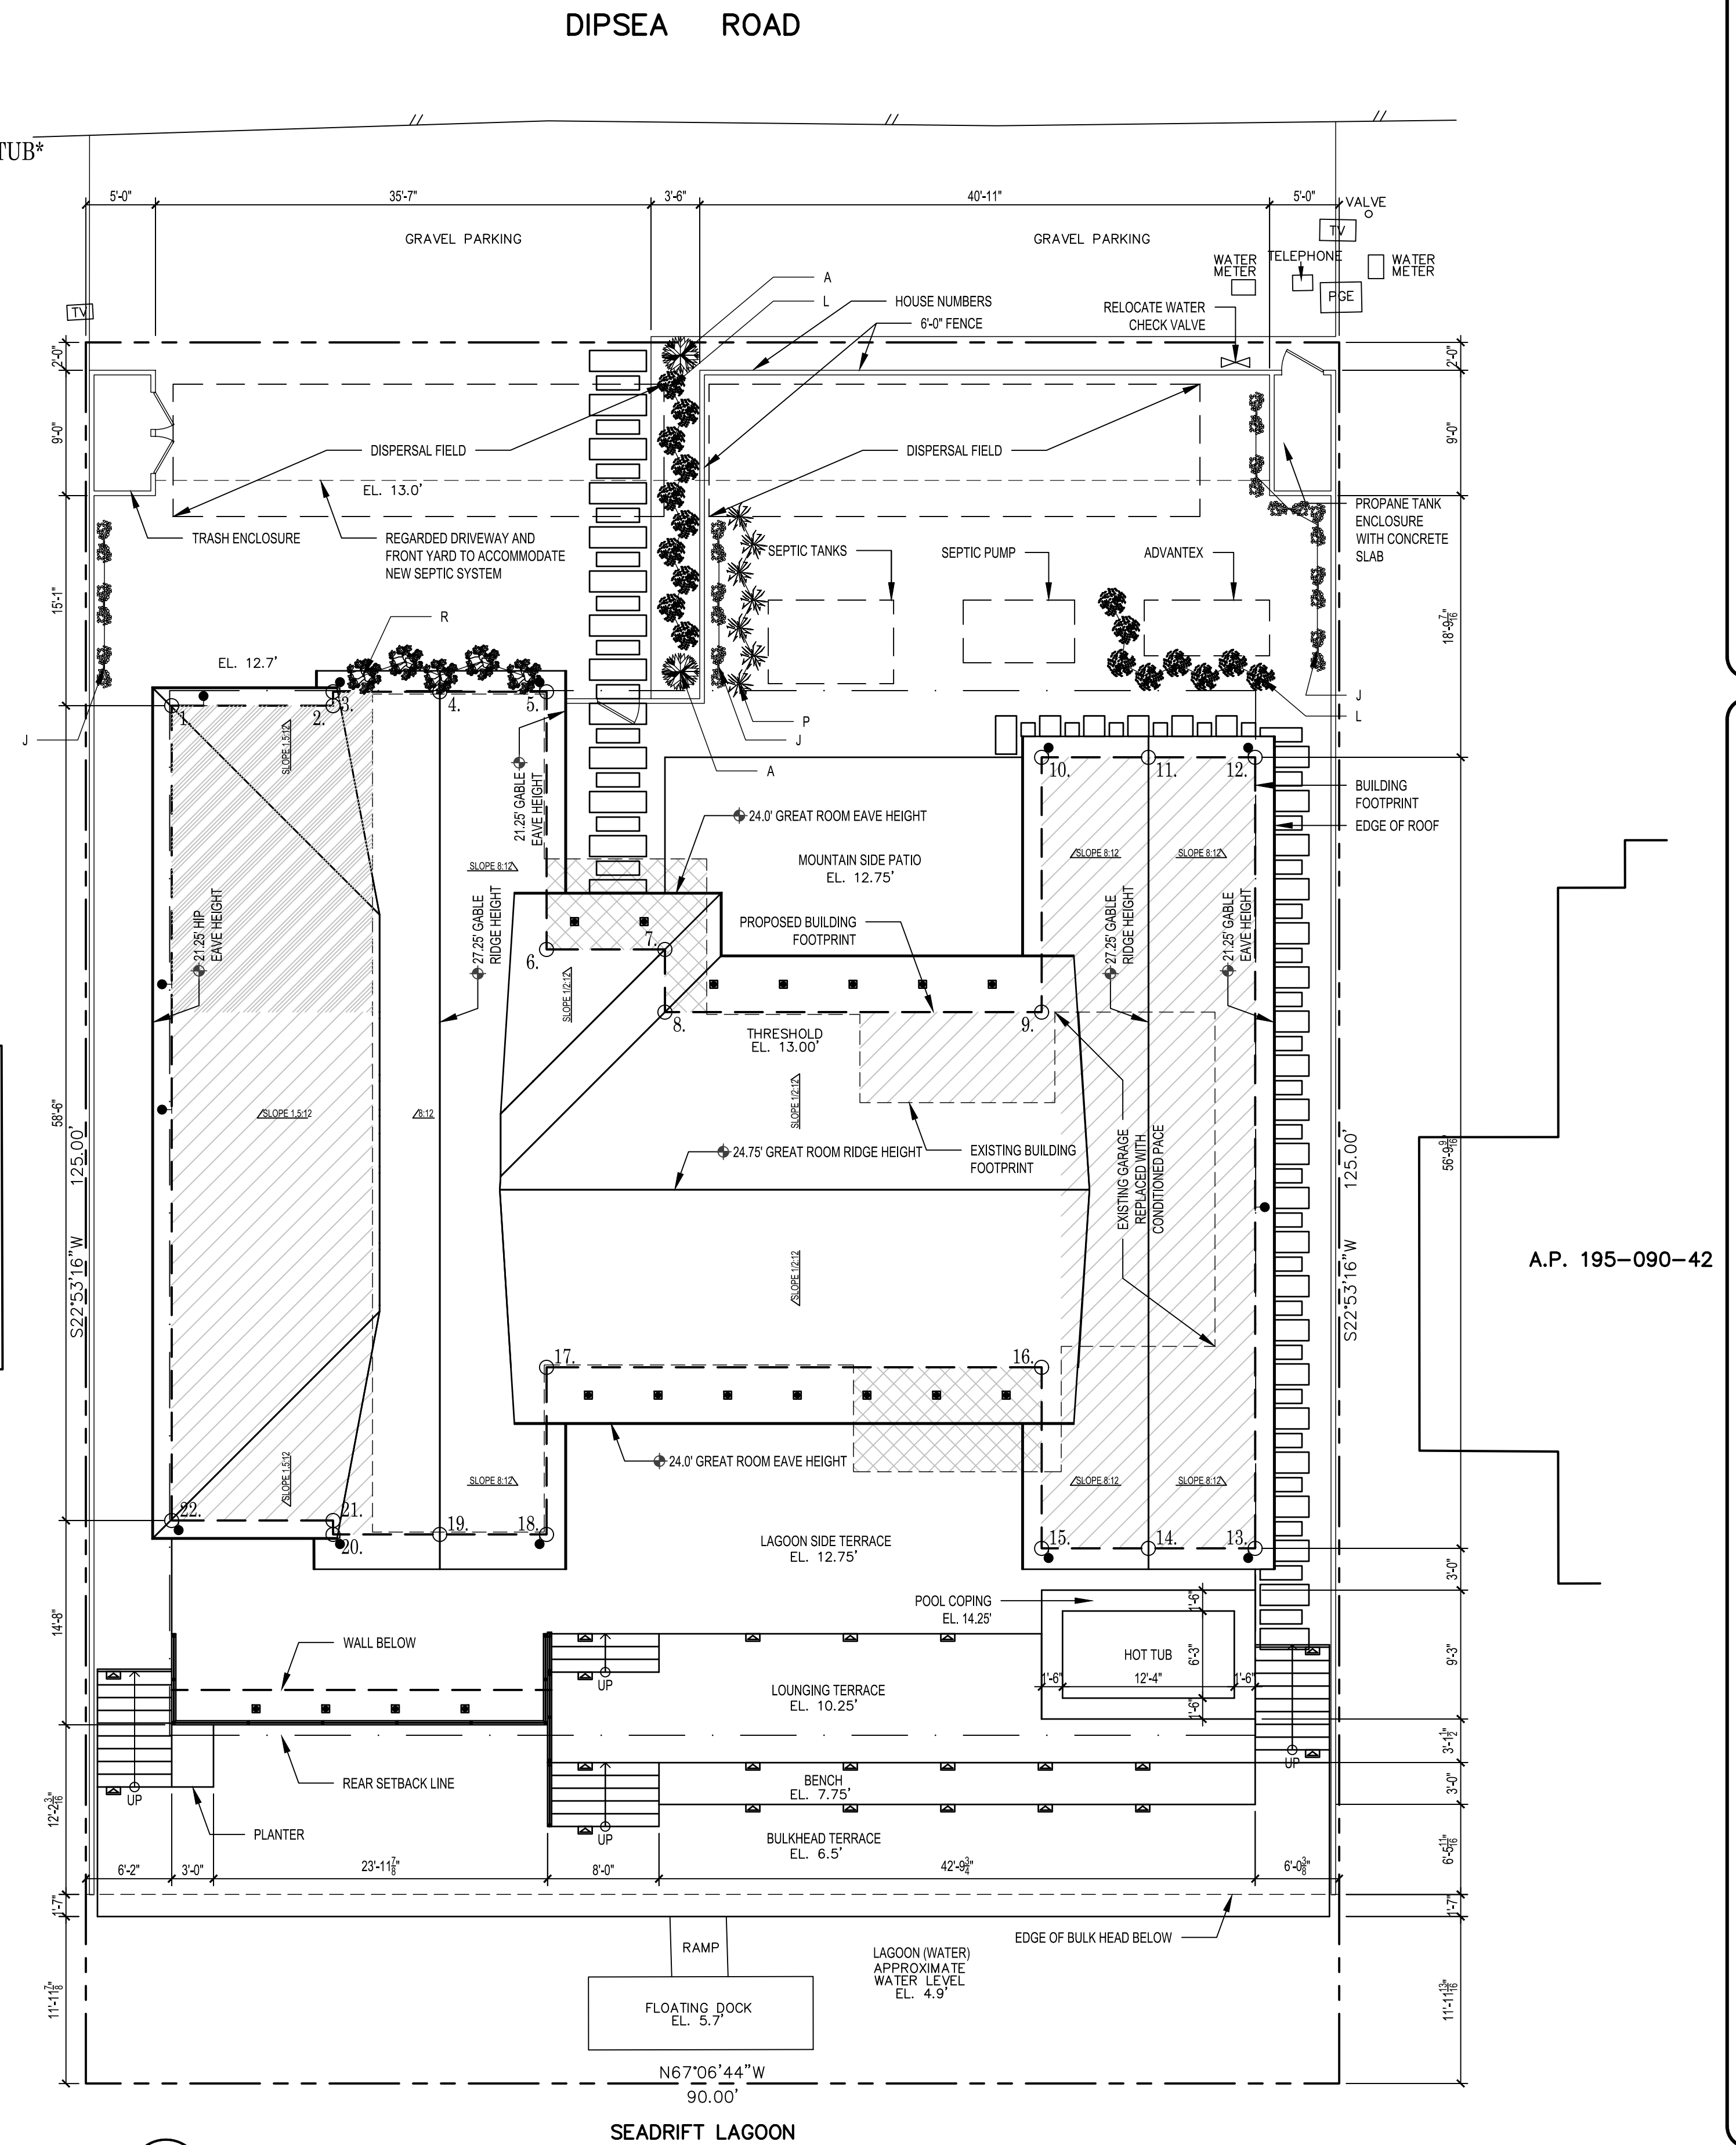

1 SITE PLAN
1/8" = 1'-0"

STEVE WISENBAKER AIA
ARCHITECTS & PLANNERS
300 TAMAL PLAZA SUITE 200 CORTE MADERA CA 94925 415-924-1020

February 11, 2021


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JENSEN RESIDENCE
43 DIPSEA ROAD, STINSON BEACH, CALIFORNIA

Scale: 1/8" = 1'-0"
Refer: North

WALL LEGEND
 [Hatched Box] New Wall
 [Solid Box] Existing Wall

FLOOR AREA LEGEND
 [Diagonal Hatched Box] New Conditioned Space
 [Cross-hatched Box] New Garage
 [Dotted Box] Removed Conditioned Space

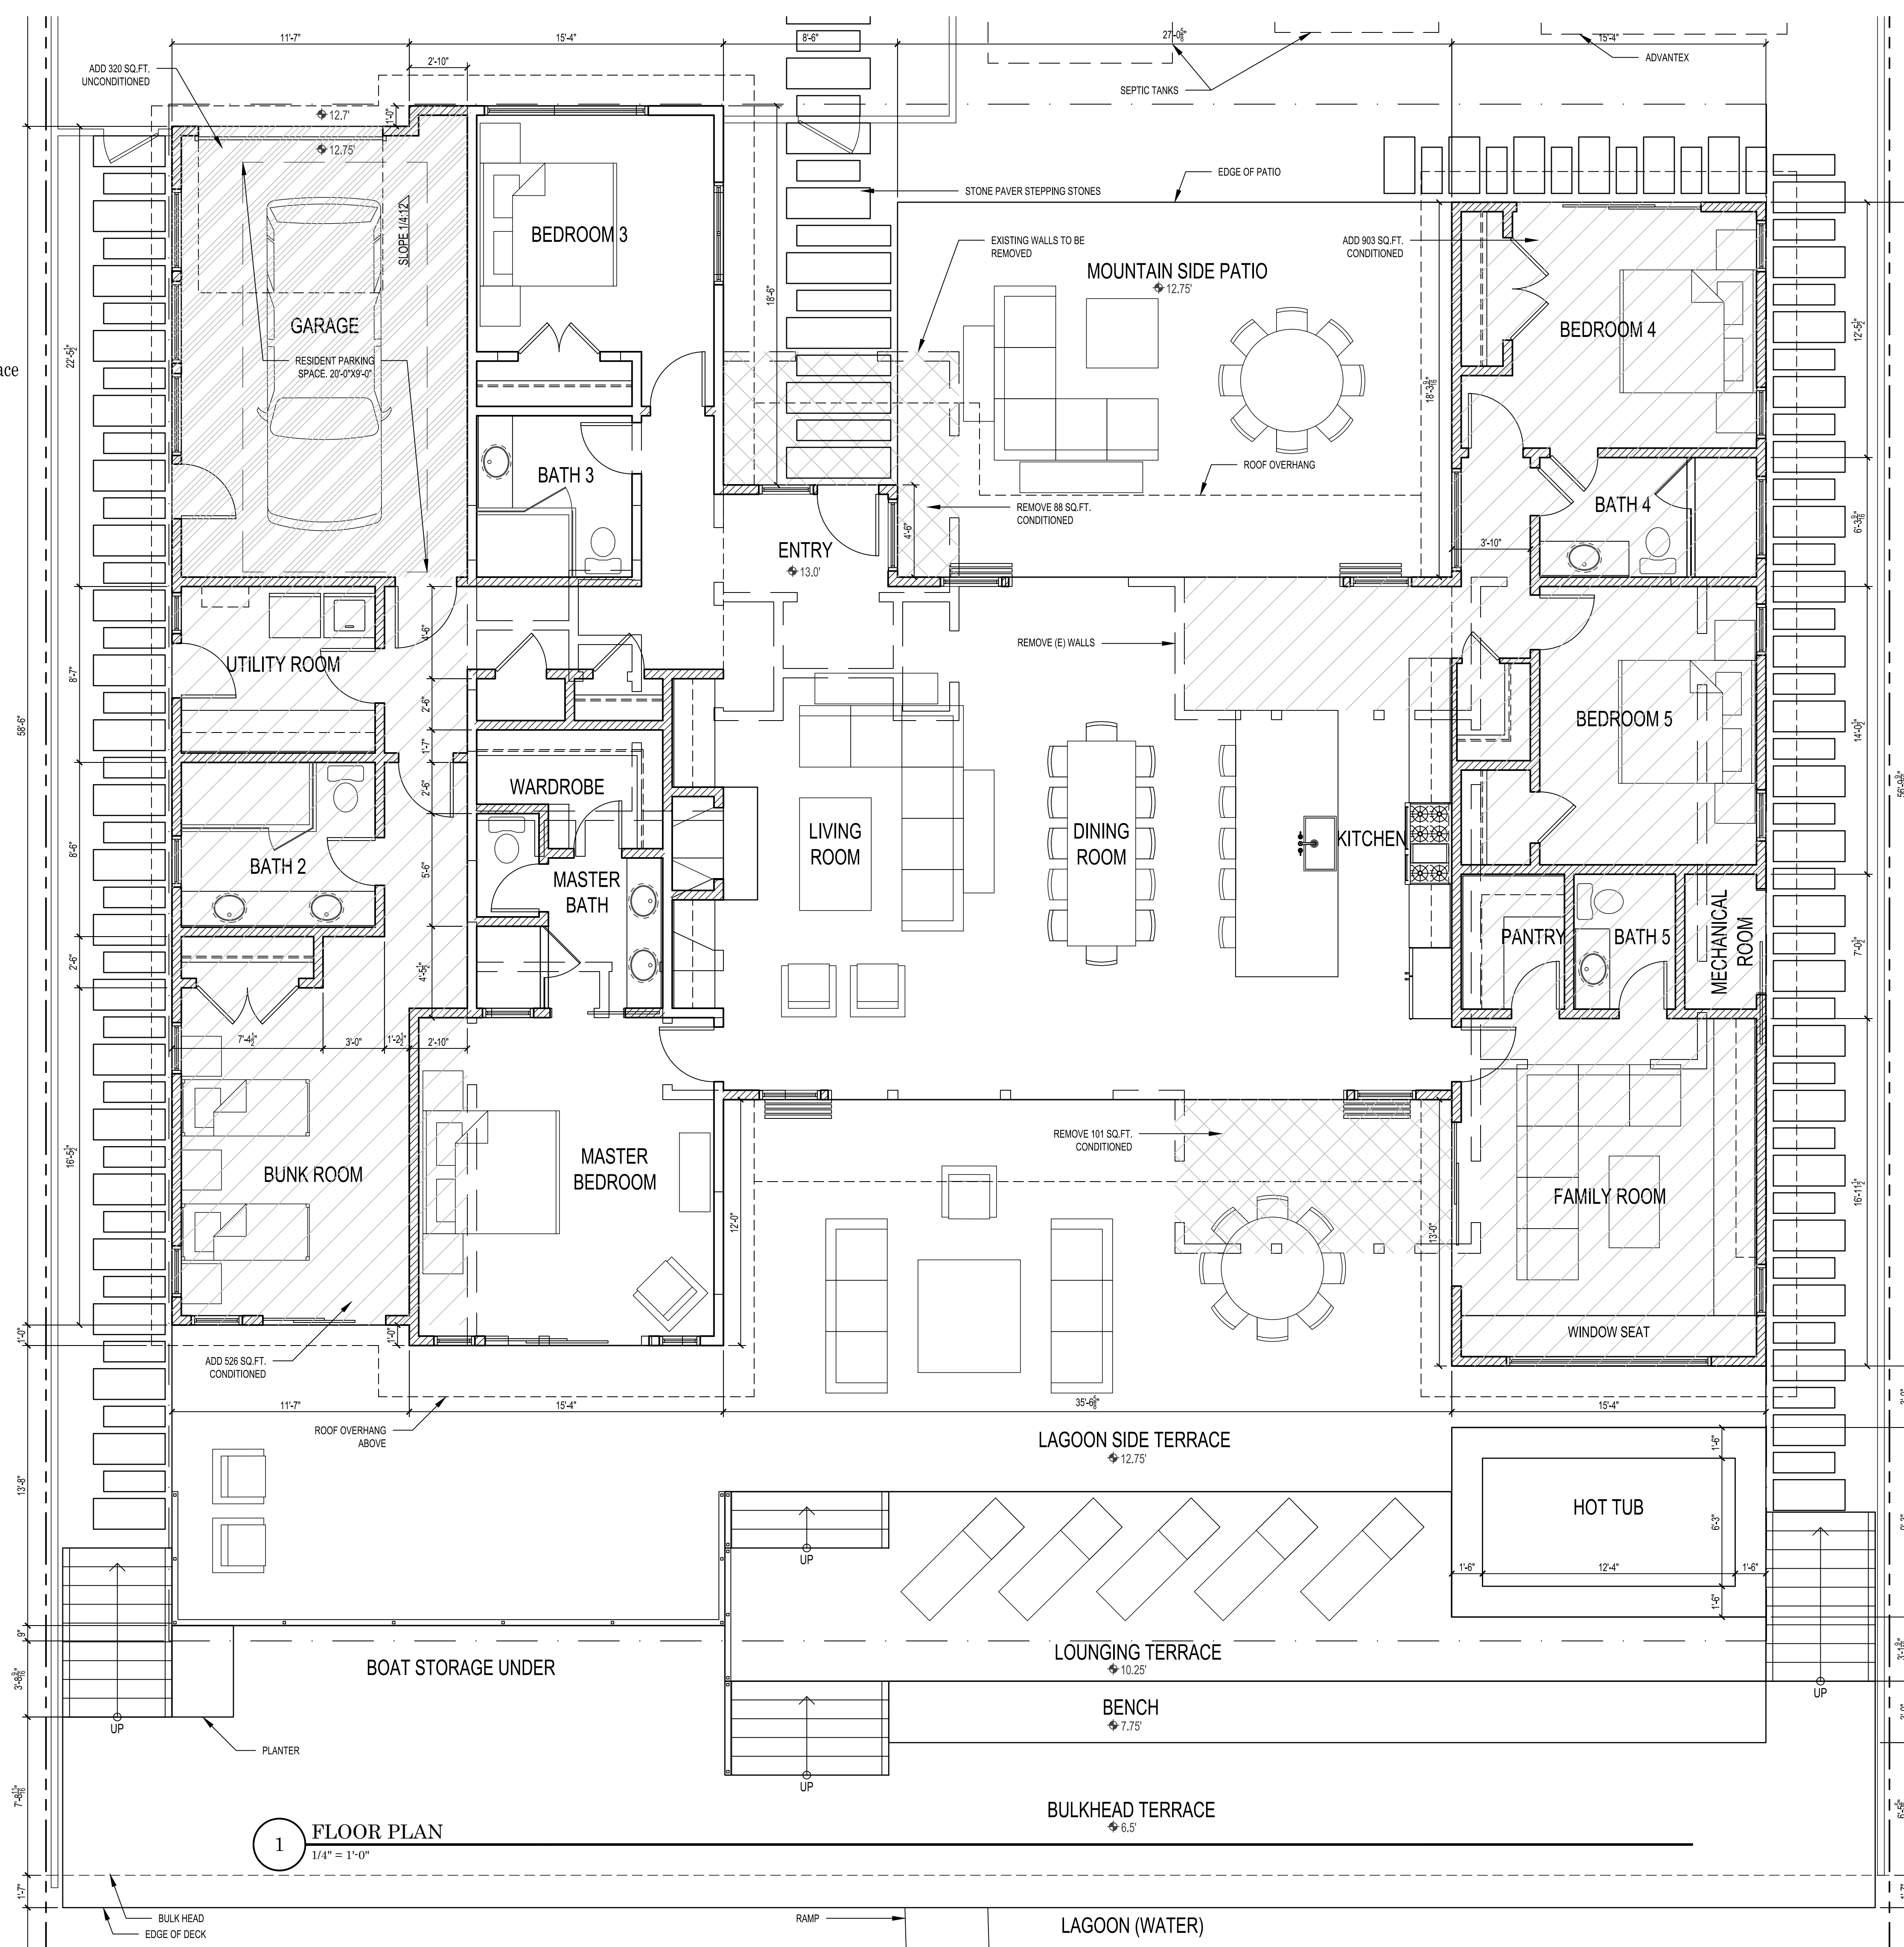

1 FLOOR PLAN
 1/4" = 1'-0"


STEVE WISENBAKER AIA
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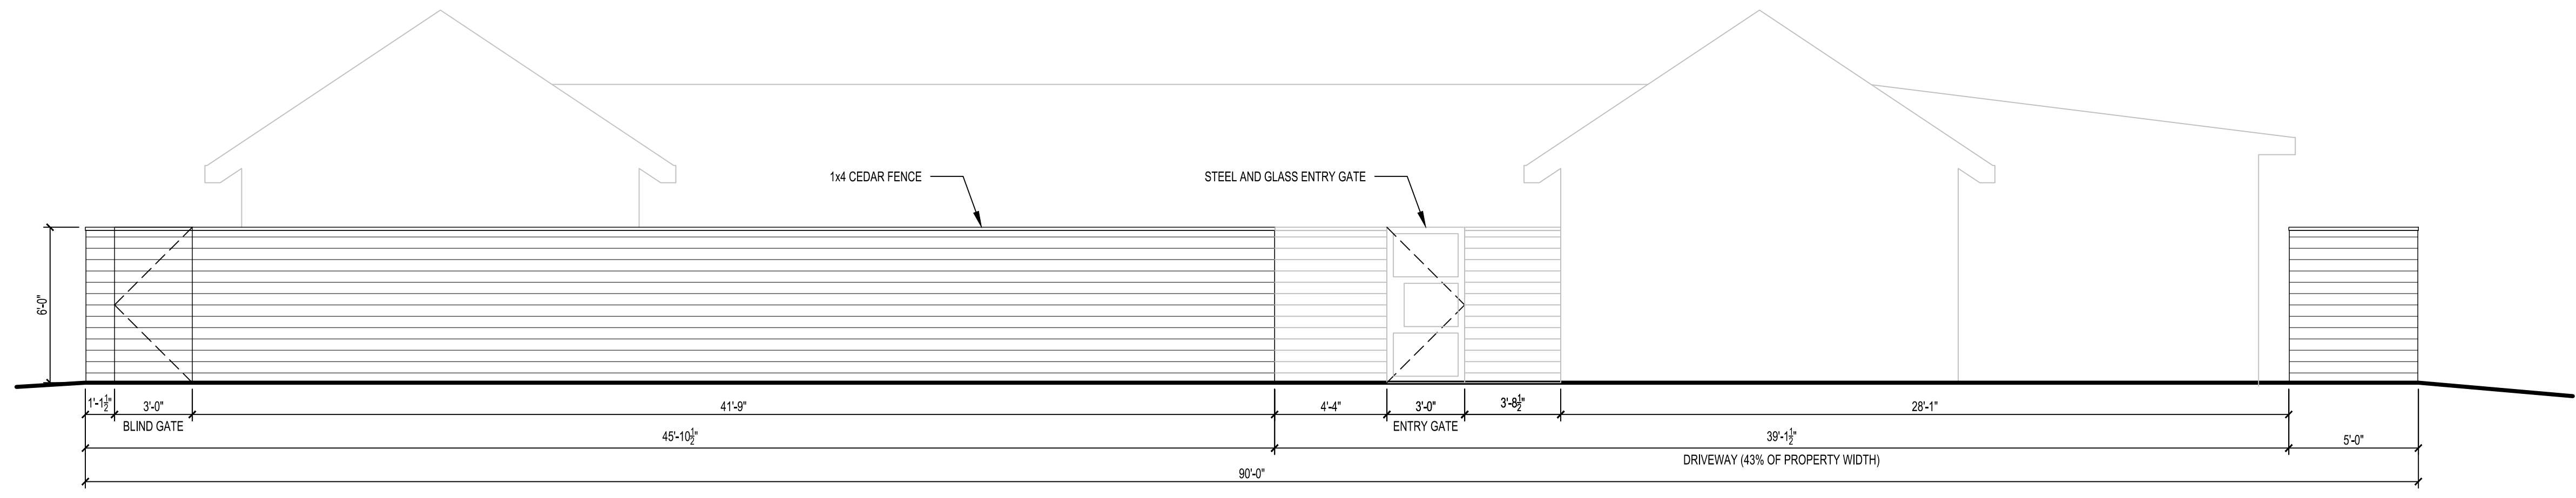
JENSEN RESIDENCE
 43 DIPSEA ROAD, STINSON BEACH, CALIFORNIA

Scale
 1" = 4'
 1" = 8'
 1" = 20'



Refer. North





4 TYPICAL FENCE DETAIL
3/4" = 1'-0"

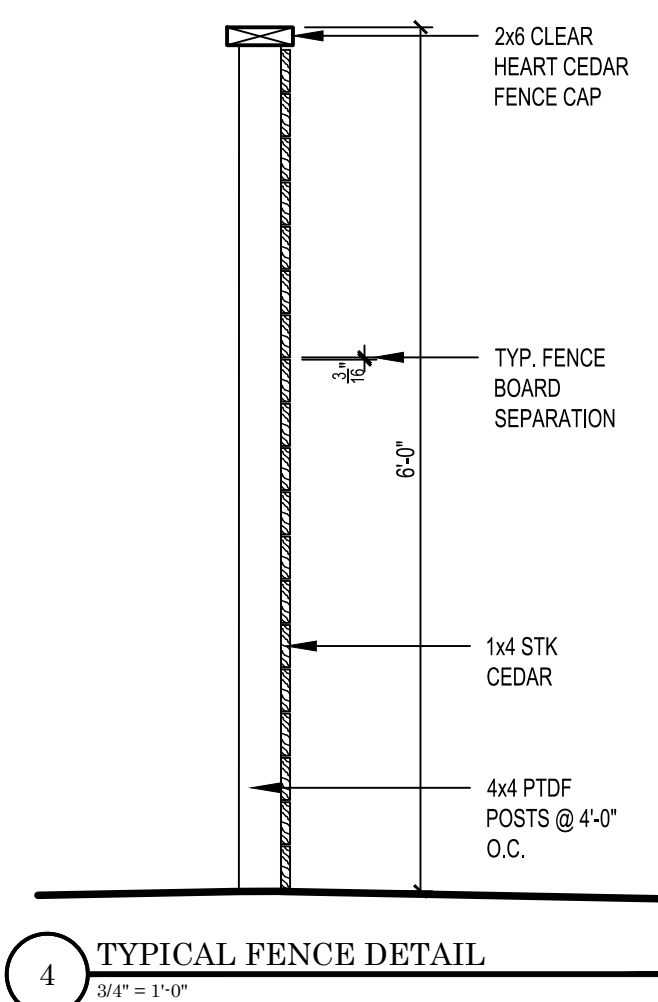

3 STREET FENCE ELEVATION
3/4" = 1'-0"

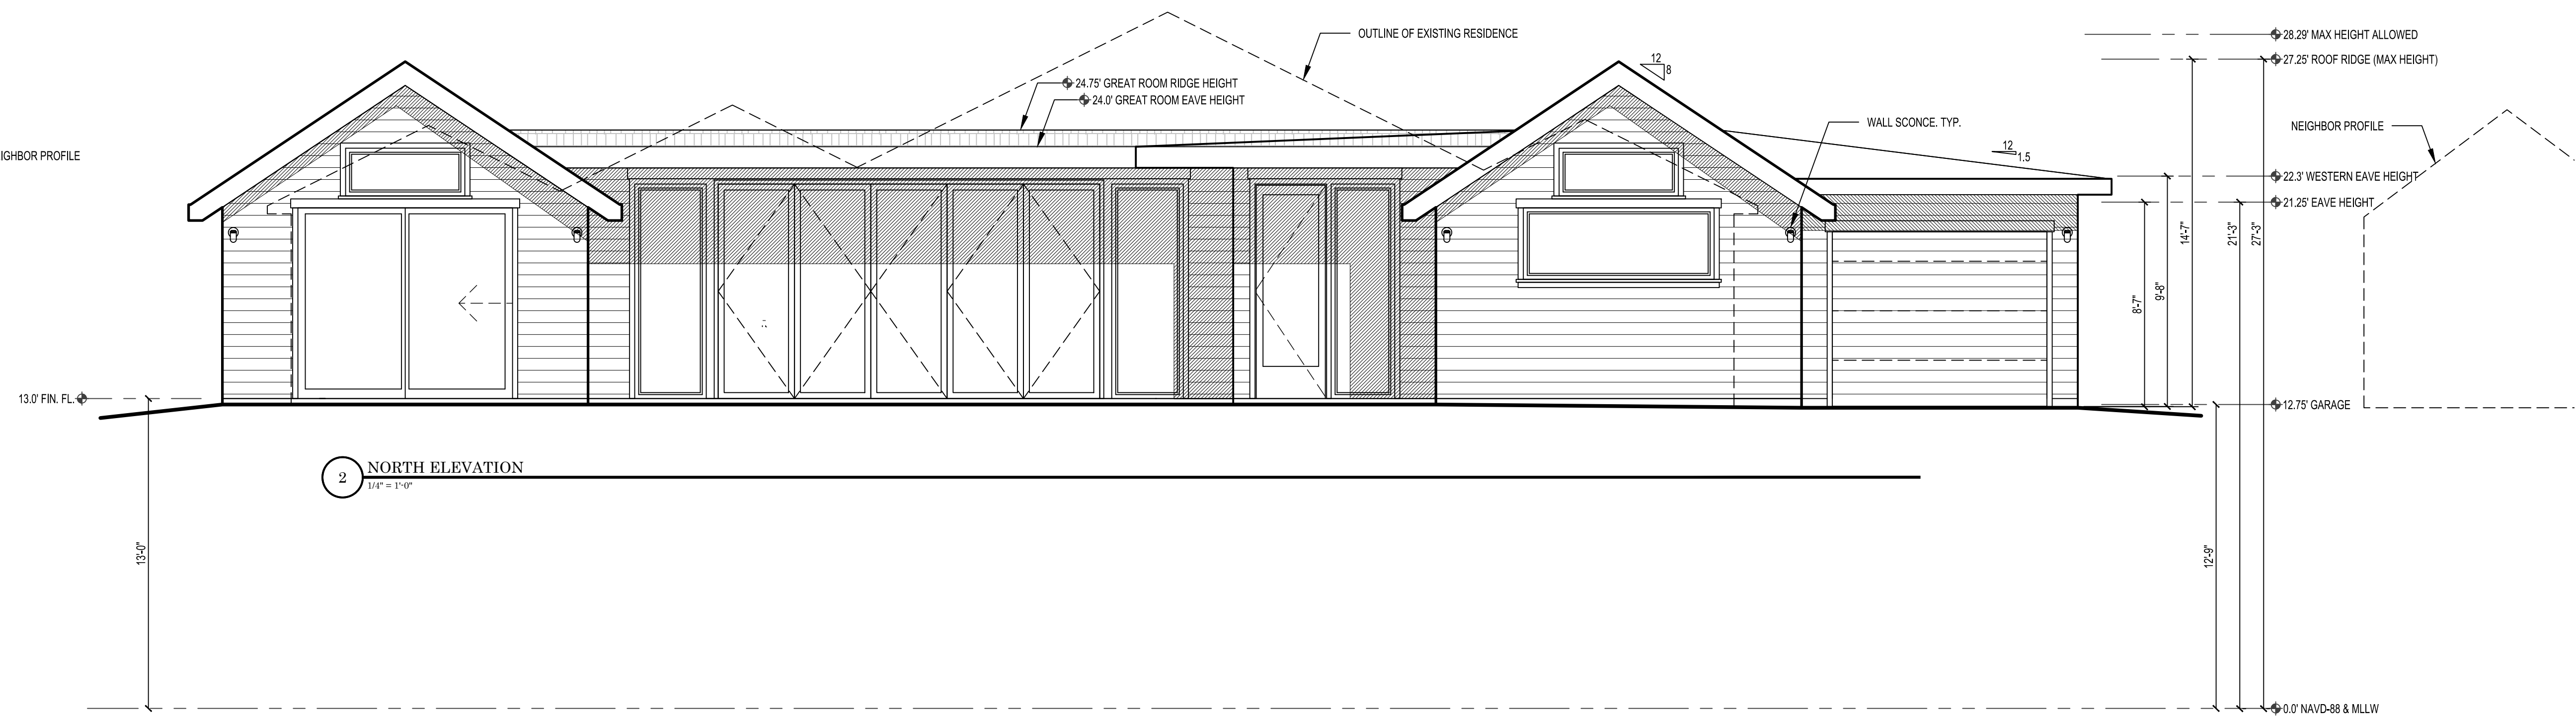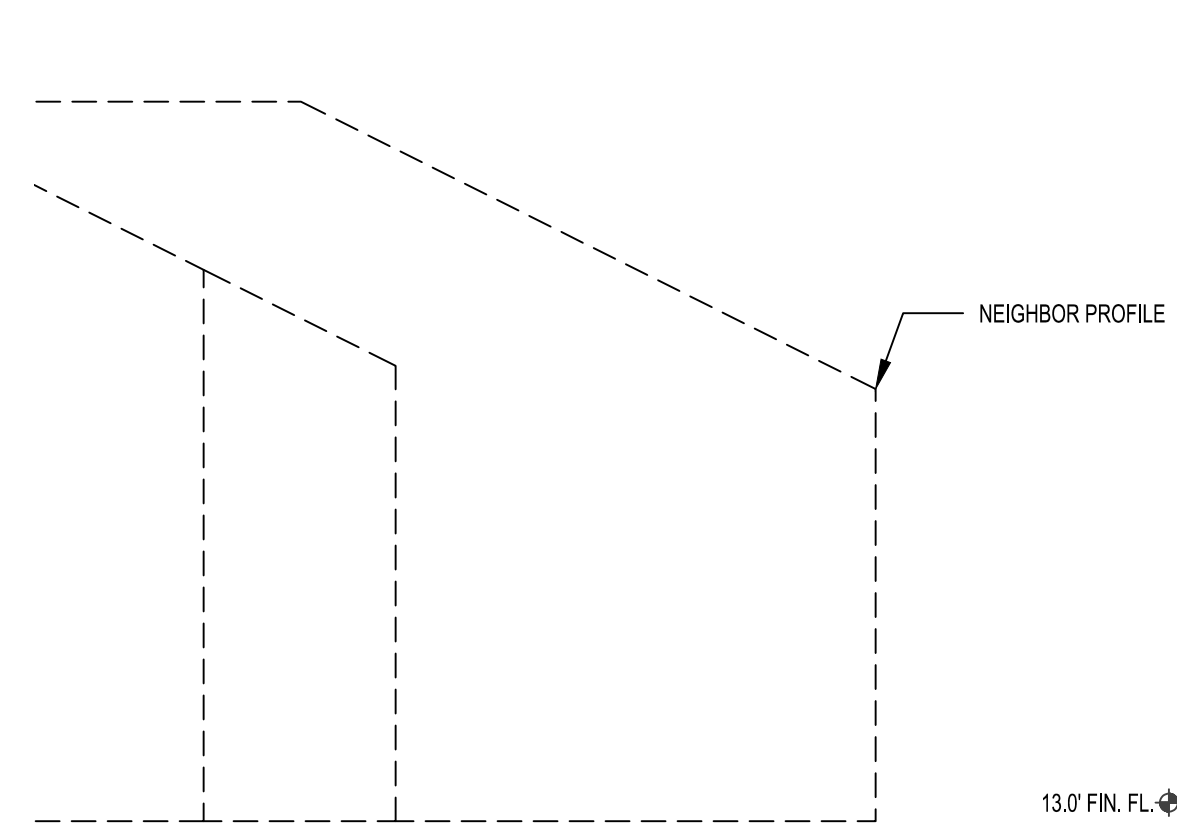

2 NORTH ELEVATION
3/4" = 1'-0"

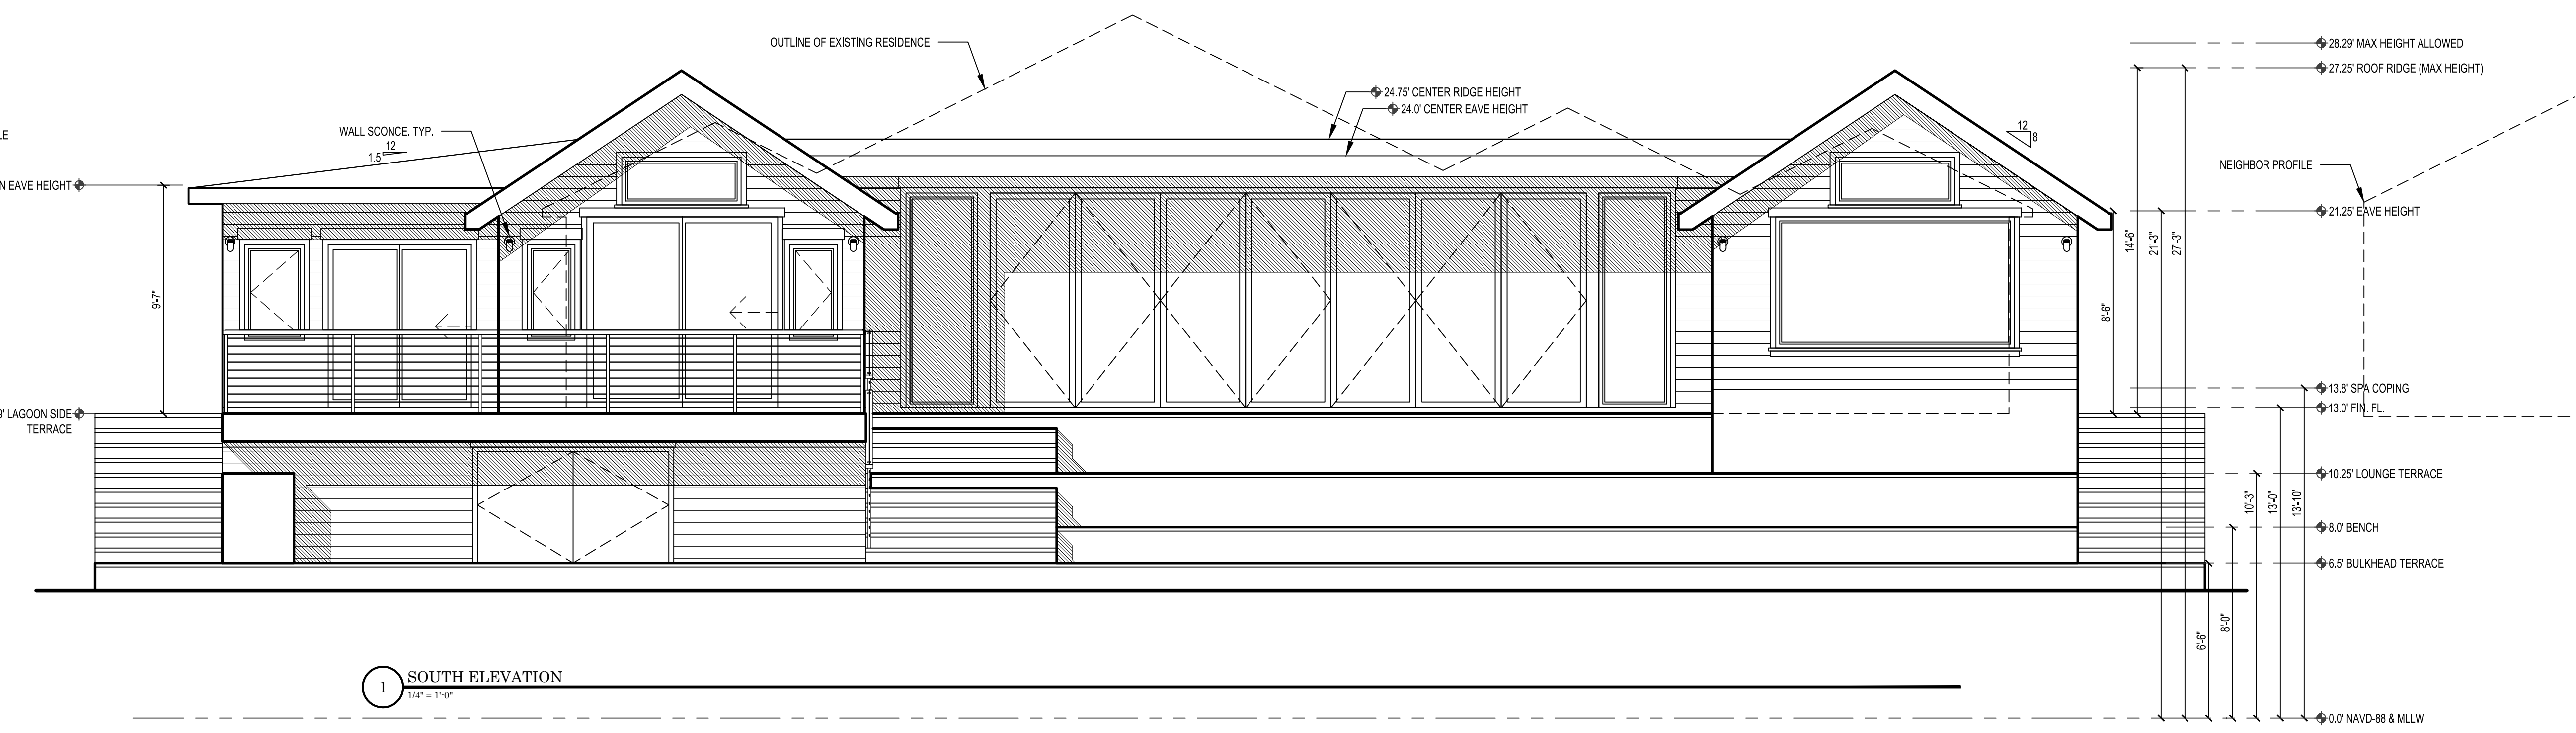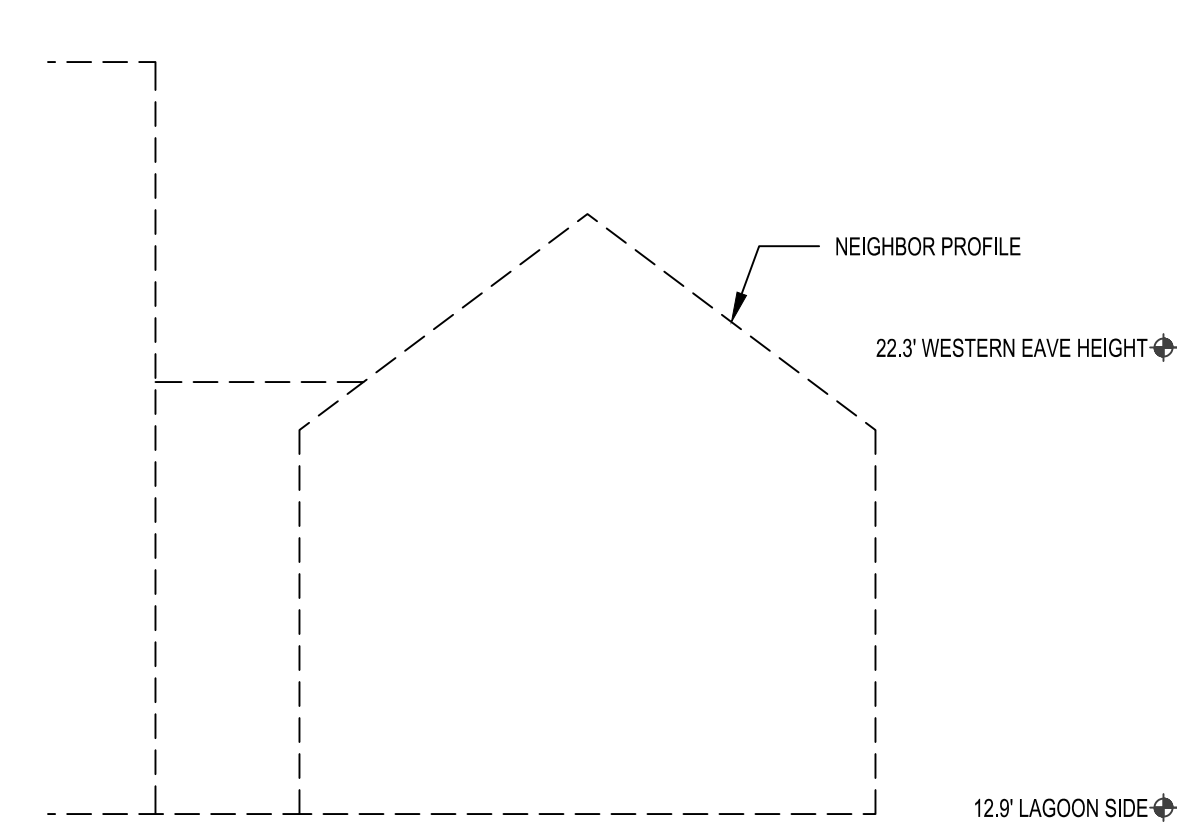

1 SOUTH ELEVATION
3/4" = 1'-0"


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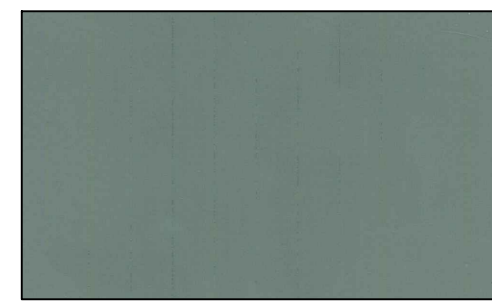
JENSEN RESIDENCE
 43 DIPSEA ROAD, STINSON BEACH, CALIFORNIA

Scale
 In 0 4 8 20
 Feet


Refer. North



WINDOWS & EXT. DOORS: Aluminum clad wood (Loewen Stone Gray)

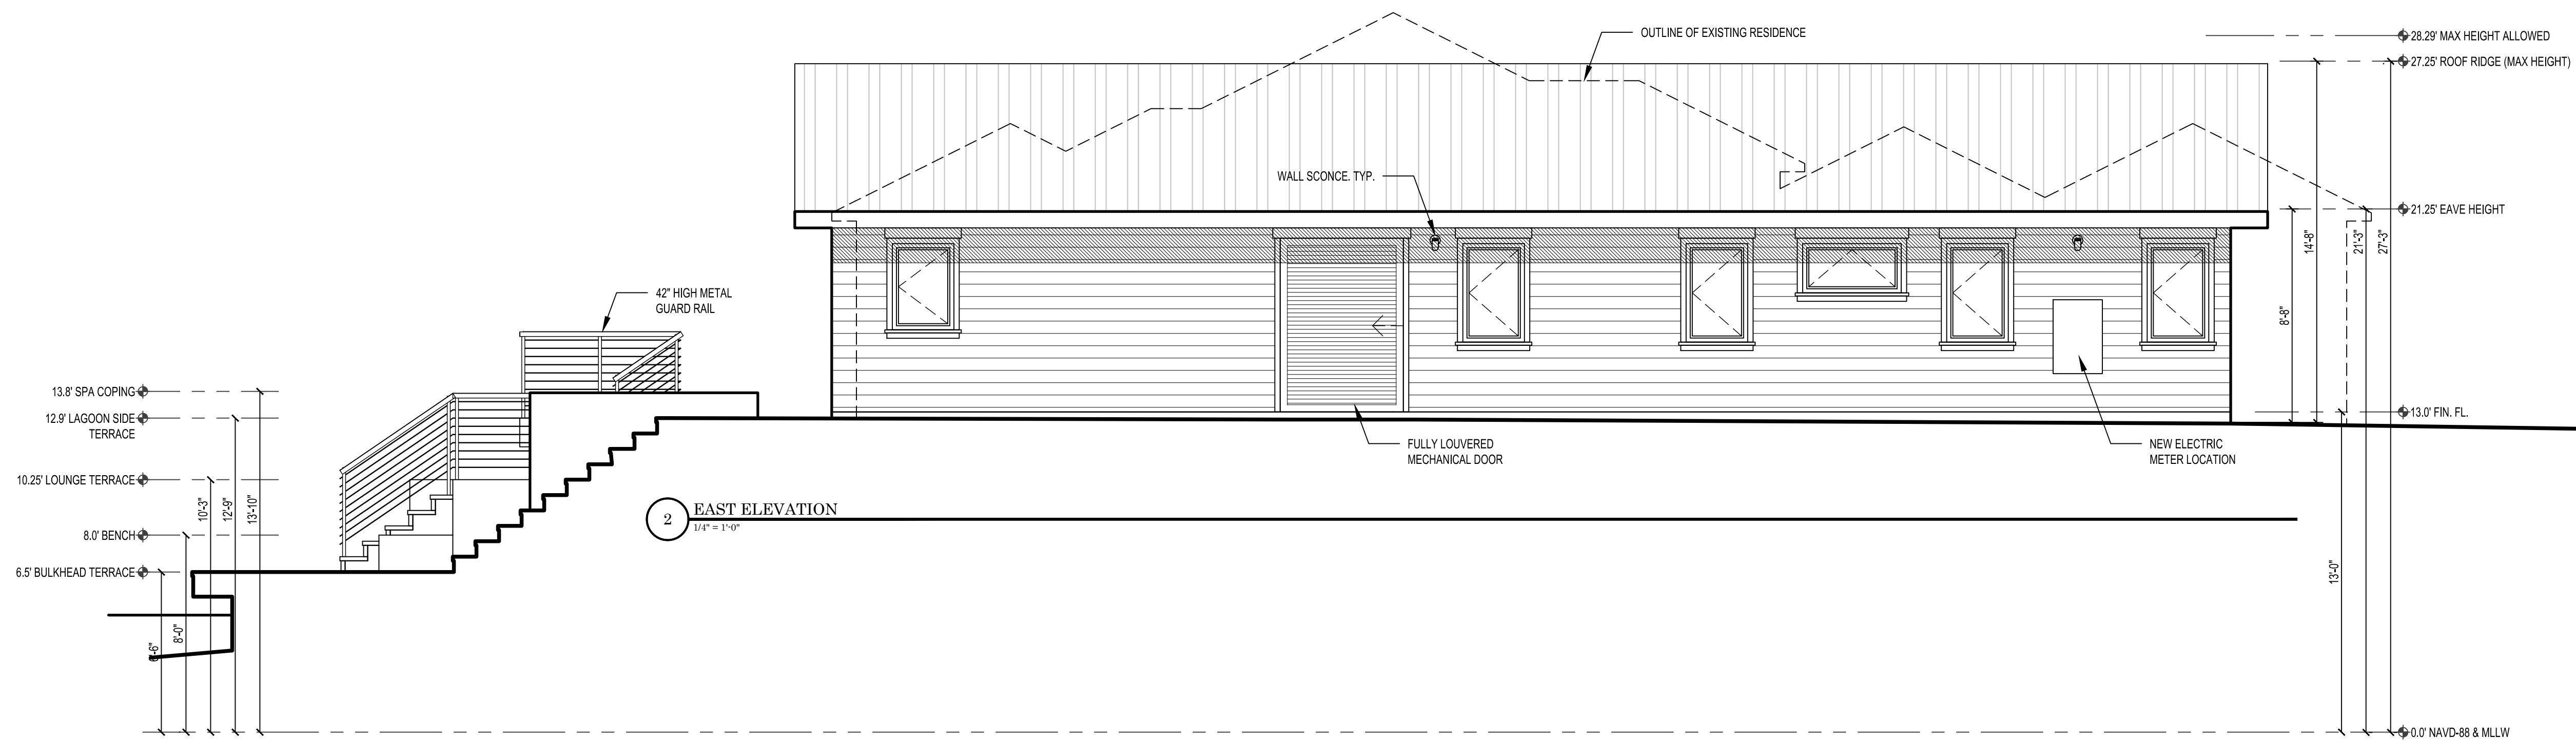

FASCIA & TRIM: Cedar, Painted. (DE6239 'Late Froth')

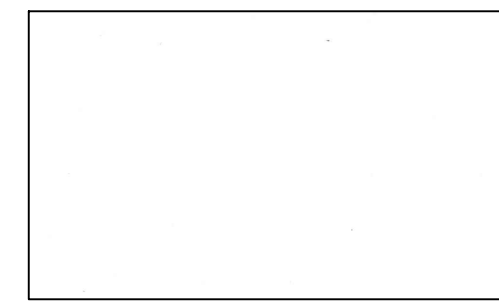

WALLS: 1x8 Hardie siding V-Rustic Painted. (DE6348 'Draw Your Sword')



ROOF: Standing Seam Metal (American Building Components 'Charcoal Gray')



MATERIALS OF CONSTRUCTION

ROOF: Standing Seam Metal (American Building Components 'Charcoal Gray'). Over Grace Ultra waterproofing membrane

WALLS: 1x8 Hardie siding V-Rustic Painted. (DE6348 'Draw Your Sword')

DOWNSPOUTS: 16 oz. Copper 3" rectangular downspouts; custom copper leader heads.

WINDOWS & EXT. DOORS: Aluminum clad wood (Loewen Stone Gray)

FASCIA & TRIM: Cedar, Painted. (DE6239 'Late Froth')


MISC FLASHING AND SHEET METAL: Copper

PATIOS: Limestone

GARAGE DOOR: Custom wood to match typical wall siding - see elevations

FENCES: Horizontal - STK Cedar 1x6

RETAINING WALLS & PLANTERS: Face with Limestone

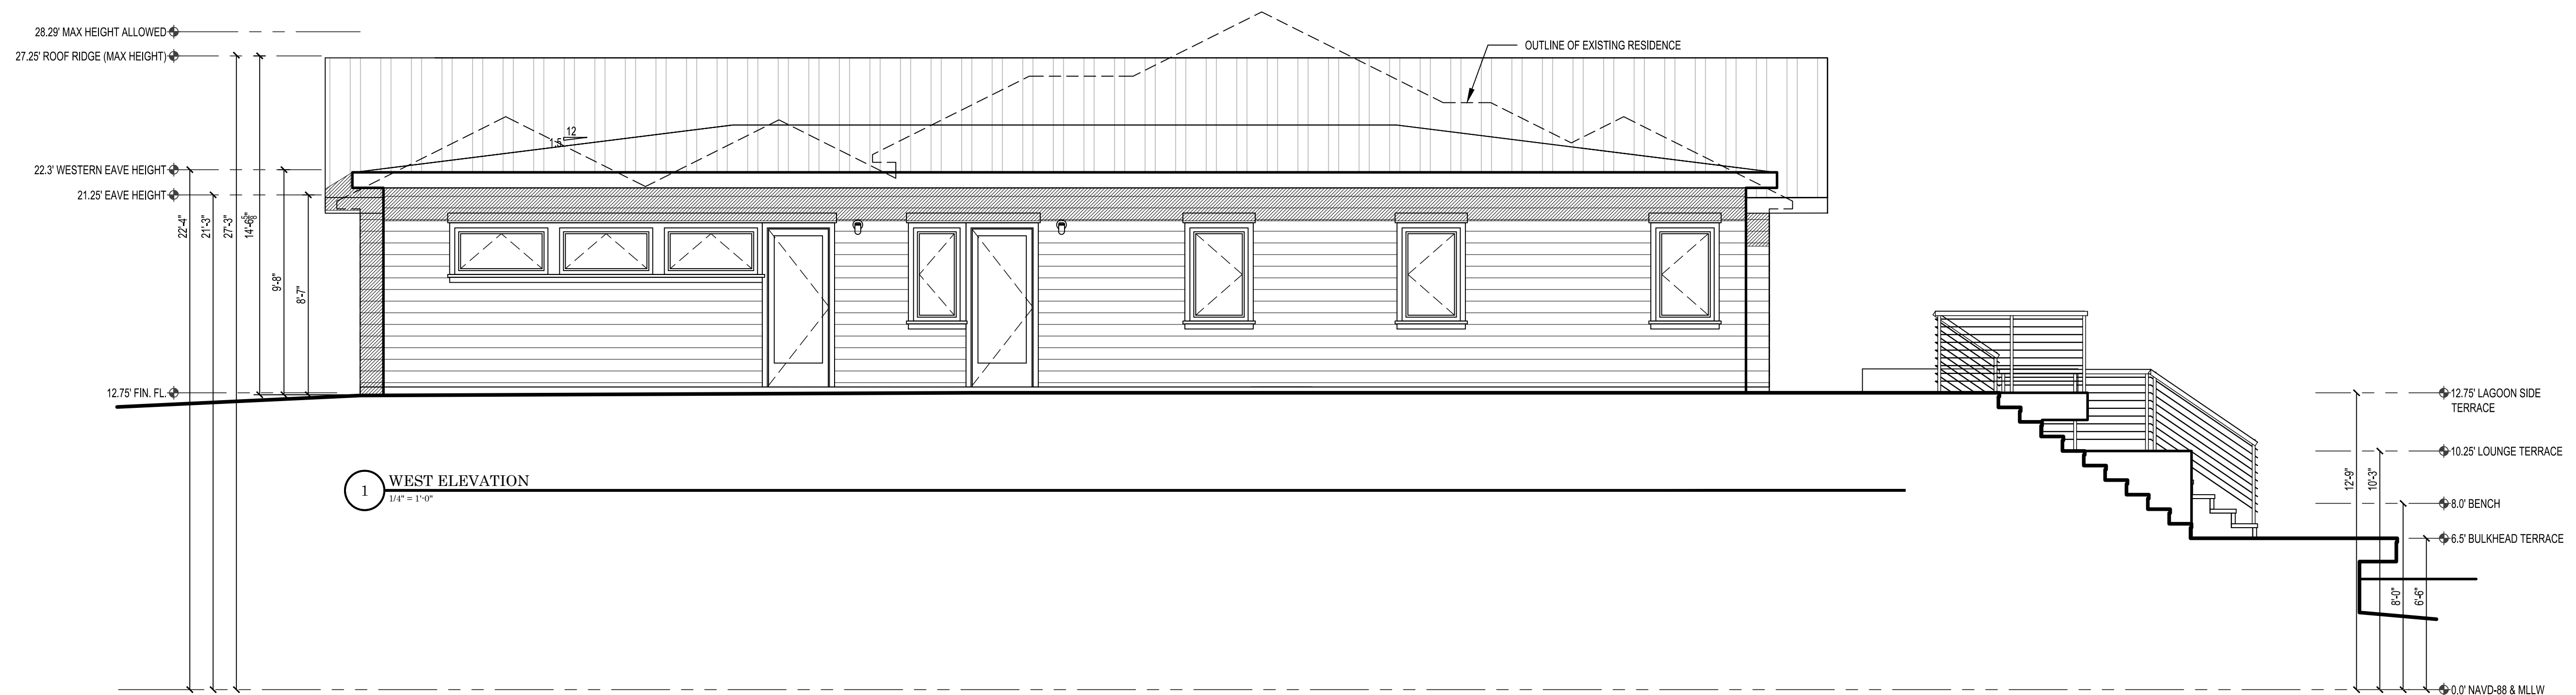



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 300 TAMAL PARRA SUITE 200 CONTE MADRA CA 94125 415-924-1020



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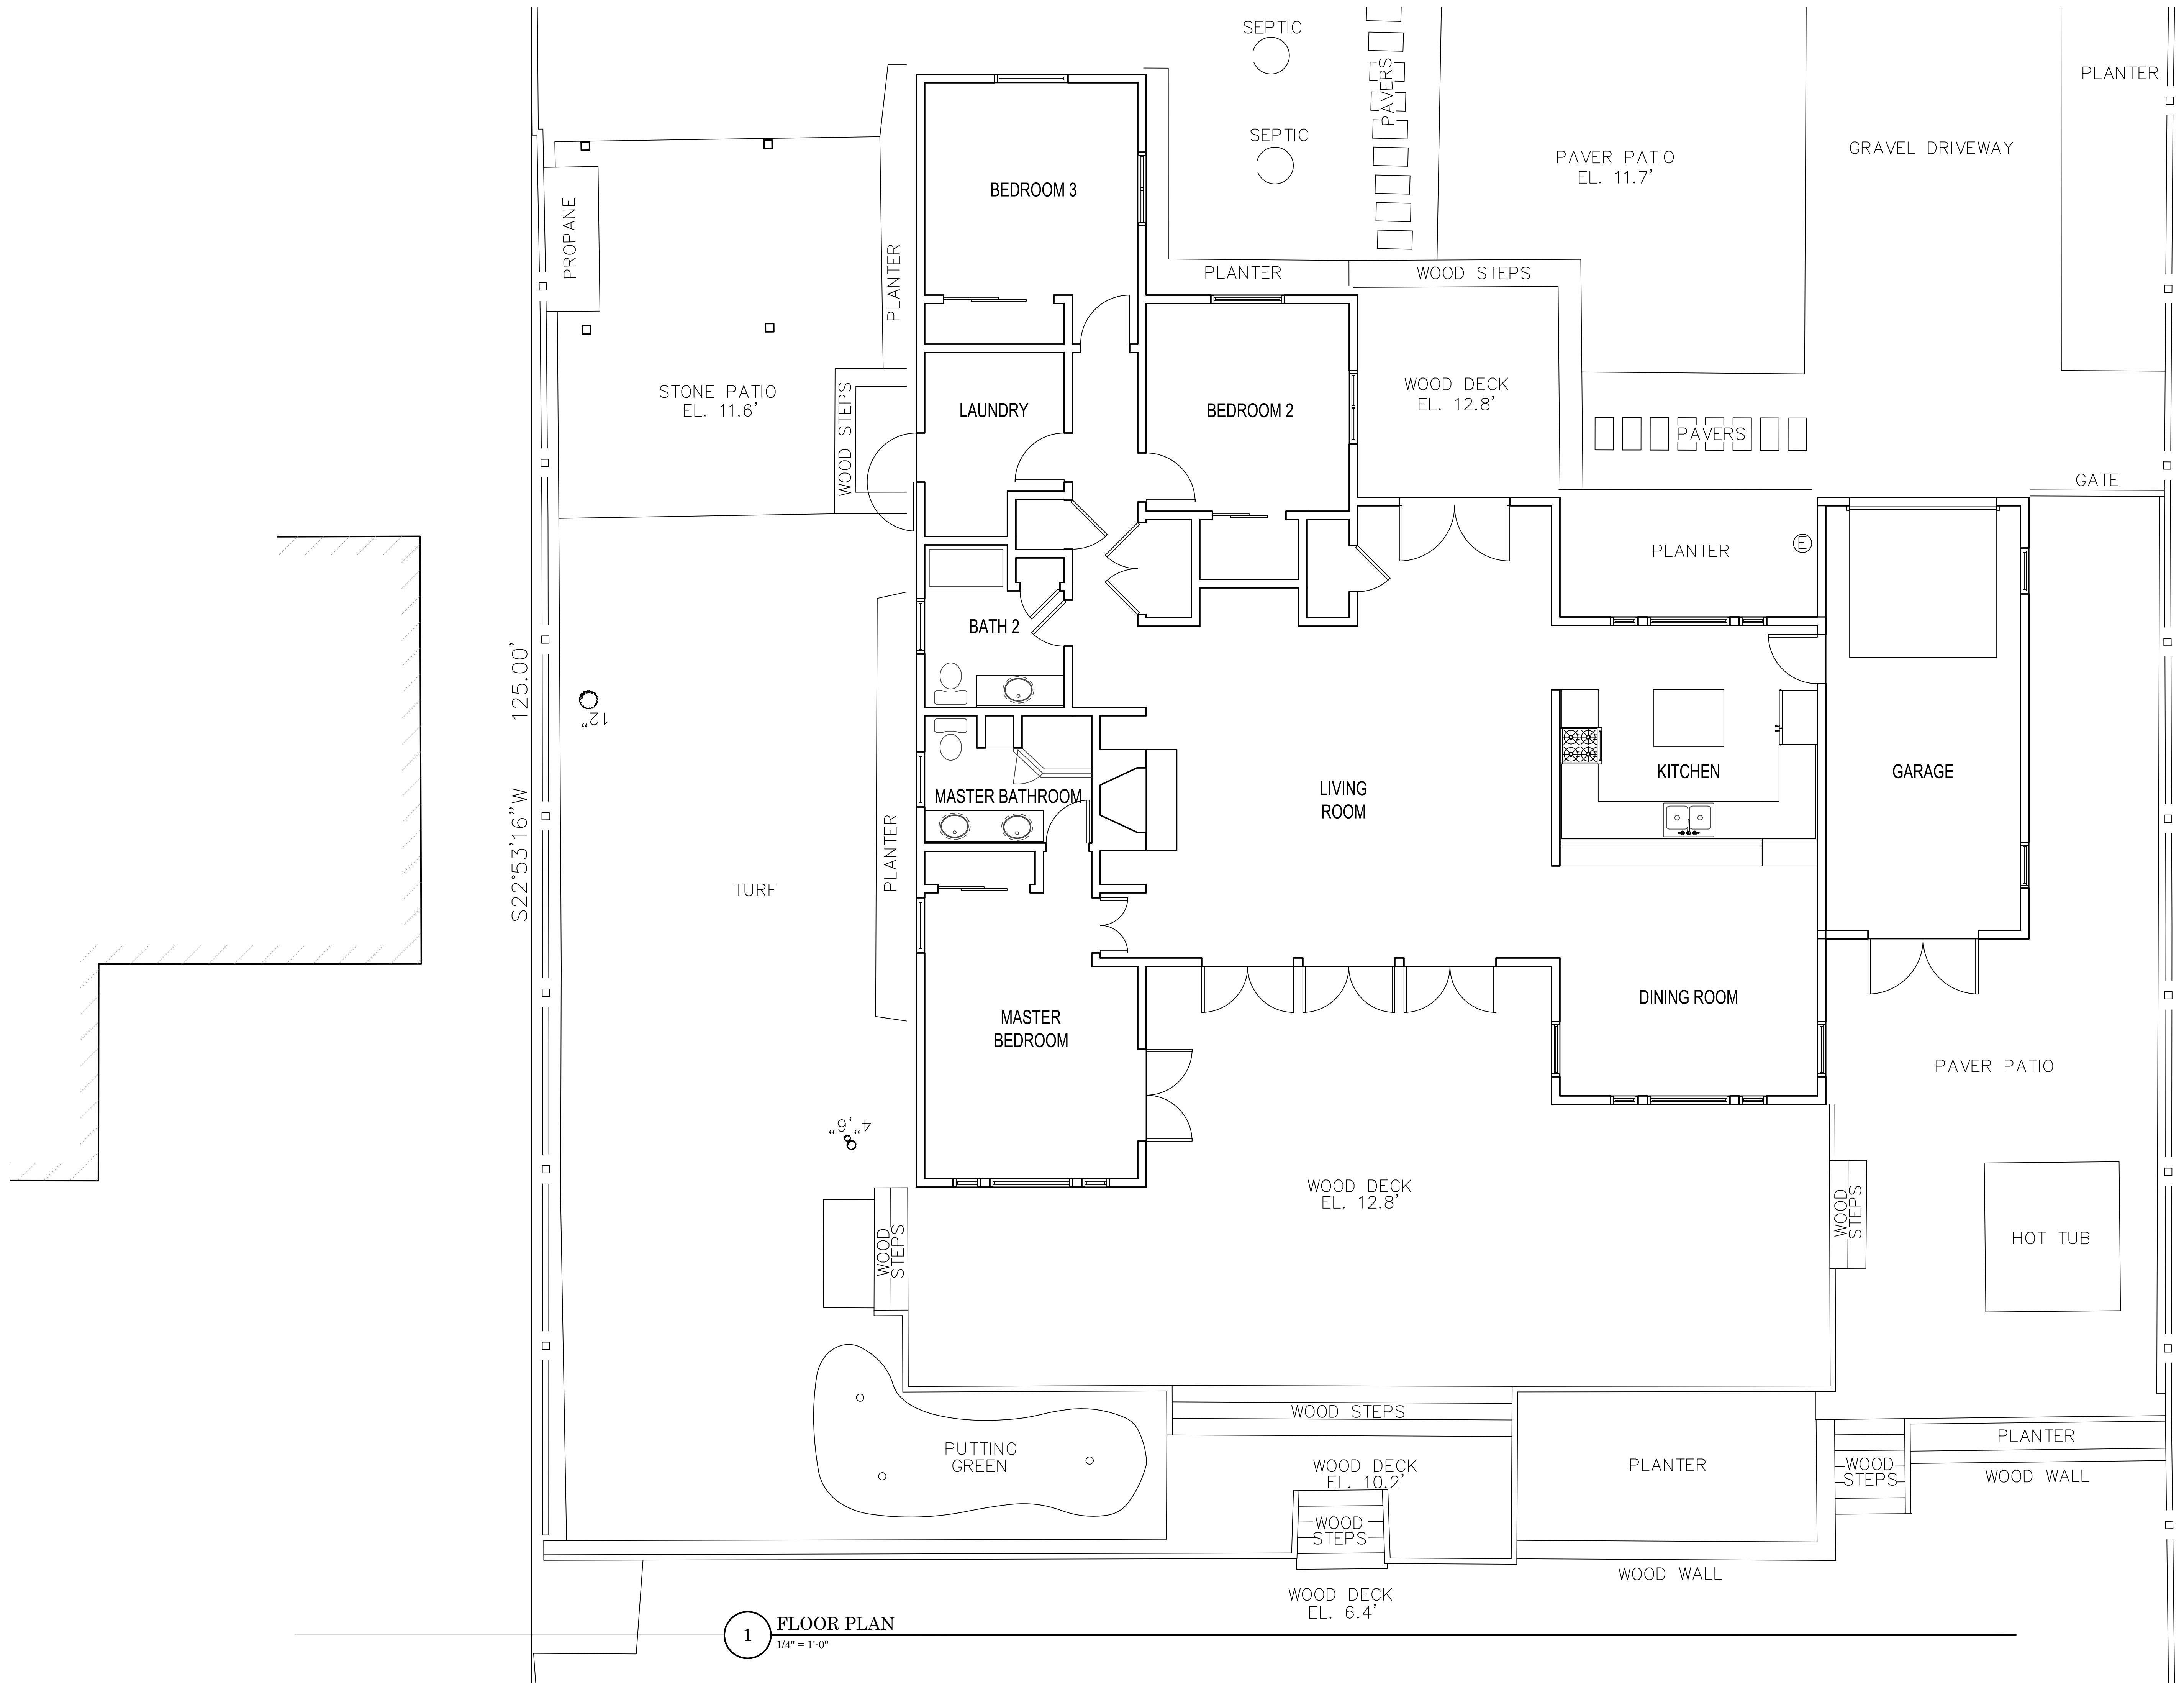
JENSEN RESIDENCE
 43 DIPSEA ROAD, STINSON BEACH, CALIFORNIA

Scale
 In 0 4 8 20
 Feet

Refer. North



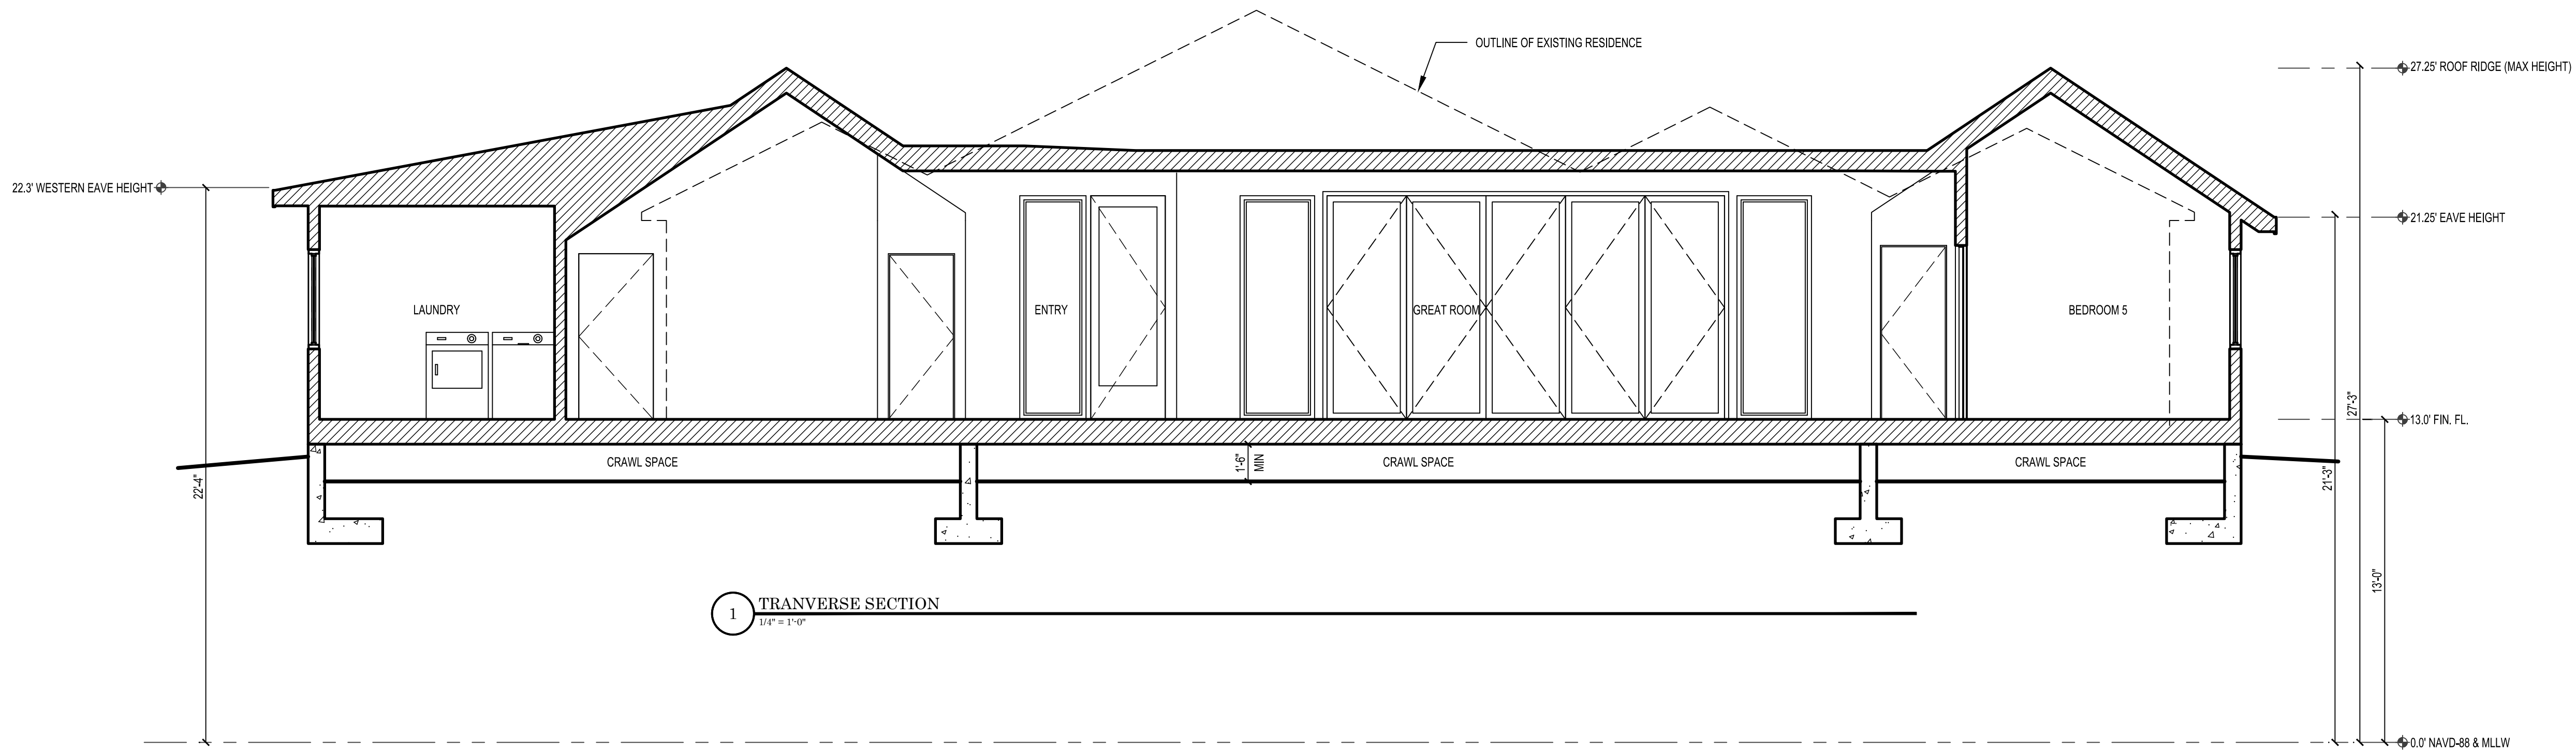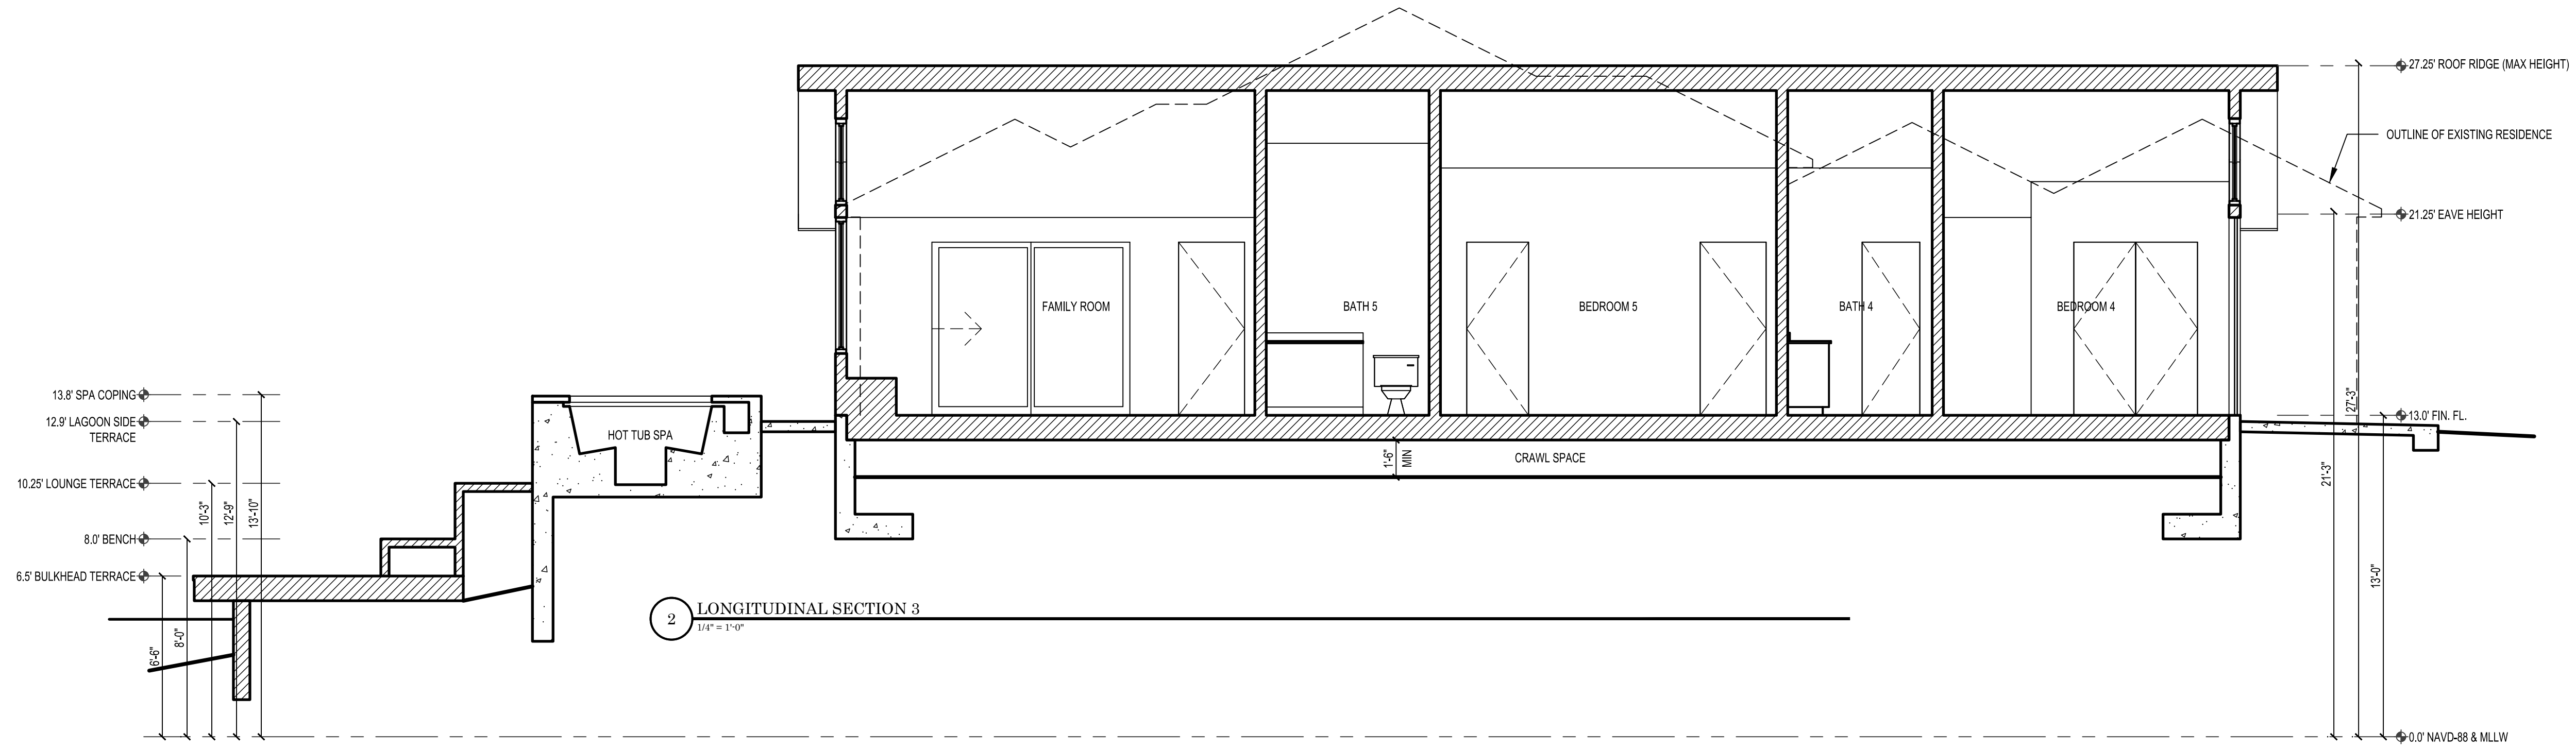

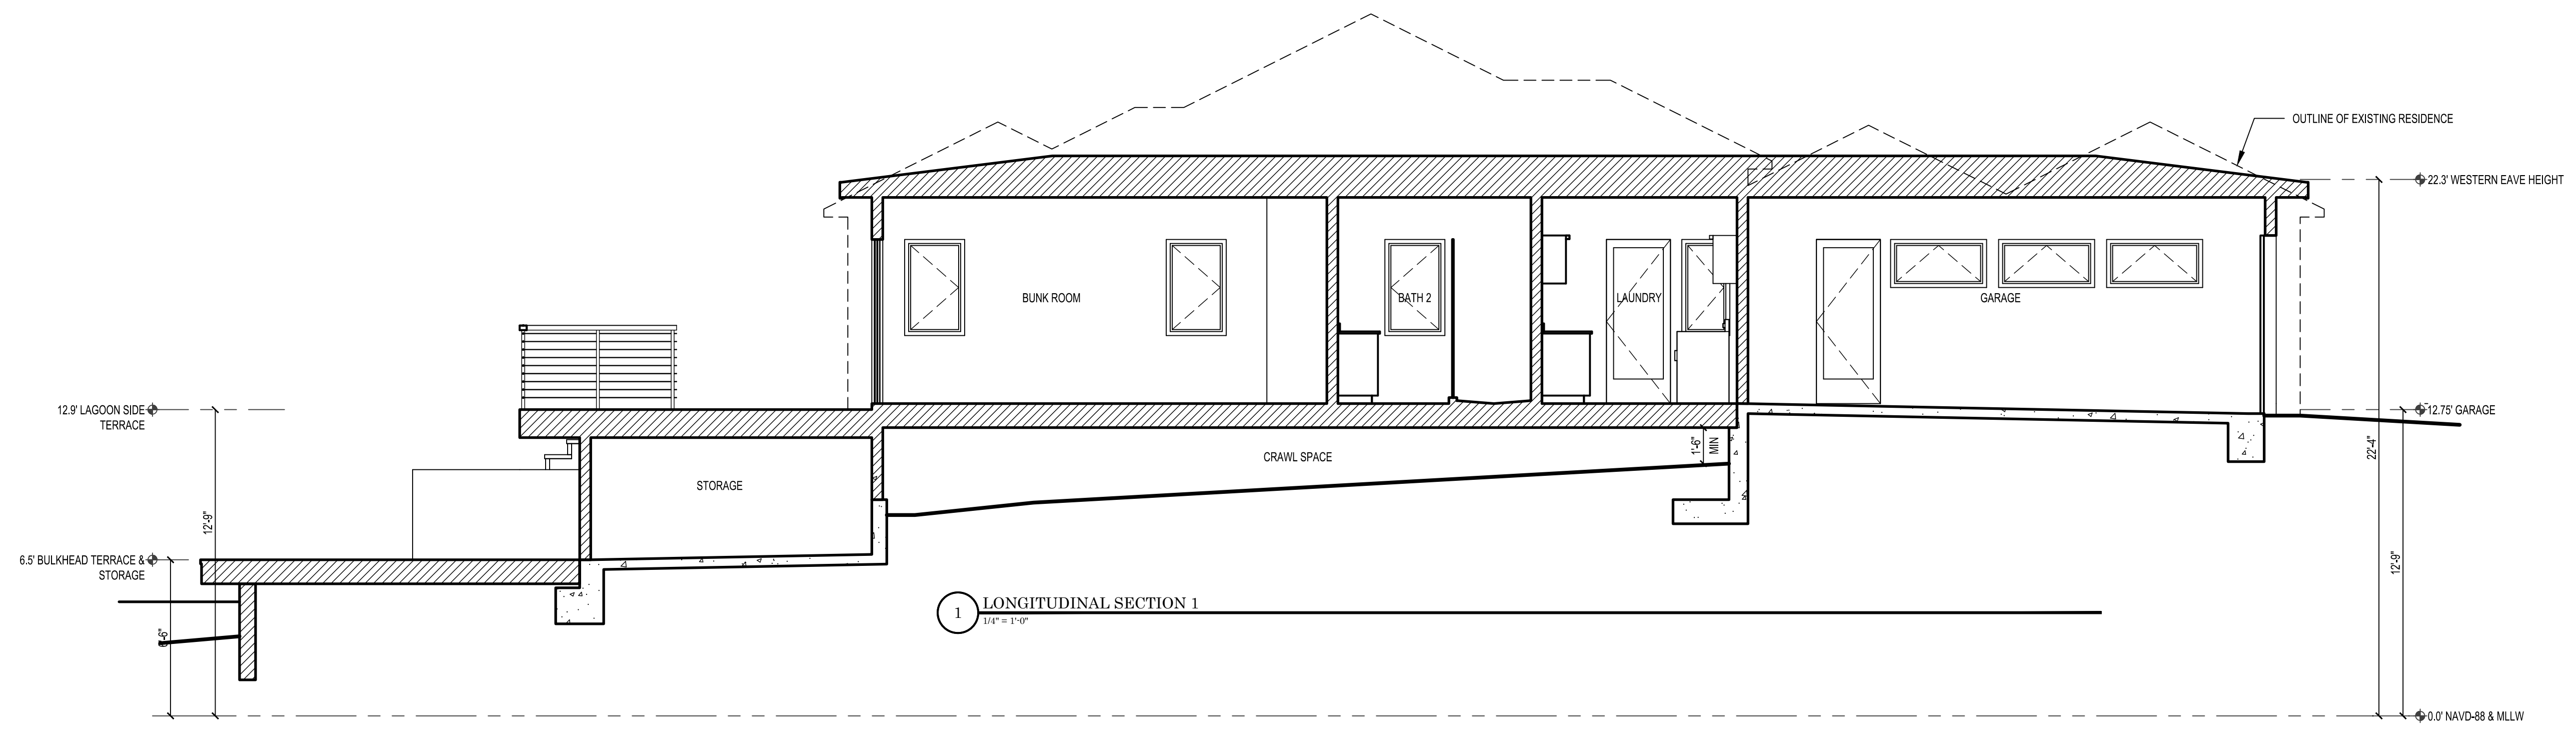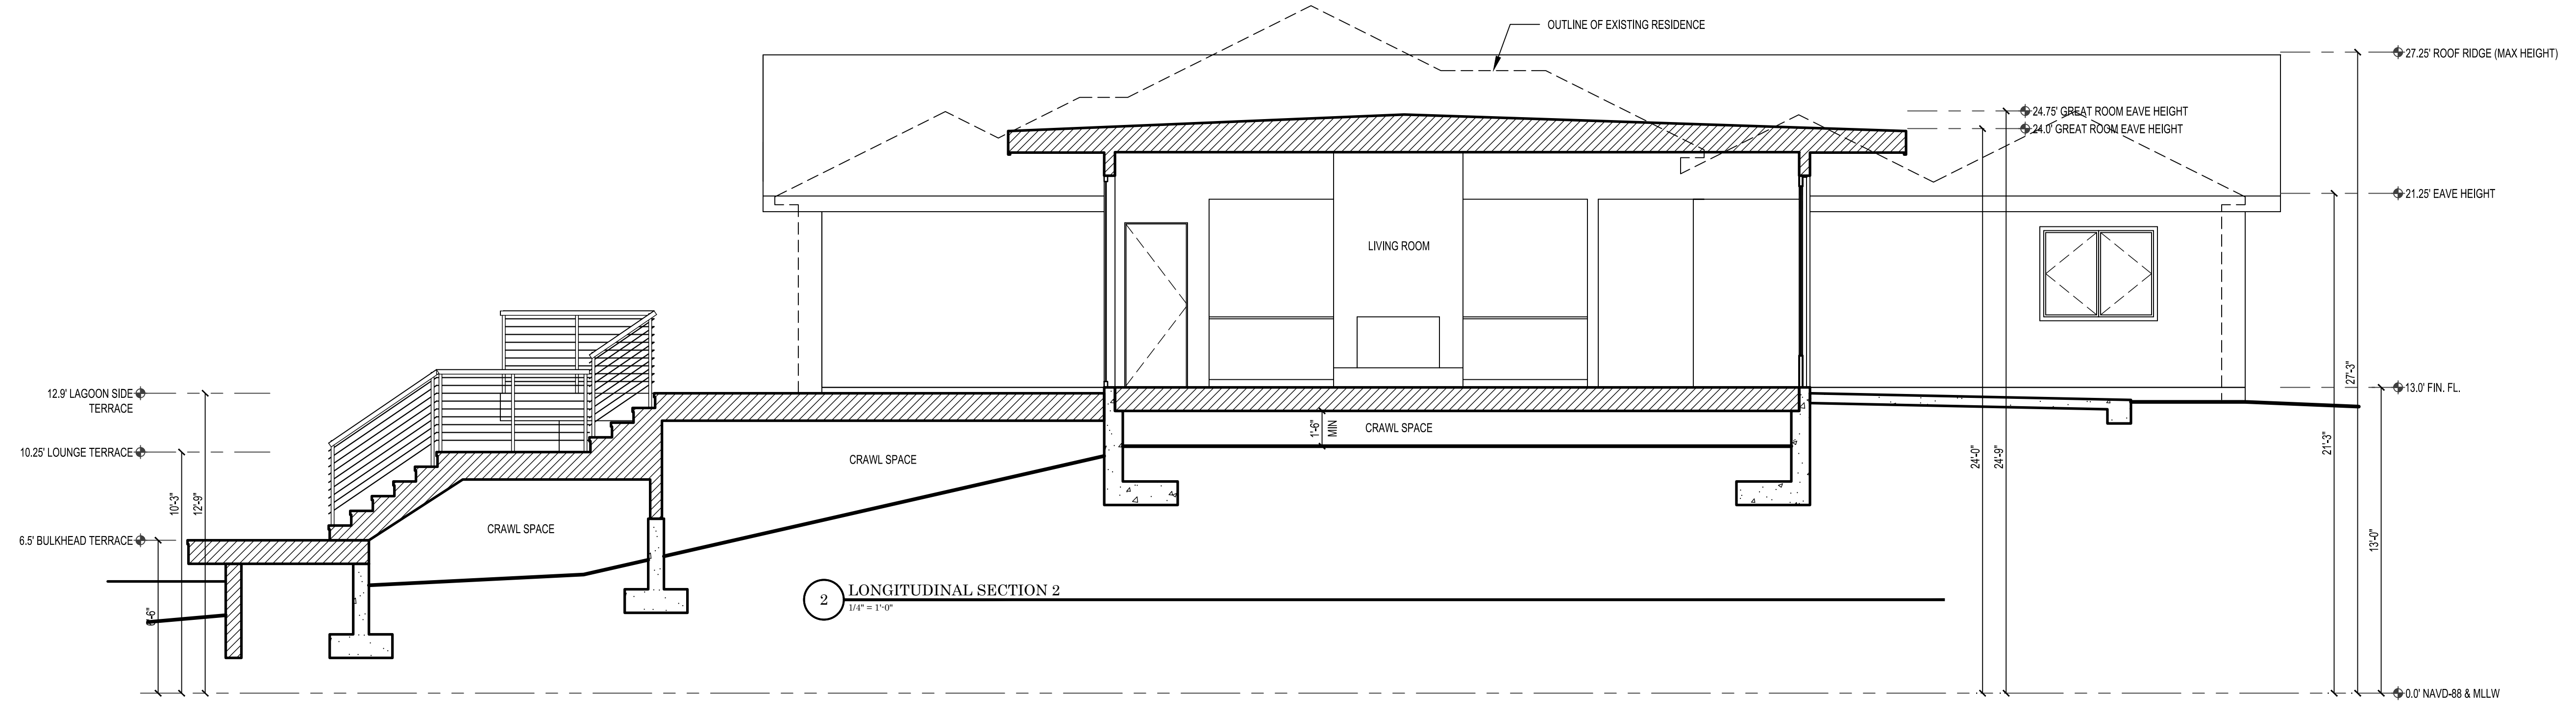

1 FLOOR PLAN
1/4" = 1'-0"


APPROXIMATE WATER LEVEL
EL. 4.9'

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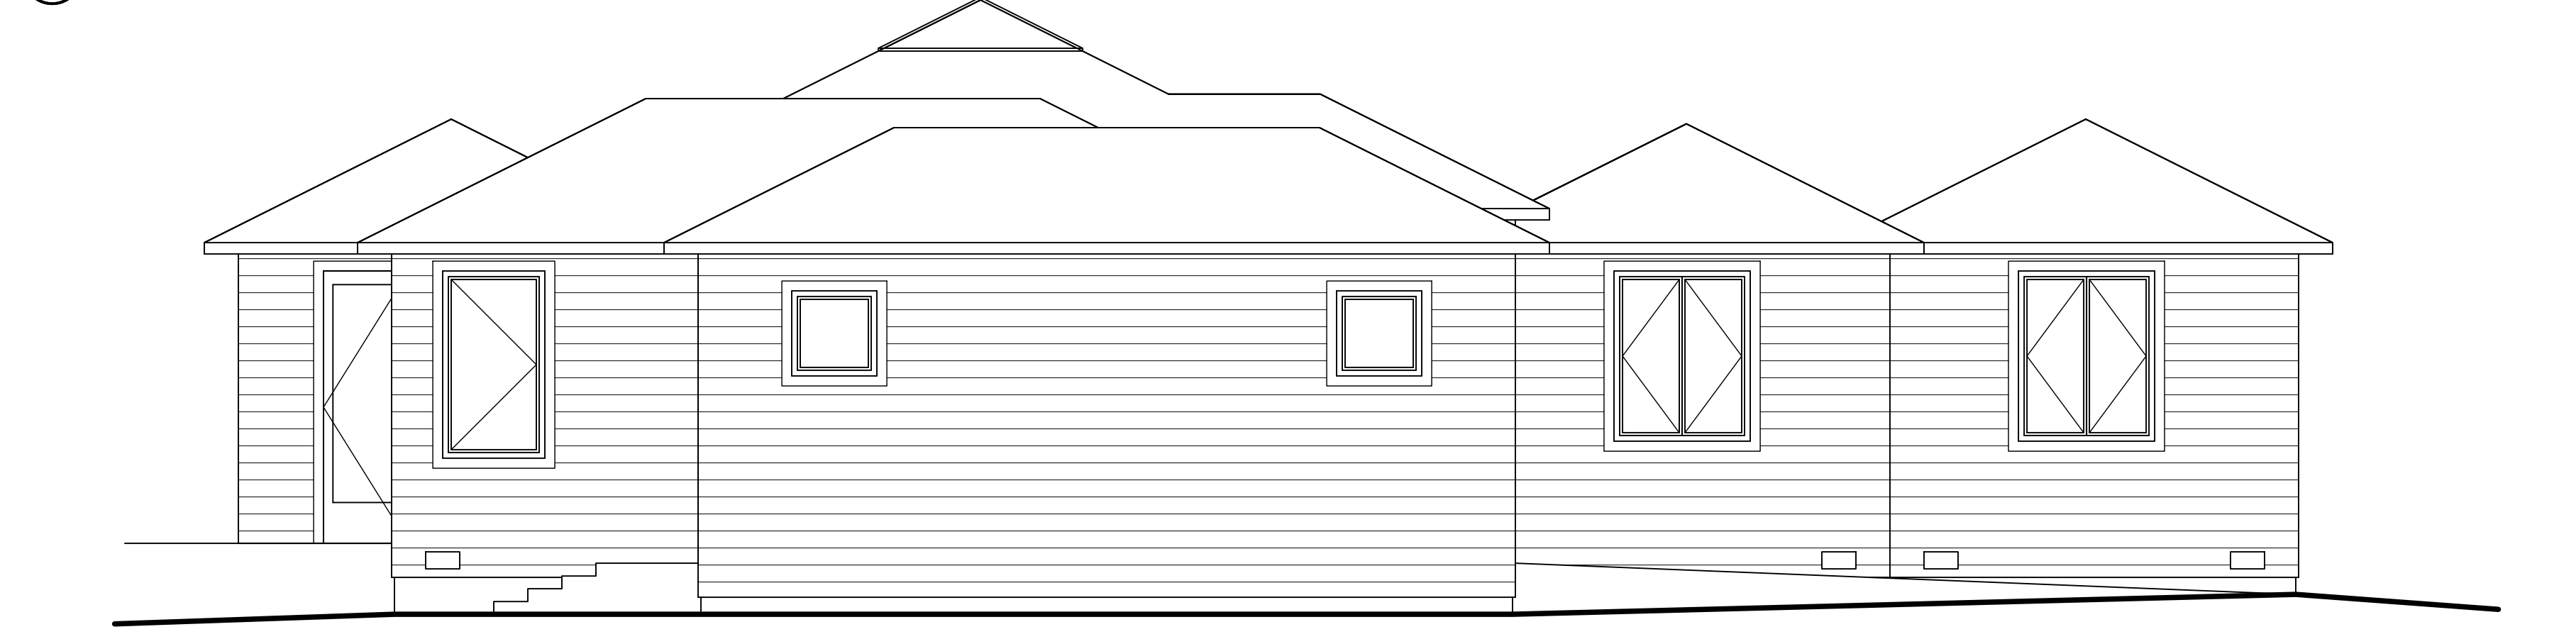
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JENSEN RESIDENCE
 43 DIPSEA ROAD, STINSON BEACH, CALIFORNIA


Scale: 1/4" = 1'-0"
 Refer: North



4 WEST ELEVATION
1/4" = 1'-0"

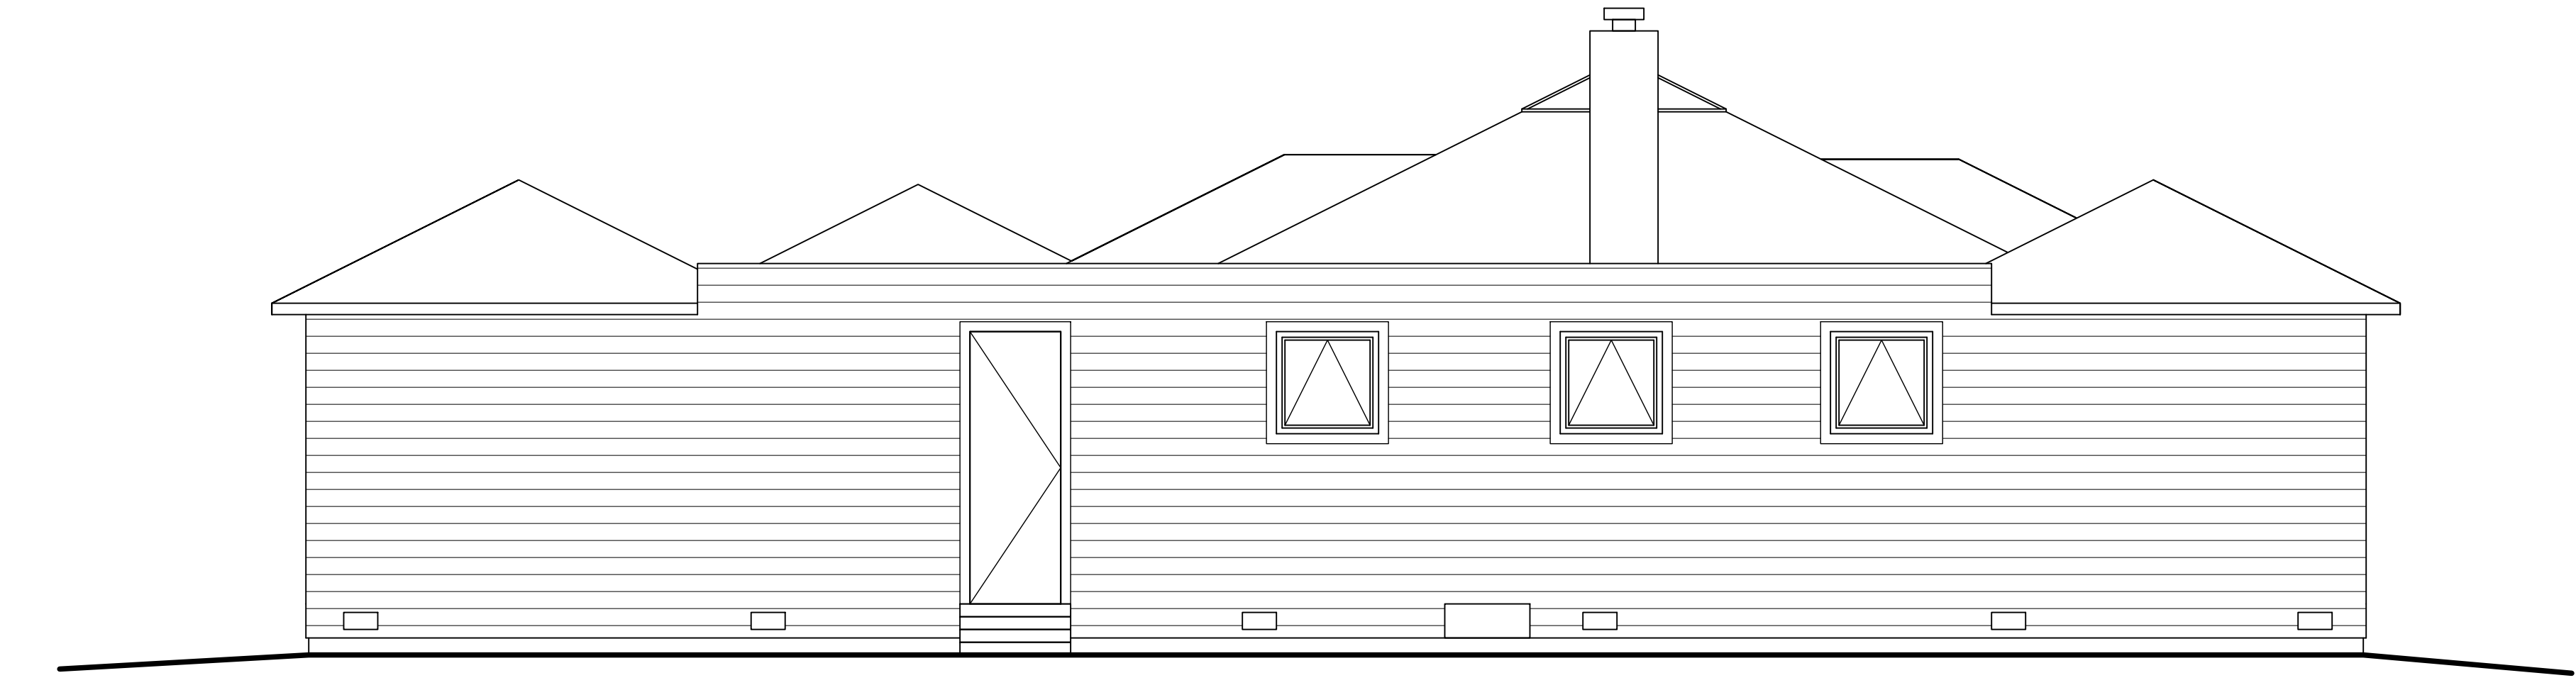

3 EAST ELEVATION
1/4" = 1'-0"

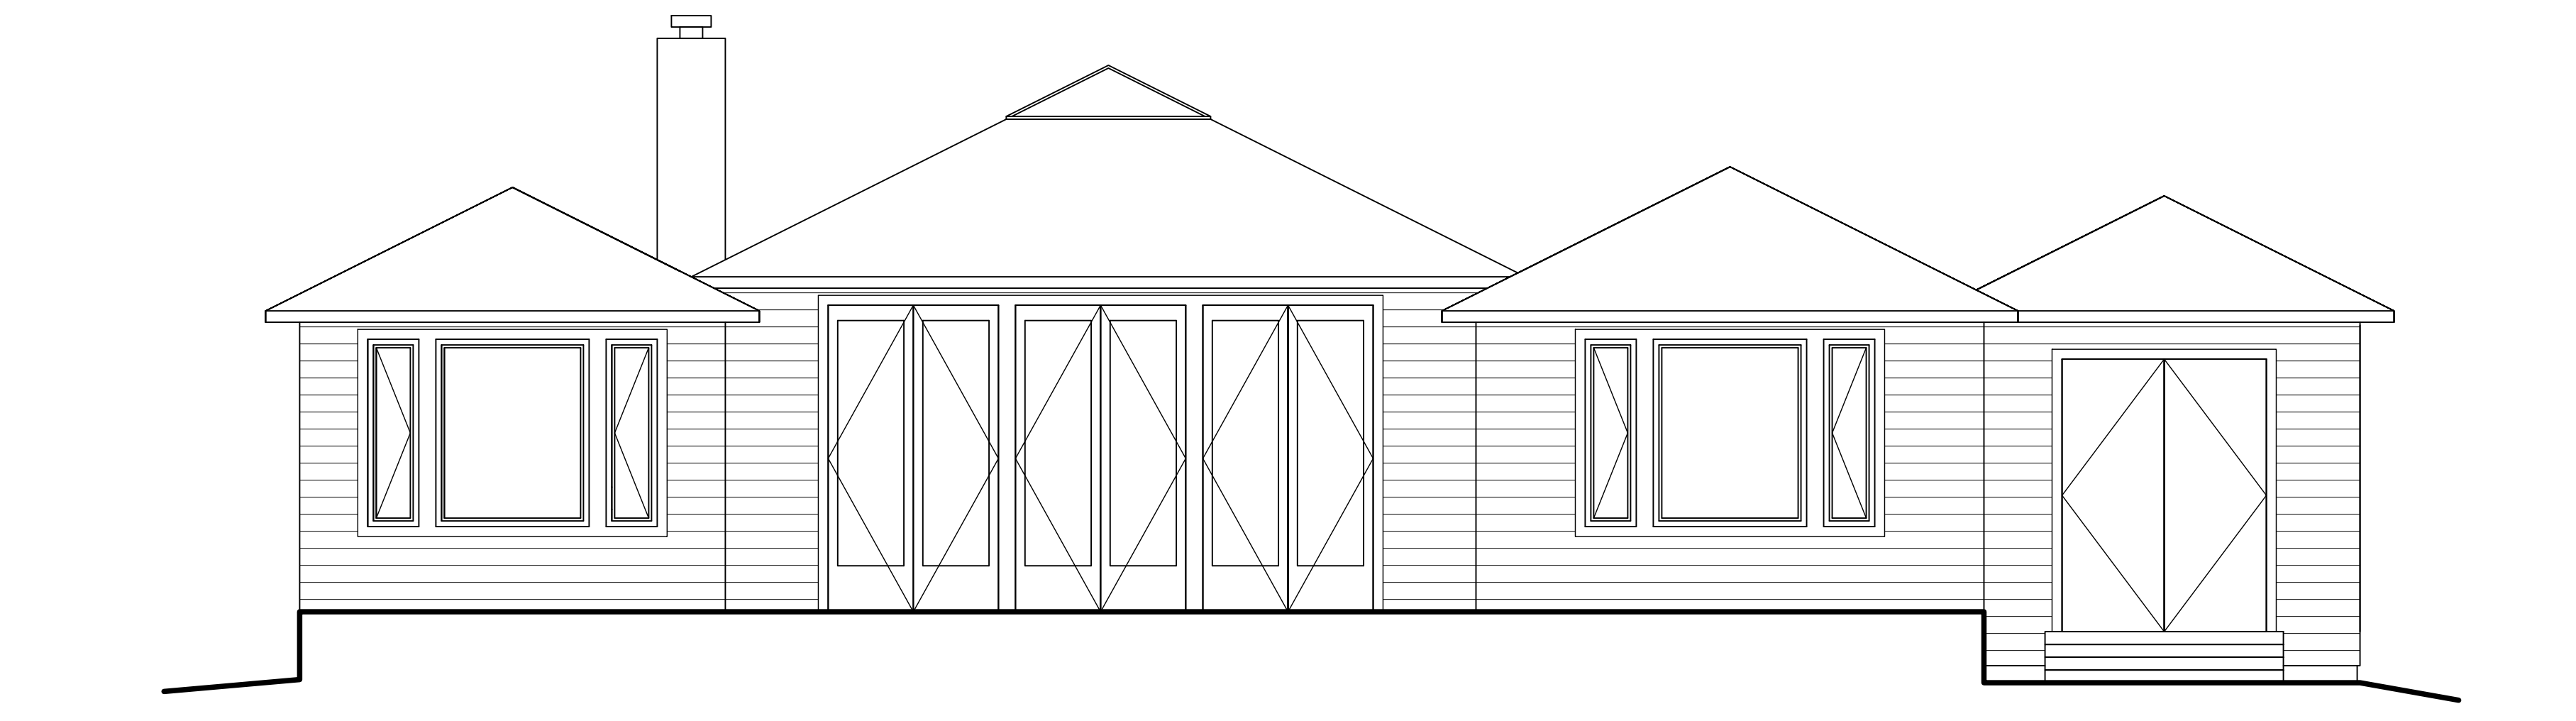

2 SOUTH ELEVATION
1/4" = 1'-0"



1 NORTH ELEVATION
1/4" = 1'-0"

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ARCHITECTS & PLANNERS
300 TAMMIL PLAZA SUITE 200 COSTA MESA CA 92625 415-924-1020


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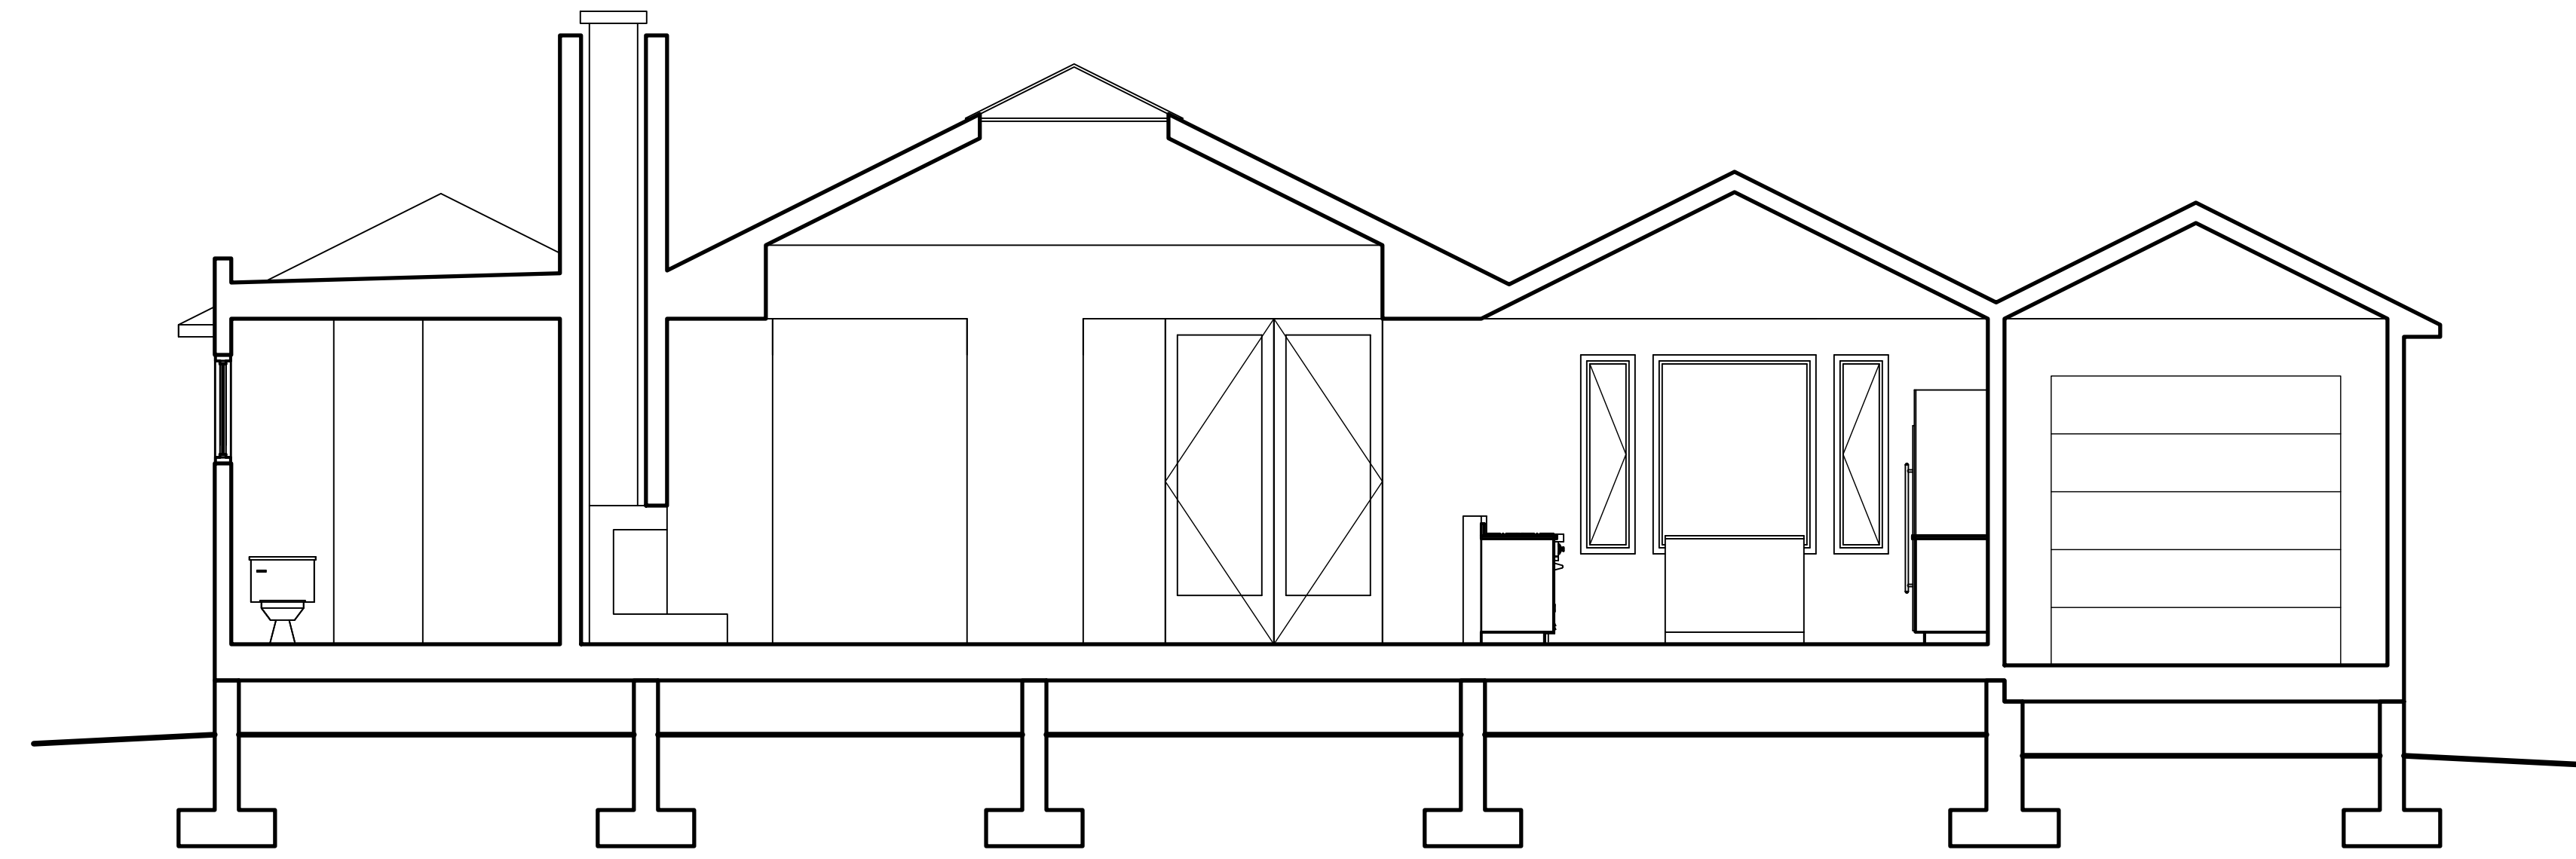
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43 DIPSEA ROAD, STINSON BEACH, CALIFORNIA

Scale
In 0 4 8 20
Feet

Refer.
North




2 EXISTING TRANSVERSE SECTION
1/4" = 1'-0"

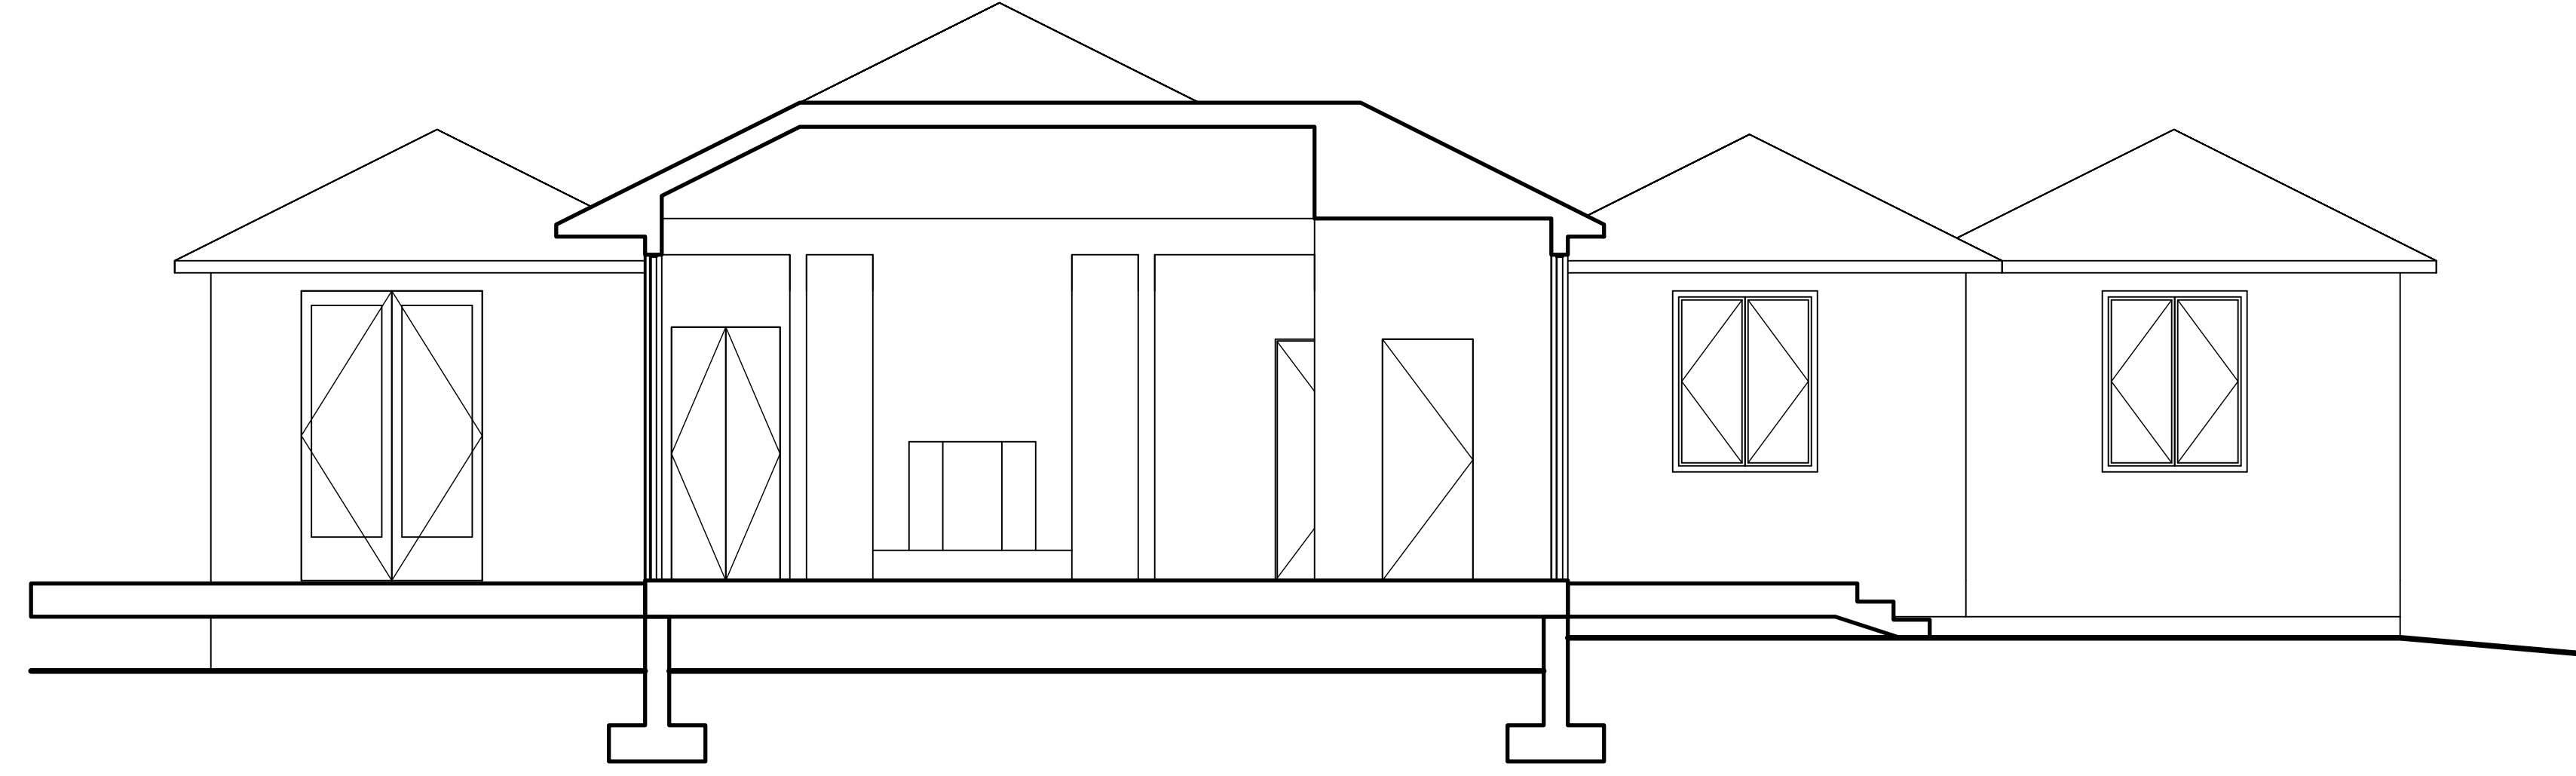

1 EXISTING LONGITUDINAL SECTION
1/4" = 1'-0"

JENSEN RESIDENCE
43 DIPSEA ROAD, STINSON BEACH, CALIFORNIA

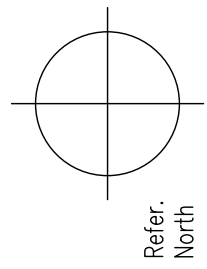


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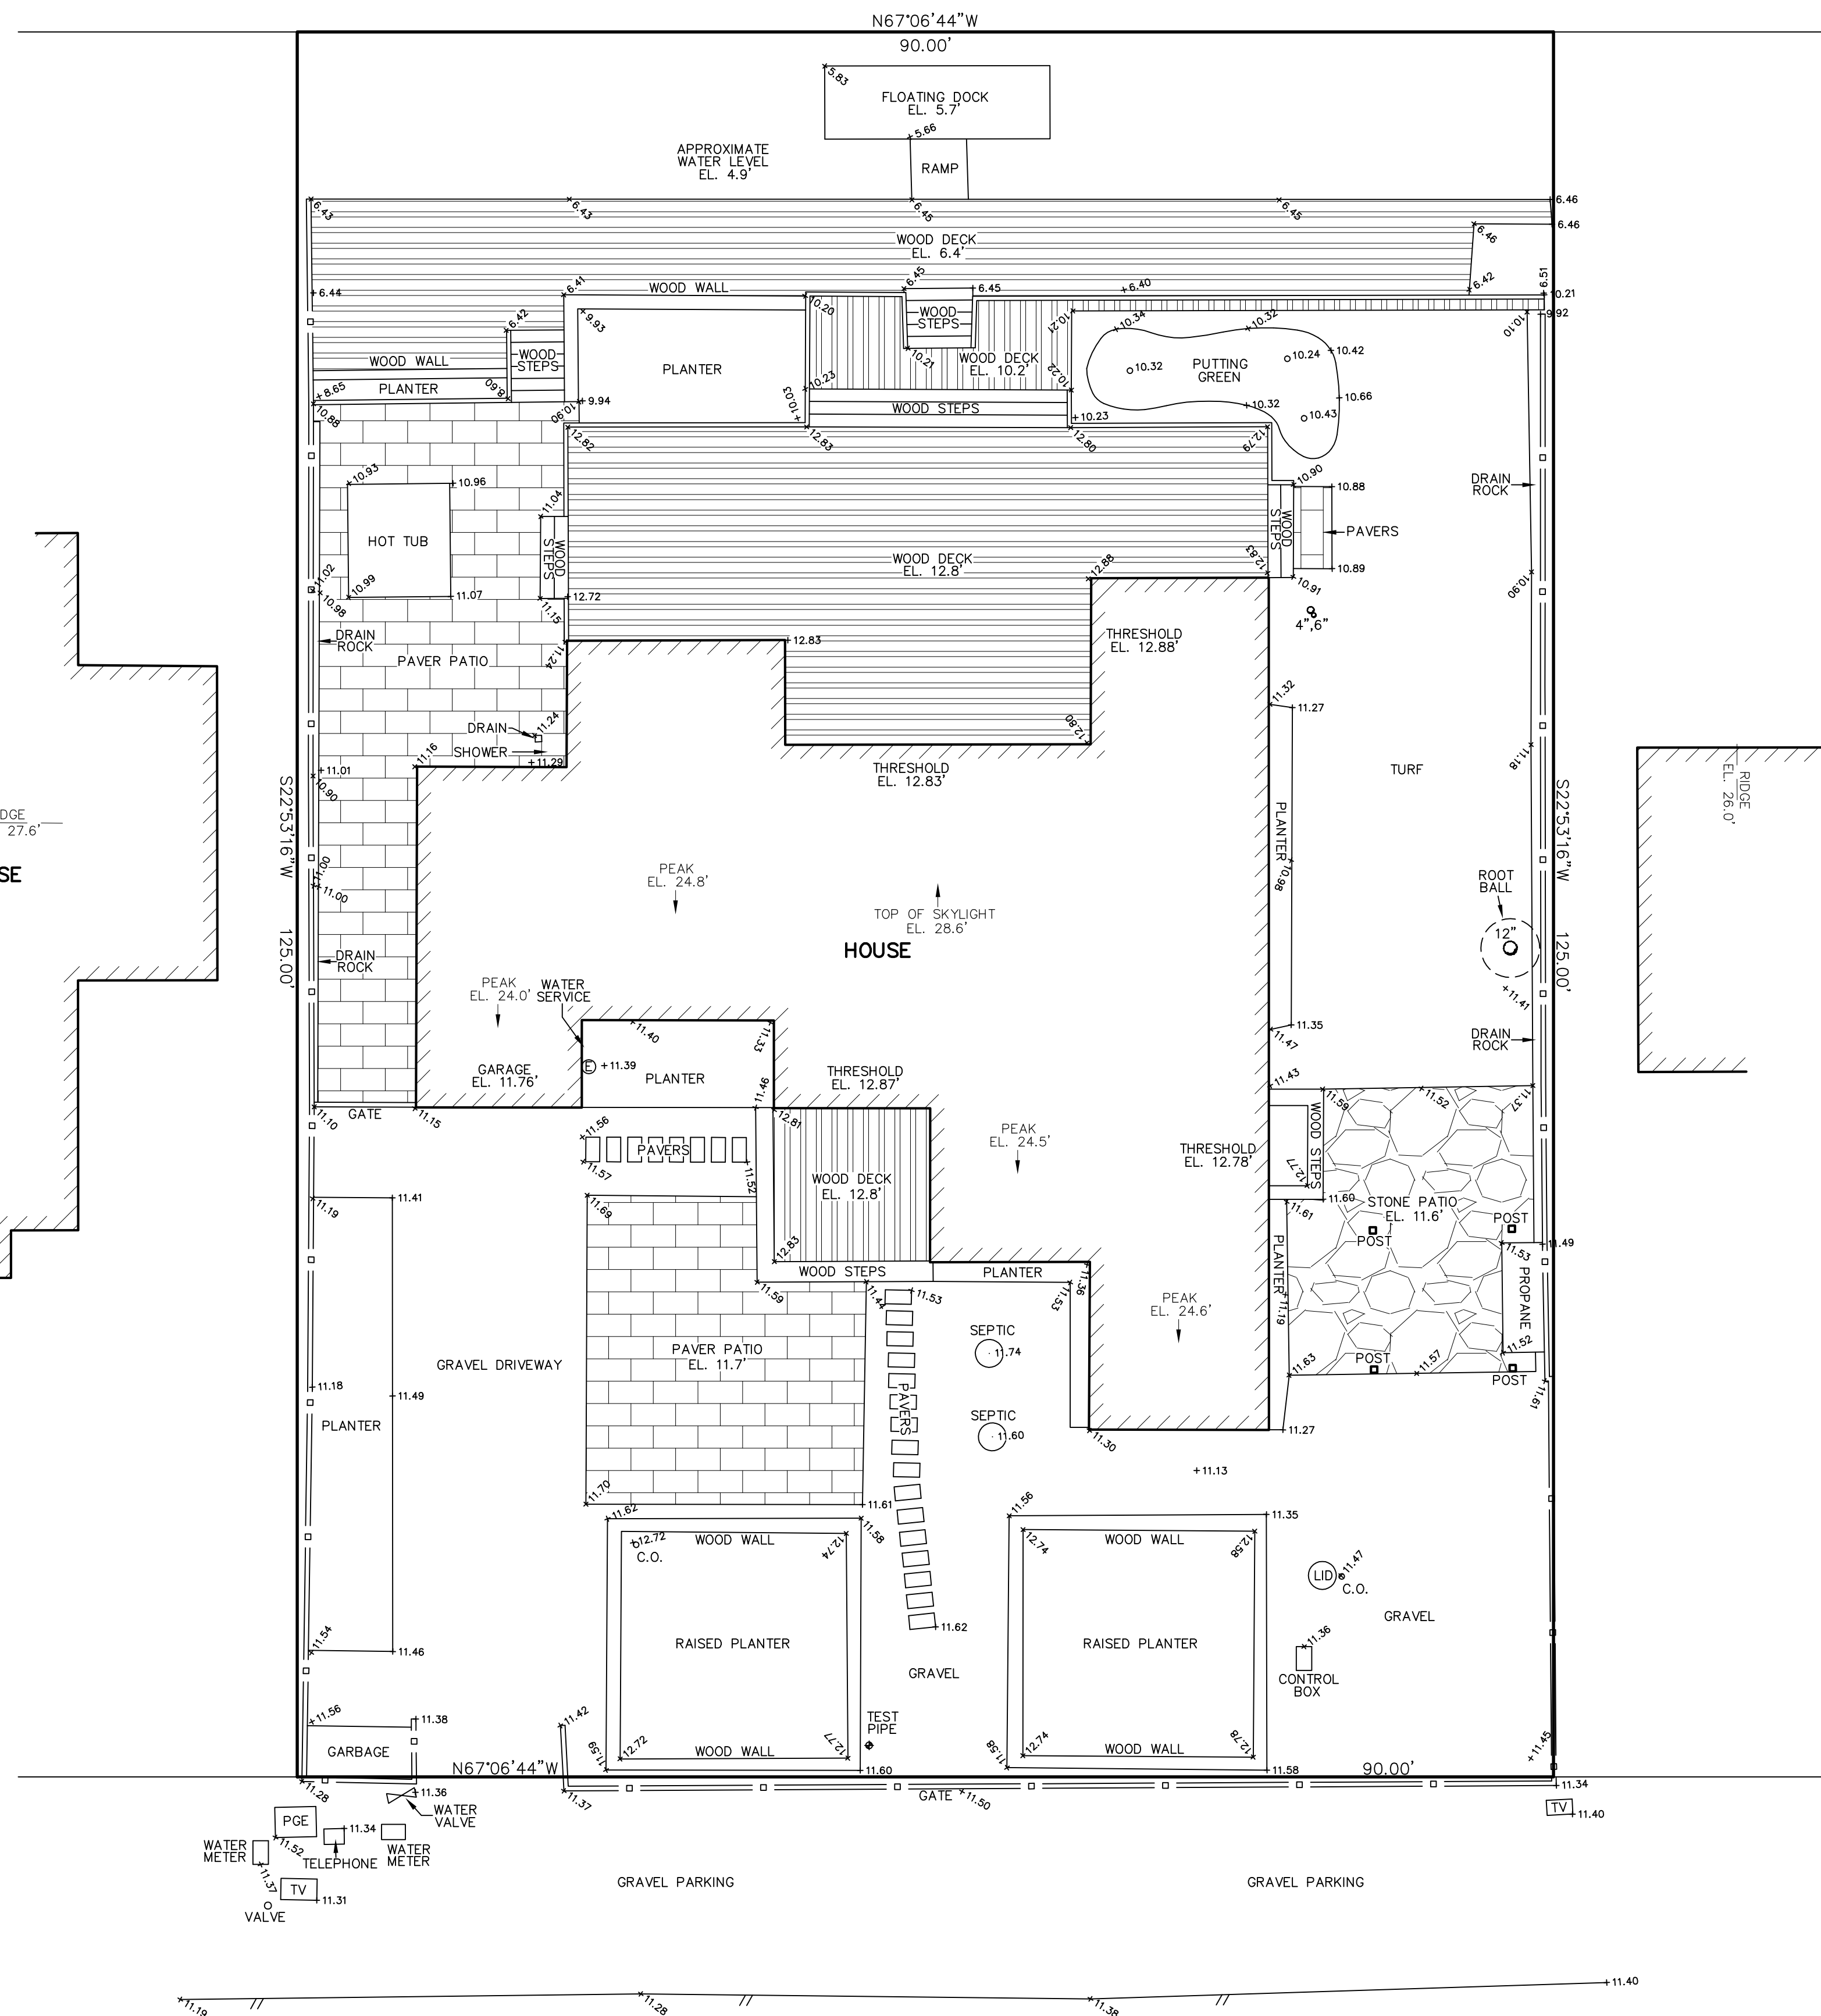
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300 TAMMIL PLAZA SUITE 200 COSTA MADERA CA 94125 415.927.1020



SEADRIFT LAGOON

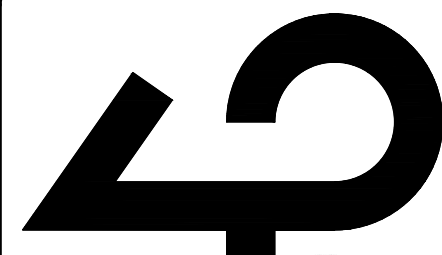


A.P. 195-090-42

HOUSE

A.P. 195-080-30

HOUSE

DIPSEA ROAD

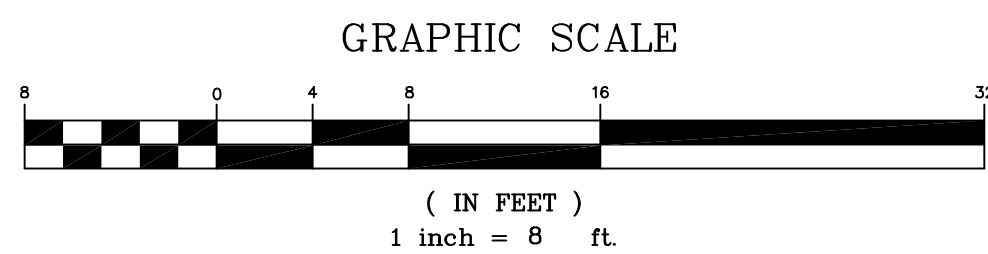


LEGEND

	TREE (AS INDICATED)
	TOP OF WALL ELEVATION
	CONCRETE
	GRADE BREAK
	WIRE FENCE
	WOOD FENCE
	EDGE OF PAVEMENT
	SURVEY CONTROL POINT
	JOINT POLE
	CONCRETE WALL
	ROCK WALL
	ROCK BORDER
	ELECTRIC / GAS METER
	OVERHEAD LINES

- NOTES**
1. ONLY SIGNIFICANT TREES SHOWN
 2. LOT MAY BE SUBJECT TO EASEMENTS NOT SHOWN
 3. DATUM IS NAVD 88 PER M-4, 2018 M 172
 4. BOUNDARY IS LOT 119 PER 22 O.S. 33

LAWRENCE DOYLE
LAND SURVEYOR
CIVIL ENGINEER
100 HELENS LANE
MILL VALLEY, CA 94941
415 388 9585 F 415 388 0412

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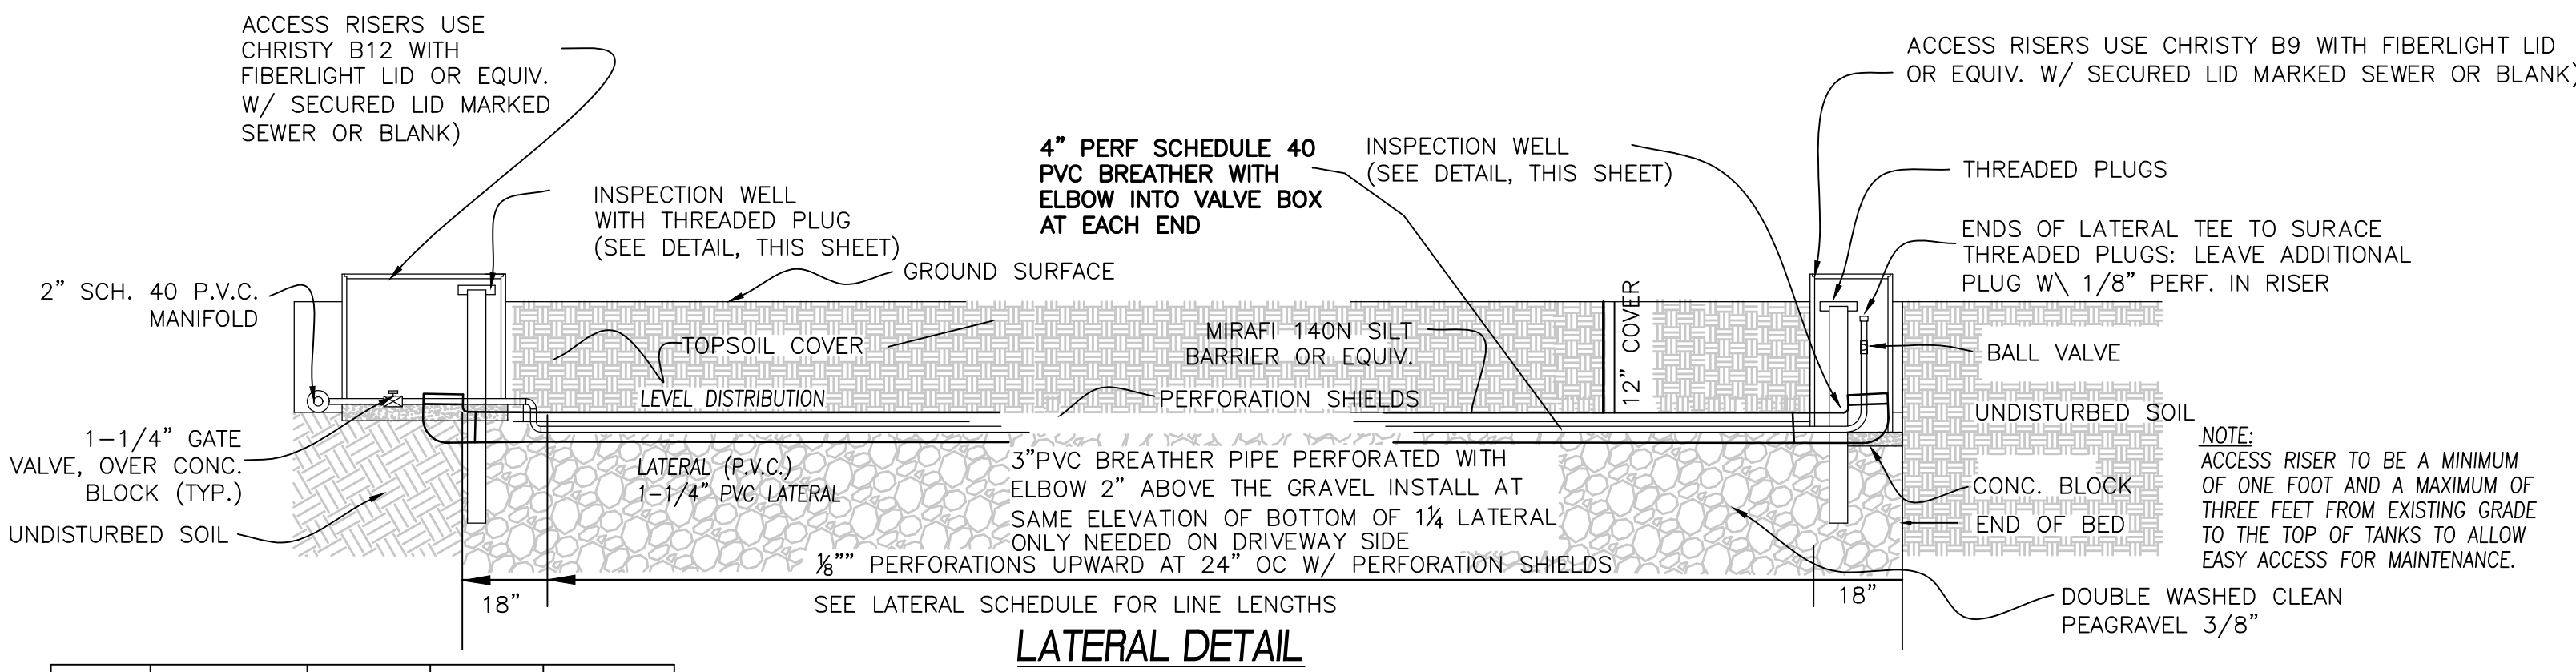


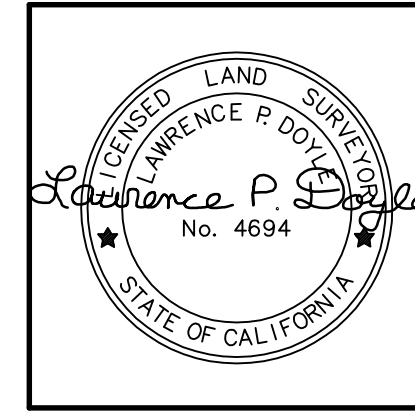43 DIPSEA RD.
STINSON BEACH CALIFORNIA
A.P. 195-090-43

TOPOGRAPHIC SURVEY

DRAWN BY: CPD
DATE: 1/14/21
ISSUE: _____


C-1
DRAWING NUMBER: 2902
SHEET 1 OF 1




No.	DIAMETER	PERF SIZE	LENGTH	# OF PERFS'S
A1	1 1/4"	3/8"	34	17
A2	1 1/4"	3/8"	34	17
A3	1 1/4"	3/8"	34	17
A4	1 1/4"	3/8"	34	17
B1	1 1/4"	3/8"	34	17
B2	1 1/4"	3/8"	34	17
B3	1 1/4"	3/8"	34	17
B4	1 1/4"	3/8"	34	17

LATERAL SCHEDULE
NOT TO SCALE


LATERAL DETAIL

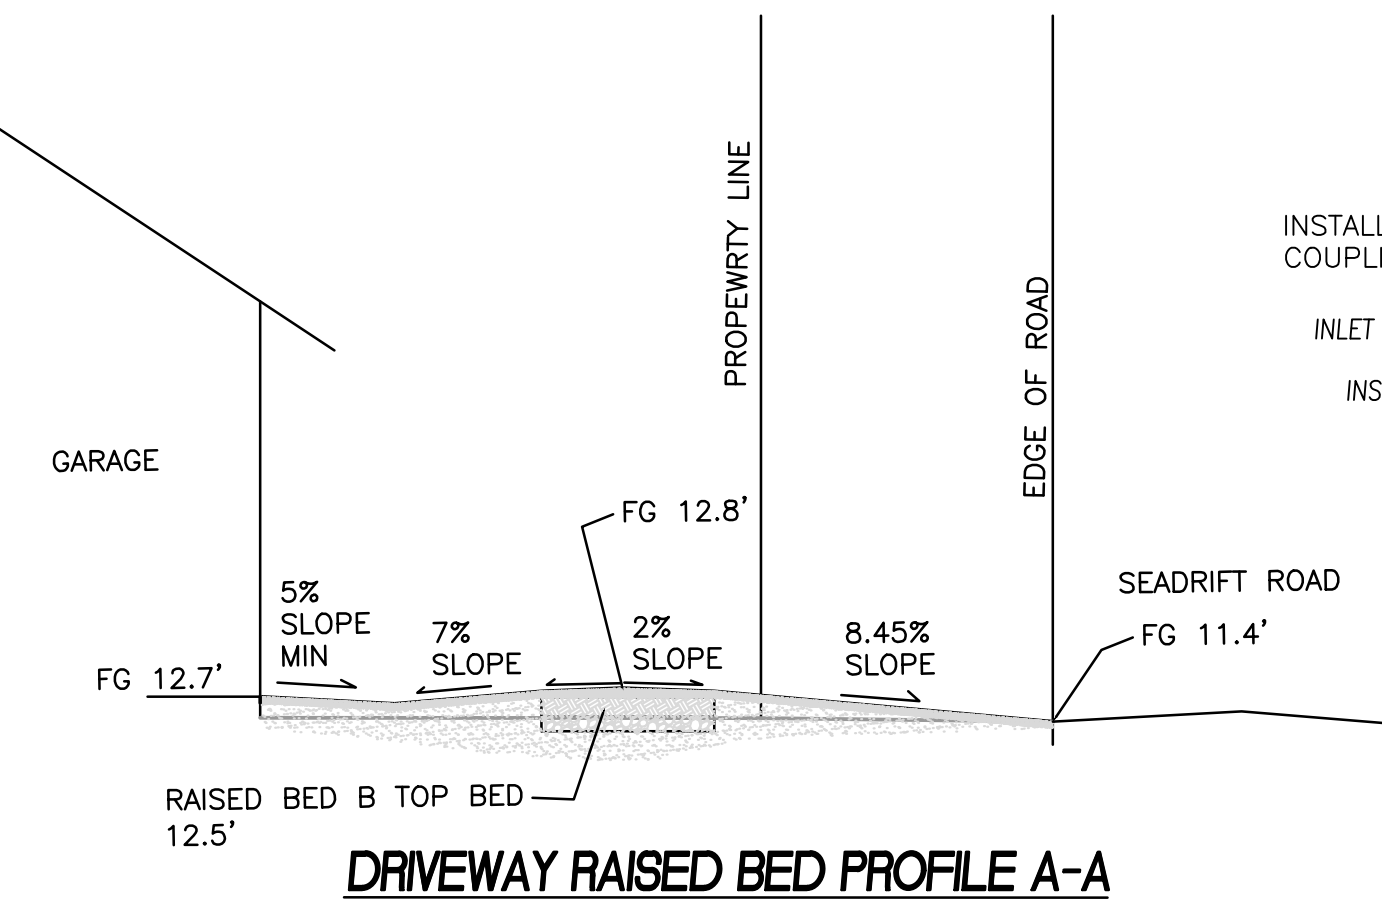


DRIVEWAY RAISED BED PROFILE A-A

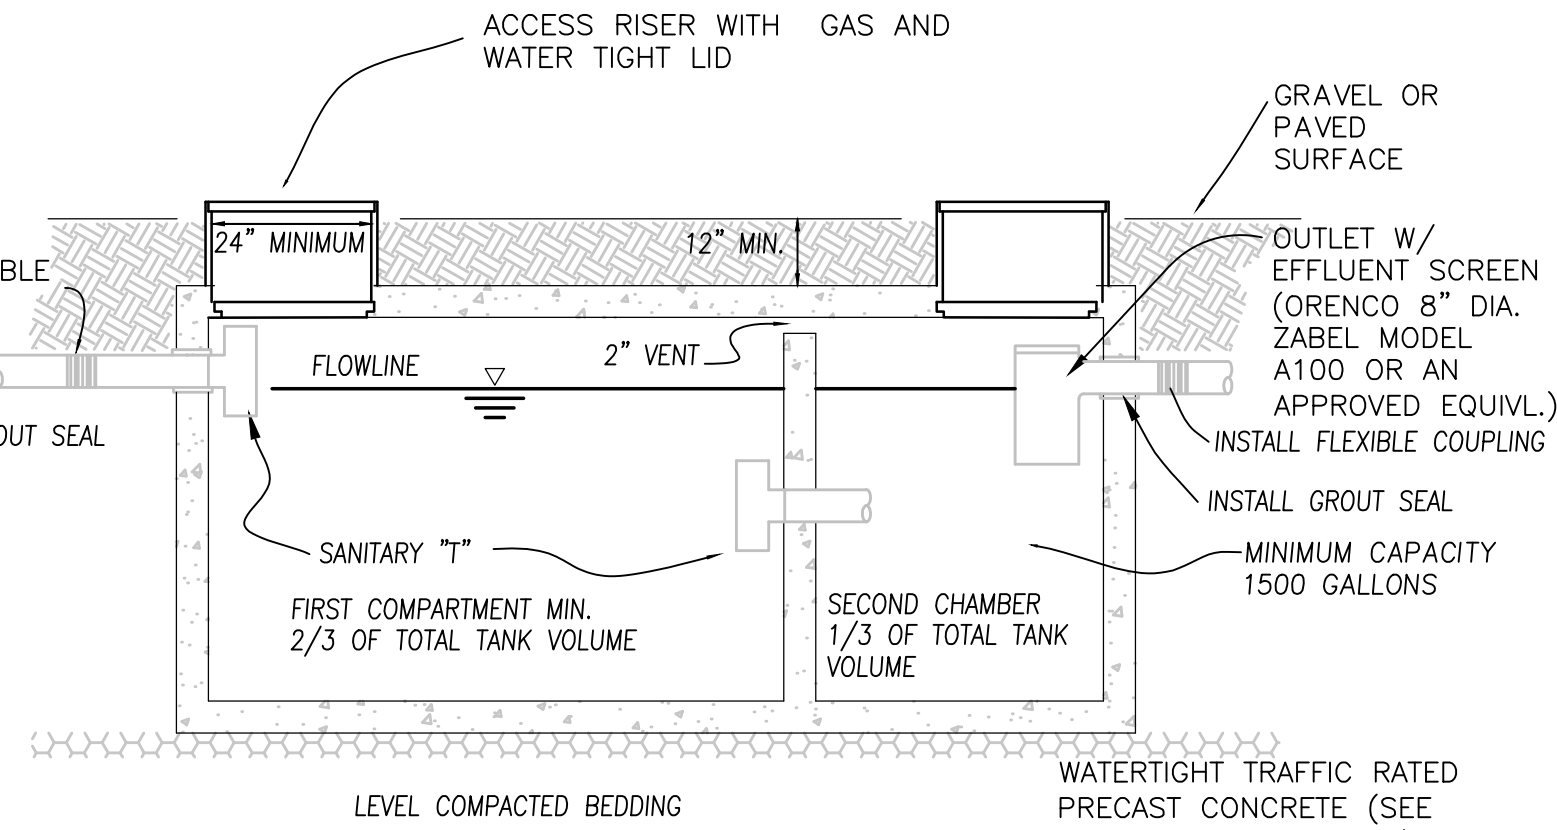

1500 GALLON SEPTIC TANK DETAIL (TYP.)
NOT TO SCALE

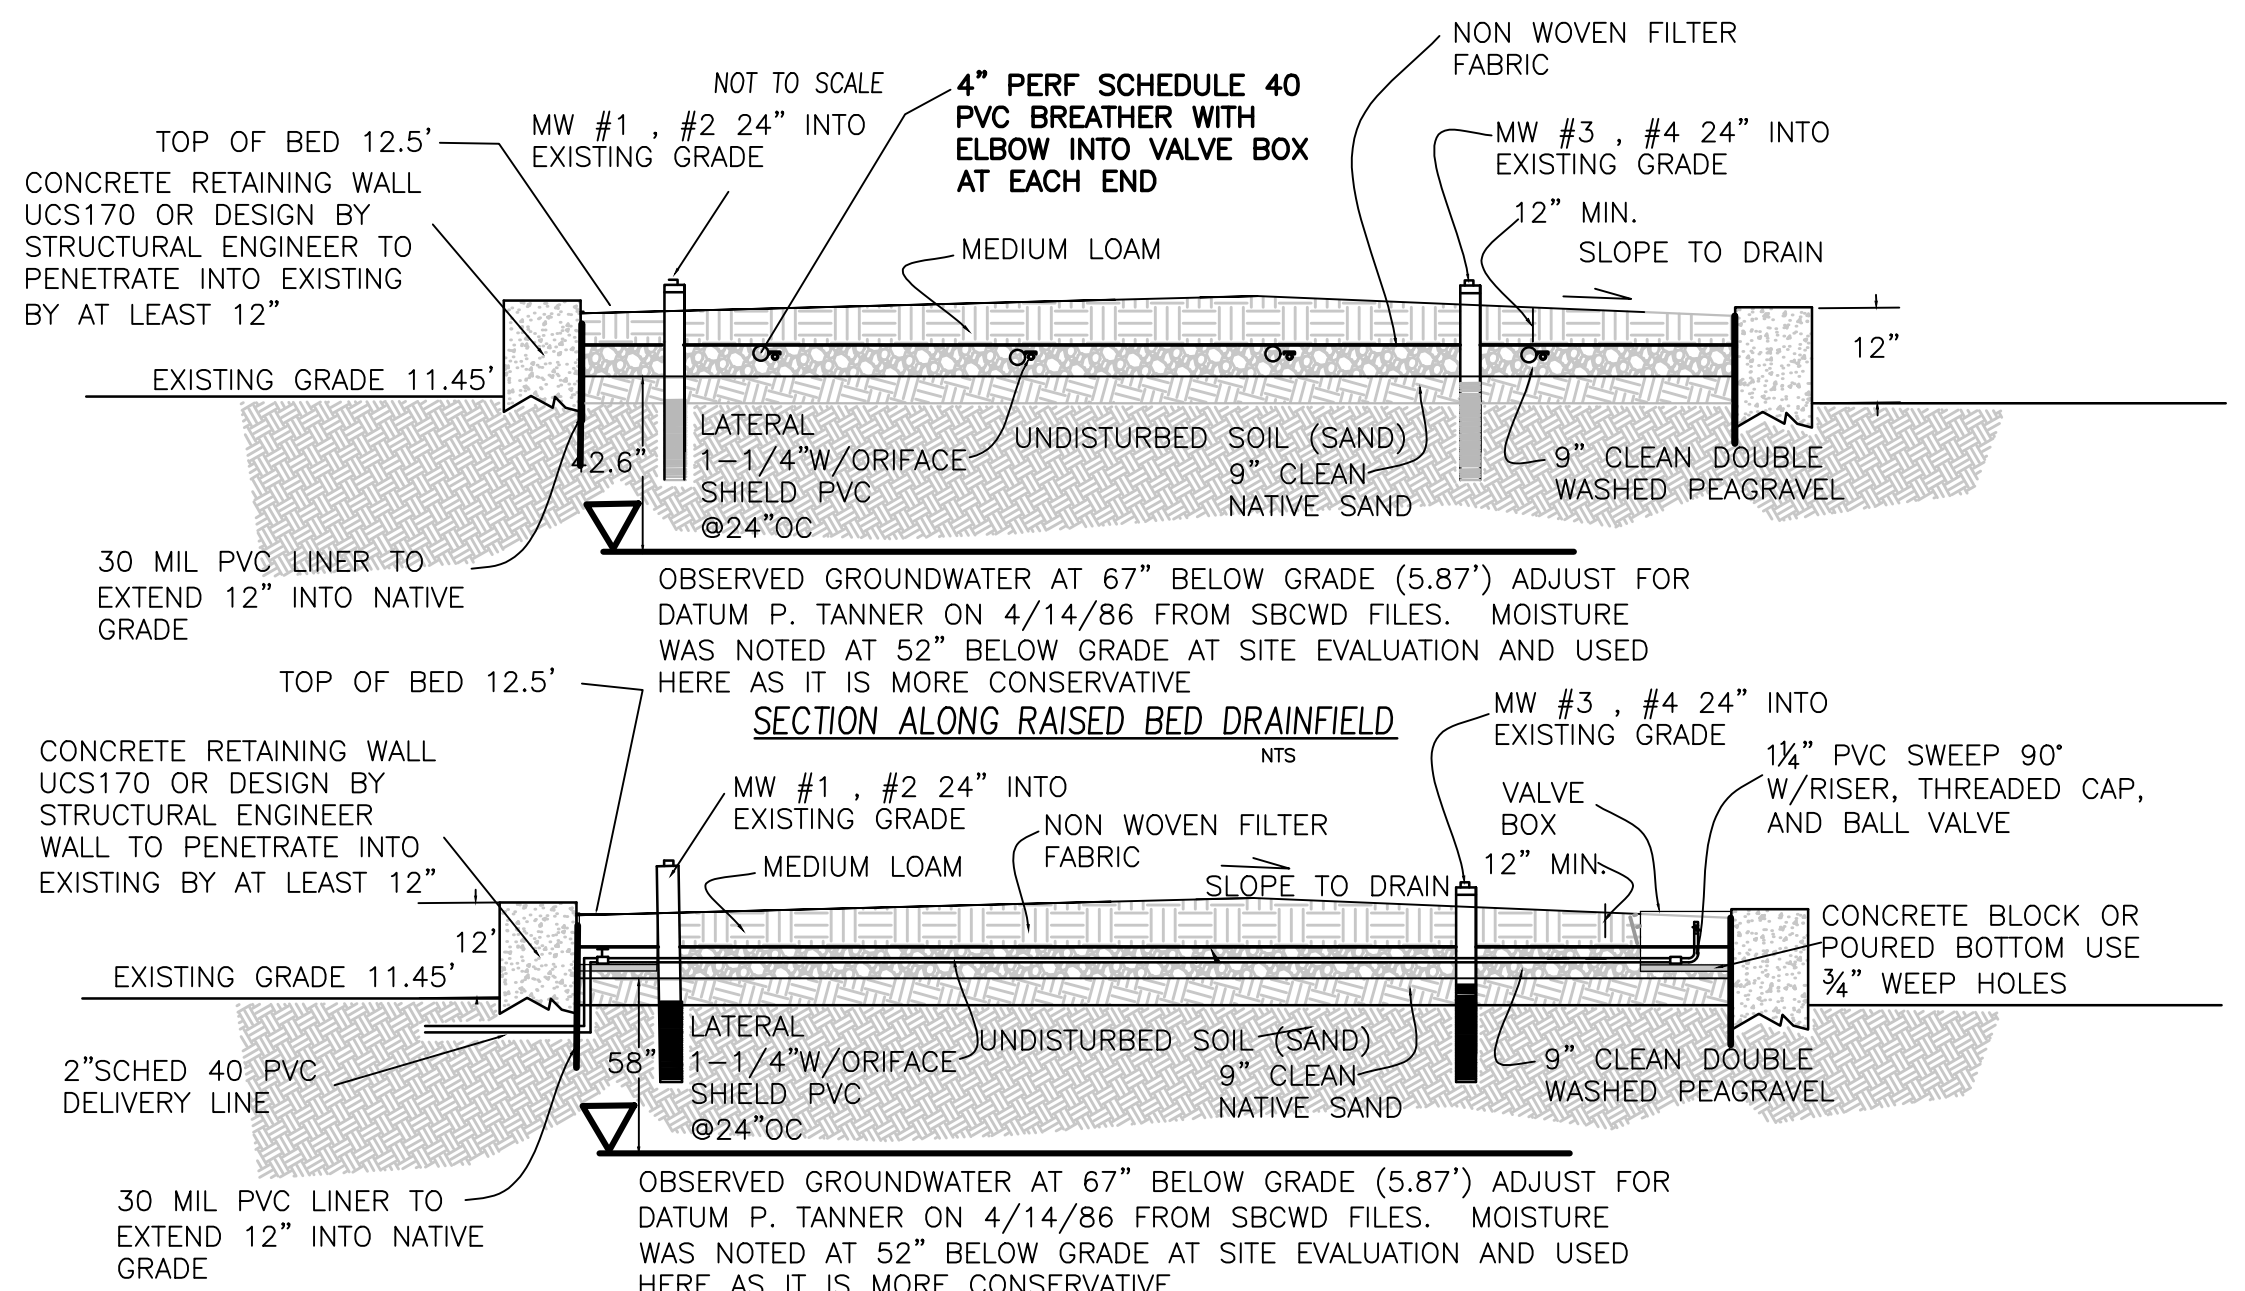


SECTION ALONG RAISED BED DRAINFIELD

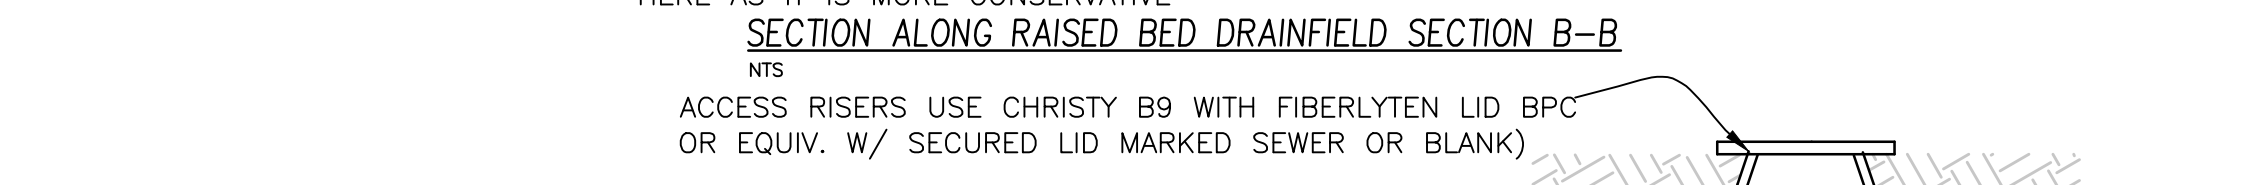


SECTION ALONG RAISED BED DRAINFIELD SECTION B-B

- TANK WATER TIGHTNESS TEST**
- CAP OR TEST PLUG ALL INLETS AND OUTLETS TO TANK.
 - FILL TANK WITH WATER TWO INCHES INTO THE RISER AND MARK WATER LEVEL. SCHEDULE WITH ENGINEER AND NECM 24 HOURS BEFORE FILLING TANK.
 - IF AFTER 24 HOURS WATER LEVEL DROPS, TANK MUST BE MADE WATER TIGHT BY APPLYING WATER PROOF SEALER (NOT BITUMINOUS PRODUCT) THORPLUG, THORSEAL OR OTHER PORTLAND CONCRETE CEMENT PRODUCT.

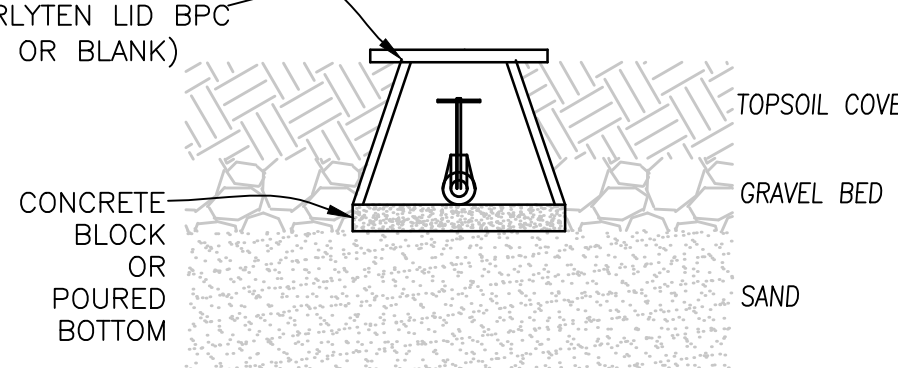

VALVE BOX DETAIL
NOT TO SCALE

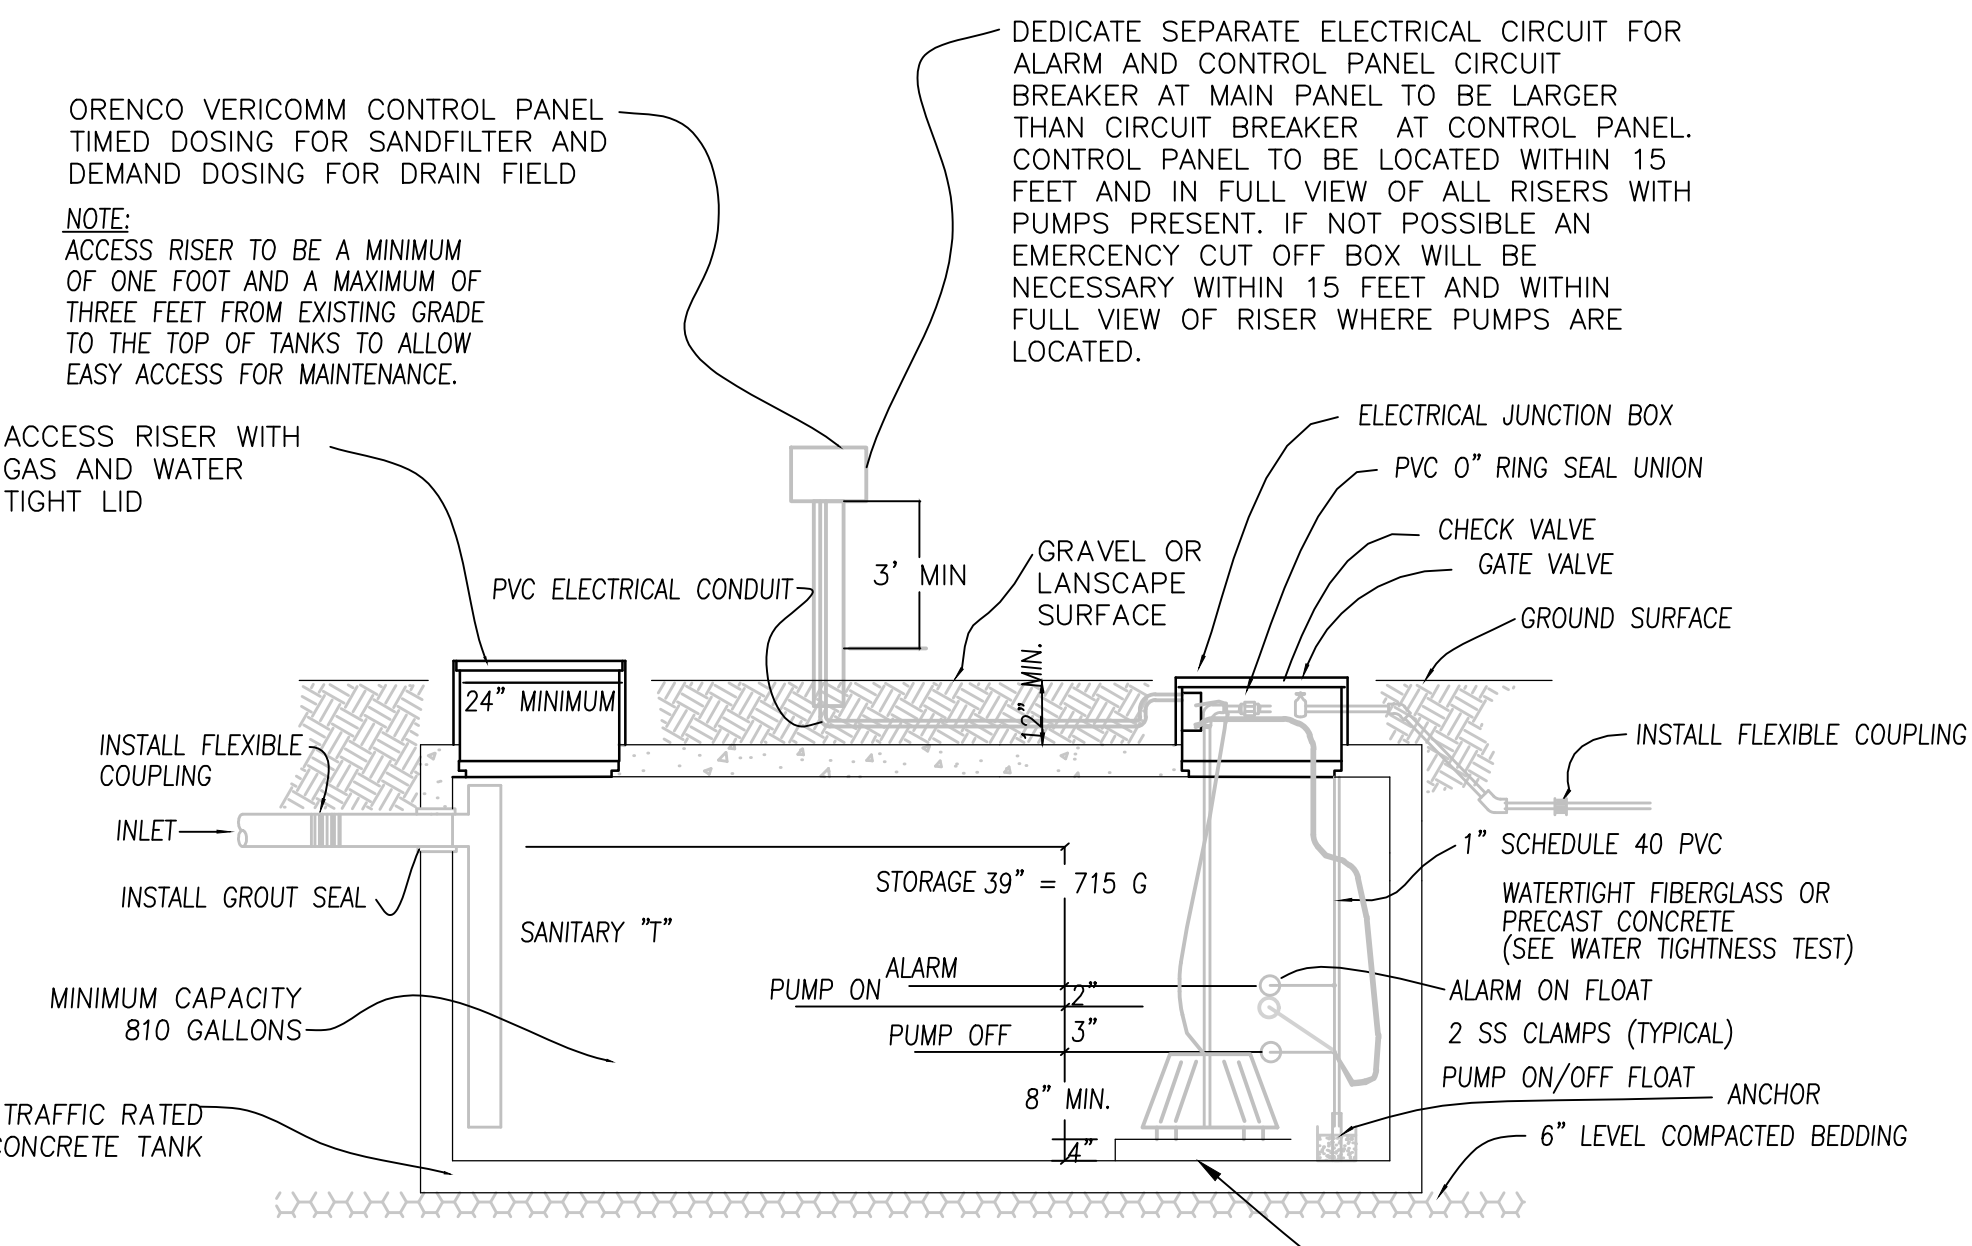


PS#1 810 GALLON SUMP TANK DETAIL
NOT TO SCALE

PS#1 FROM SMALL SIDE SUMP TO RAISED BED
TOTAL DYNAMIC HEAD = 24 FT
GALLONS PER MINUTE (GPM) = 23 GPM
DOSE = 35 GALLONS
OPERATION RANGE = 3.0"
RECOMMENDED PUMP TYPE: GOULDS MODEL 3885 WE0512H (.5 HP, 230 VOLTS, SINGLE PHASE, 7.3 AMPS).

IF TIMER CONTROLLED
T OFF 1 HR 58M
T ON 1.5 M

T OVERRIDE OFF 30 MINS
T OVERRIDE ON 1.5 MINS
RECOMMENDED CONTROL PANEL:
SEE CONTROL PANEL REQUIREMENTS THIS PAGE.

PUMP REQUIREMENTS PS#2
FROM SAND FILTER TO DRAIN FIELD
TOTAL DYNAMIC HEAD = 27 FT
GALLONS PER MINUTE (GPM) = 35
DOSE = 60 GALLONS
OPERATION RANGE = 6"
SUMP STORAGE = DRAINING THE GRAVEL FROM SAND FILTER >600 GAL
RECOMMENDED PUMP TYPE GOULDS MODEL 3885 WE1012H OR APPROVED EQUAL RECOMMENDED CONTROL PANEL ORENCO MVP-SSF WITH TIMER FOR PUMP TO SAND FILTER AND DEMAND TO DRAIN FIELD

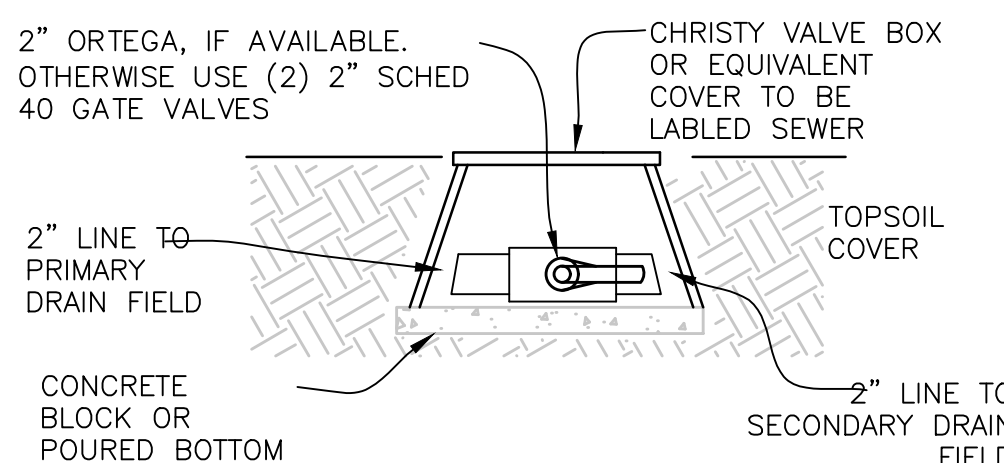

DIVERSION VALVE BOX DETAIL
NOT TO SCALE

GENERAL NOTES

- CONTRACTOR TO NOTIFY STINSON BEACH COUNTY WATER DISTRICT (SBCWD) PERSONEL AND DESIGN ENGINEER 48 HOURS PRIOR TO BEGINNING CONSTRUCTION.
- NOT TO BE USED AS A BOUNDARY SURVEY- SURVEYOR TO STAKE ALL PROPERTY LINES AND EASEMENTS. SURVEY PROVIDED BY LAWRENCE P DOYLE 415-388-9585
- MAINTAIN 10' SEPARATION FROM ANY SEWAGE LINE TO WATERLINE IF NOT POSSIBLE REROUTE TO MAINTAIN SEPARATION. CROSSING SHALL BE MADE WITH WATER ABOVE SEWER LINE WITH BOTH LINES SLEEVED WITHIN 10' OF EACH OTHER.
- NO CUTS SHALL BE MADE DOWNSLOPE OF DRAINFIELD WITHOUT PERMISSION OF BOTH SBCWD AND DESIGN ENGINEER.
- CONSULT ENGINEER PERTAINING TO LANDSCAPE SEPTIC SYSTEM.
- NO MATERIAL SUBSTITUTION WITH OUT DESIGN ENGINEER APPROVAL.
- ALL TANKS TO BE WATER TIGHT-SEE WATER TIGHTNESS TEST.
- CONTRACTOR NOT TO OVEREXCAVATE THE DELIVERY LINE TRENCH/S. MAXIMUM DEPTH OF TRENCH IS 24 INCHES.
- THIS SYSTEM CALLS FOR A DIVERSION VALVE/S WHICH ARE TO BE HOUSED IN A SUBSTANTIAL VALVE BOX. THE BOX IS TO BE EXTENDED TO 3 INCHES ABOVE GRADE. THE VALVE SHOULD BE ALTERNATED EVERY SIX MONTHS.
- EROSION PROTECTION SHALL BE PLACED IN ALL DISTURBED AREAS. STRAW AND SEED SHALL BE PLACED AT A MINIMUM PRIOR TO FINAL INSPECTION.
- ALL SEWER LINES FROM BUILDINGS SHALL BE 3 INCH SDR 35 OR APPROVED EQUIVALENT WITH A MINIMUM SLOPE OF 2 PERCENT. INSTALL CLEANOUTS AT CHANGES IN DIRECTION AND 5 FEET FROM THE OUTSIDE OF THE BUILDING.
- ALL WORK SHALL BE IN CONFORMANCE WITH THESE PLANS AND THE MOST RECENT SBCWD REGULATIONS FOR WASTEWATER SYSTEMS.
- CONTRACTOR TO CONDUCT SQUIRT TEST CONSISTING OF PRESSURIZING THE LEACHFIELD WITH THE PUMP AND ADJUSTING THE LEACHFIELD GATE VALVES TO PROVIDE A 5' HIGH STREAM OF WATER THROUGH ORIFICES. THIS IS TO BE REPEATED FOR CONSTRUCTION INSPECTION PHASE 2.
- CONTRACTOR TO KEEP A PLAN SET WITH ALL CHANGES MARKED UP AT THE JOB SITE AT ALL TIMES. THE CONTRACTOR TO PROVIDE ONE COPY OF THESE CHANGES ON A PLAN FOR PREPARATION OF AS- BUILT DRAWINGS TO GAIN COUNTY FINAL APPROVAL.

CONSTRUCTION INSPECTION NOTES
CONTRACTOR TO NOTIFY DESIGN ENGINEER AND SBCWD A MINIMUM OF 48 HOURS PRIOR TO CONSTRUCTION AND INSPECTION OF THE SYSTEM. ADDITIONAL FEES WILL BE REQUIRED BY SBCWD AFTER THREE SITE INSPECTIONS. ENGINEER AND SBCWD SHALL INSPECT THE SYSTEM AT CRITICAL CONSTRUCTION PHASES AS FOLLOWS:

- PHASE ONE:**
- INSPECT STAKE OUT LOCATION OF LATERALS ALONG CONTOURS, THE SEPTIC AND SUMP TANKS, AND THE SANDFILTER.
 - INSPECT THE LEACHLINE GRAVEL AND SANDFILTER MEDIA, AND PROVIDE A CERTIFIED COPY OF WET SIEVE ANALYSIS USING ASTM C-117 OR EQUIVALENT.
- PHASE TWO:**
- INSPECT LEACHLINE INSTALLATION AND LEVEL VIA OPEN TRENCHES AND INSTALLED INSPECTION WELLS.
 - INSPECT PERFORATION SIZE AND SPACING.
 - INSPECT WATER TIGHTNESS OF ALL TANKS.
 - INSPECT SQUIRT TEST OF LEACHFIELD.
 - INSPECT CONTROL PANEL, FLOATS AND CIRCUIT BREAKER FOR ENTIRE SEPTIC SYSTEM.
- PHASE THREE:**
- INSPECT ANY ITEMS LISTED ABOVE WHICH HAVE NOT BEEN OBSERVED YET.
 - INSPECT FINISHED SEPTIC SYSTEM INCLUSIVE OF ANY NECESSARY EROSION CONTROL MEASURES.
 - INSPECT FLOOR PLAN OF STRUCTURE BEING SERVED BY THE SEPTIC SYSTEM. INSPECT, IF APPLICABLE, WHETHER LOW FLOW FIXTURES WERE INSTALLED OR NOT.
 - PROVIDE SBCWD WITH BUILDING DEPARTMENT APPROVAL OF PUMP INSTALLATION.

OPERATION AND MAINTENANCE OF A SEPTIC SYSTEM

- INSPECT SEPTIC TANKS AND DRAINFIELD EVERY SIX MONTHS.
 - IF SLUDGE OR SCUM BUILDUP IS GREATER THAN 6 TO 8 INCHES HAVE TANK PUMPED. (USUAL FREQUENCY FOR PUMPING IS 3 TO 5 YEARS).
 - MINIMIZE THE USE OF GARBAGE DISPOSAL.
 - MINIMIZE THE USE OF HARSH CHEMICALS IN LARGE QUANTITIES.
 - MINIMIZE THE AMOUNT OF GREASE DISPOSED OF IN SINKS. PACKAGE ALL FOOD WASTES AND DISPOSE OF IN GARBAGE FOR SANITARY LANDFILL.
 - MINIMIZE DISPOSAL OF NON-SEWAGE ITEMS SUCH AS SANITARY NAPKINS, CIGARETTES AND OTHERS.
 - MAINTAIN ALL PLUMBING. LEAKS SHOULD BE FIXED AS QUICK AS THEY OCCUR.
 - MINIMIZE LIQUID LOAD ON THE SYSTEM BY WASHING DISHES AND LAUNDRY IN LARGE LOADS. SPREAD LOADS OVER THE WEEK RATHER THAN DOING ALL LAUNDRY ON A SINGLE DAY.
 - PROHIBIT VEHICULAR TRAFFIC AND HOOFED ANIMALS FROM THE SEPTIC SYSTEM AREA.
- PUMP:**
THE PUMP SHALL BE OF THE SIZE AND TYPE INDICATED ON THE PLANS AND SHALL INCLUDE THE FOLLOWING:
1) A HANDS OFF AUTO (HOA) SWITCH.
2) AN AUDIO AND VISIBLE ALARM AND NECESSARY EFFLUENT SENSING DEVICE TO INDICATE A HIGH WATER CONDITION.
3) USE EITHER PILL OR MERCURY TYPE FLOAT SWITCH.
4) SET PUMPING VOLUME AS STATED IN THE PUMP REQUIREMENTS.
5) PUMP TO BE SET A MINIMUM OF 8 INCHES FROM THE BOTTOM OF THE SUMP.
- SUMP:**
1) THE SUMP SHALL HAVE A WORKING CAPACITY OF 1.0 TIMES THE DESIGN FLOW DESIGNATED. THE CAPACITY SHALL INCLUDE THE DOSE VOLUME AND 24-HOUR STORAGE VOLUME.
2) ACCESS TO BE PROVIDED BY A MINIMUM 24-INCH DIAMETER WATERPROOF AIR TIGHT RISER AND LID SYSTEM.
3) ALL PIPE AND OR ELECTRICAL CONNECTIONS MADE THROUGH THE RISER EITHER TO BE PRECAST INTO THE RISER OR SEALED WITH GASTIGHT COMPRESSION CONNECTORS.


ELECTRICAL FEATURES

- THE FOLLOWING ELECTRICAL FEATURES TO BE PROVIDED
- AN OUTDOOR TYPE CONTROL BOX CONTAINING A FUSED DISCONNECT AND MOTOR PROTECTION SWITCH. SEE THE PUMP REQUIREMENT SECTION OF THE PLANS FOR THE MODEL NUMBER AND REQUIREMENTS.
 - THE CONTROL BOX TO BE MOUNTED ON THE BUILDING BEING SERVED IF WITHIN 20 FEET OF THE SUMP OTHERWISE INSTALL ON A 4"x4" POST THAT IS INSTALLED SECURELY. CONTROL PANEL TO BE VISIBLE FROM THE ROADWAY IF AT ALL POSSIBLE.
 - ALARM AND PUMP TO BE INSTALLED ON SEPARATE CIRCUITS THAT ARE OF SIZE LARGE ENOUGH FOR THE RESPECTIVE USES.
 - ELECTRICAL CONDUIT SHALL BE PVC AND SEPARATE CONDUITS SHALL BE PROVIDED TO POWER PUMP AND FLOATS.

PRESSURE PIPING

- THE PIPE FROM THE SUMP TO THE DRAINFIELD SHALL BE PVC IN THE SIZE AND SCHEDULE SPECIFIED ON THE PLANS.
- A UNION SWING CHECK VALVE AND DOUBLE WEDGE GATE VALVE SHALL BE INSTALLED IN THE SUMP CHAMBER IN THIS ORDER AWAY FROM THE PUMP. ALTERNATIVELY THESE ITEMS CAN BE INSTALLED IN A VALVE BOX NEXT TO THE SUMP CHAMBER.
- CONCRETE THRUST BLOCKS SHALL BE INSTALLED WHEN CHANGE IN PIPE DIRECTION IS 45 DEGREES OR GREATER.

PERMITS
ASIDE FROM THE INDIVIDUAL SEWAGE DISPOSAL SYSTEM PERMIT ADDITIONAL PERMIT (S) WILL BE REQUIRED BY THE BUILDING INSPECTION DEPARTMENT FOR PUMP INSTALLATION.

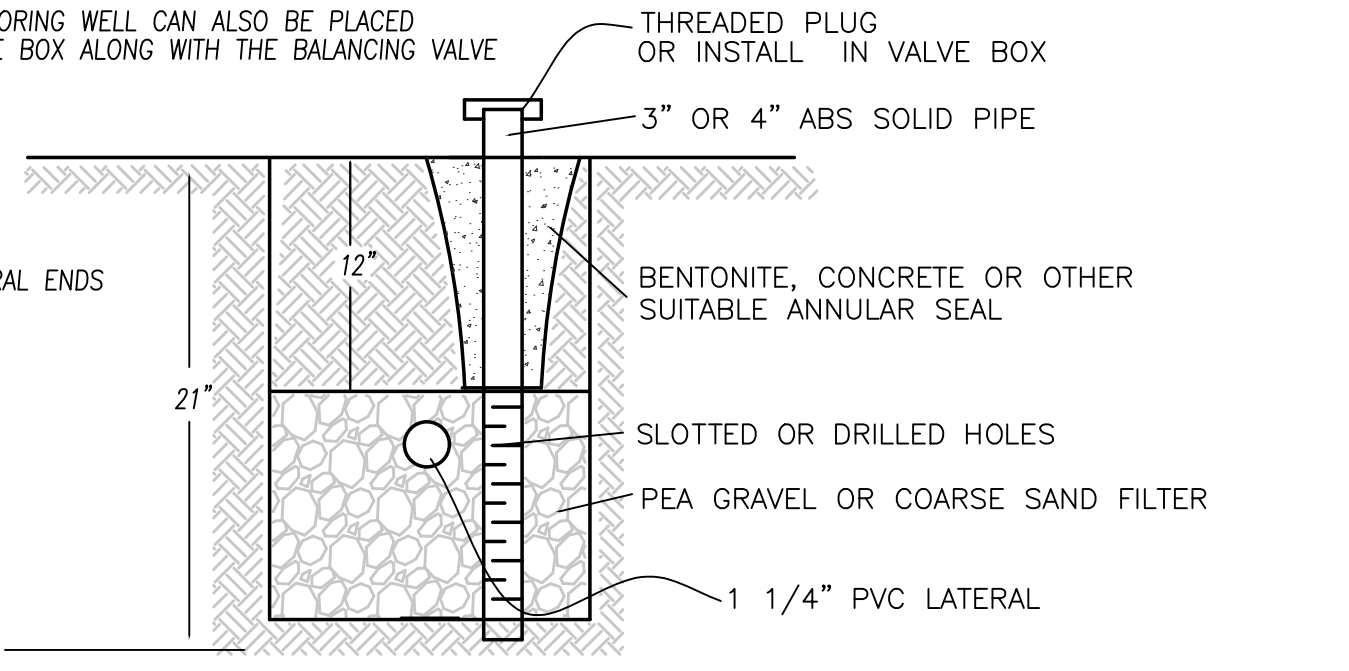

TYP. LEACHLINE INSPECTION WELL
NOT TO SCALE



DETAILS

PREPARED FOR:
PETER JENSEN
265 ELEANOR DRIVE
WOODSIDE CA 94062

RAISED BED / ADVANTEX SYSTEM
43 DIPSEA ROAD
STINSON BEACH, CA
APN 195-090-42

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Job No. 2020-035
Date 02-3-21
Drawn By: tkp
Checked By: tkp
Scale as shown

Sheet 2 of 2

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