EXTERIOR REMODEL

111 OAK AVE Kentfield Ca 94904

PROJECT DATA. PROJECT ADDRESS 111 0AK AVE, KENTFIELD, CA 94904 APN 07115215 TYPE 0F CONSTRUCTION V-B OCCUIPANCY GROUP R-3

PROJECT ANALYSIS

| | LUI SIZE | 10,000 SQ F1 |
|---|----------------------|------------------|
| | GROSS FLOOR AREA (E) | 4,109 SQ FT |
| | GROSS FLOOR AREA (N) | NO CHANGE |
| | FAR (E) | 41% |
| | FAR (N) | NO CHANGE |
| | LOT COVERAGE (E) | 6,295 SQ FT |
| | LOT COVERAGE (N) | 7,555 SQ FT |
| | PARKING (E) | 3 SPACES |
| | PARKING (N) | NO CHANGE |
| (| LIMIT OF DISTURBANCE | 2.622 SQ FT |
| | GRADING CALCULATION | |
| / | CUT | 75 CUBIC YARDS) |
| (| FILL | 50 CUBIC YARDS / |
| / | OFF-HAUL | 25 CUBIC YARDS |
| | | |

CONTACT TABLE

CLIENT: GOTTESMAN REVOCABLE TRUST, GOTTESMAN@GMAIL.COM, (415) 271-2320.

DESIGNER: CONSTRUCTO INC., NICK ROMANENKO, (408)490-3333 X107, NICK@CONSTRUCTO.ONLINE 51 E CAMPBELL AVE., STE. 100-B, CAMPBELL, CA 95008

PROFESSIONAL ENGINEER: LEI ZHENG, (510) 909-1933, ENGINEER.LEI@GMAIL.COM

(N) PREFABRICATED POOL WITH BAJA SHELF 152 SQ.FT

(N) SHADE PERGOLA 478 SO.FT.

(N) FIREPLACE WALL OVER EXISTING DETACHED GARAGE

(N) RETAINING WALL IN POOL AREA


(N) SYNTHETIC TURF

(N) CONCRETE STEPPERS

(N) CONCRETE STEPPERS (N) PAVING (N) PLANTING AREA (N) WINE FRIDGE AND STORAGE (N) RAISED PLANTER

TABLE OF CONTENT

| LABEL | TITLE | DESCRIPTION | COMMENTS |
|--------------|---|-------------|-----------|
| A100 | PROJECT OVERVIEW | | |
| A101 | SITE PLAN | PROPOSED | 1/8" = 1" |
| A102 | LAYOUT ENLARGEMENT PLAN POOL AND PATIO | PROPOSED | 1/4" = 1" |
| A103 | SECTIONS | PROPOSED | 1/8" = 1" |
| A104 | ELEVATION PERGOLA | PROPOSED | 1/4"=1" |
| A105 | MEP | PROPOSED | 1/4"=1" |
| A106 | GAS LINE DIAGRAM | PROPOSED | 1/8"=1" |
| A107 | FIREPLACE DETAILS | | 1/8" = 1" |
| A198. | BEST MANAGEMENT PRACTICES PLAN | | NO SCALE |
| A110) | UTILITY PLAN | | 1/16"=1" |
| A111 } | BMP | | NO SCALE |
| A112 \ | ELEVATIONS | PROPOSED | 1/8"=1" |
| A113 < | ELEVATIONS | PROPOSED | 1/8"=1" |
| AH4J | POOL PLAN | PROPOSED | AS NOTED |
| A115) | POOL ELEVATIONS | PROPOSED | AS NOTED |
| A115) | POOL CROSS SECTIONS | PROPOSED | AS NOTED |
| T1 3 | TOPOGRAPHIC SURVEY | | AS NOTED |
| C-Y | PRECISE GRADING PLAN | TITLE SHEET | AS NOTED |
| C-2 C-3 \ | PRECISE GRADING& DRAINAGE PLAN | | AS NOTED |
| C-3) | SECTIONS AND DETAILS | | AS NOTED |
| C-4 | EROSION CONTROLPLAN | | AS NOTED |
| C-5 | POOL BMP | | AS NOTED |
| SN1 | STRUCTURAL NOTES | | AS NOTED |
| S1 | FOUNDATION PLAN | | AS NOTED |
| S2 | ROOF TOP FRAMING PLAN | | AS NOTED |
| 53 | PERGOLA FRAMING PLAN | | AS NOTED |
| CDI | | | |

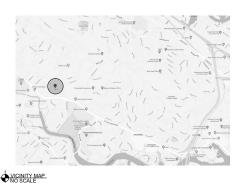

FOR ANY WORK PROPOSED IN THE RIGHT OF WAY, THE SELECTED CONTRACTOR SHALL APPLY FOR AND OBTAIN AN ENCROACHMENT PERMIT PRIOR TO STARTING THAT WORK.

NOTE.
DESIGN ENGINEER/ARCHITECT SHALL
CERTIFY TO THE COUNTY M WRITING
UPON THE COMPLETION OF WORK THAT
UPON THE COMPLETION OF WORK THAT
MEROVEMENTS WERE INSTALLED IN
ACCORDANCE WITH THE APPROVED
LANS AND FIELD DIRECTION. BE
AWARE THAT A DPW ENGINEER WILL
MEED TO INSPECT AND ACCEPT WORK
AFTER RECEIPT OF CERTIFICATION
LETTER CERTIFICATION LETTERS SHALL
REFERENCE BUILDING PERMIT HUMBER
UPON CERTIFICATION LETTERS SHALL
REFERENCE BUILDING PERMIT HUMBER
BEING CESTIFICEN THE ADDRESS OF THE
PROPERTY AND THE ASSESSOR'S
PRACEL NUMBER (JPM). AND SHALL BE
SIGNED AND STAMPED BY THE
CERTIFINING PROFESSIONAL.

DESIGN ENGINEER SHALL INSPECT AND CERTIFF IN WITHING TO DRY HAT EACH RETAINING WALL WAS CONSTRUCTED PER APPROVED PLAN AND FIELD DIRECTION. CERTIFICATION LETTERS SHALL REFERENCE GUILDING PERMIT NUMBER OR NUMBERS FOR SPECIFIC WORK BEING CERTIFIED. THE ADDRESS AND THE ASSESSOR'S PARCEL NUMBER ACPHORNIES FOR SPECIFIC WALL BE CERTIFIED, THE ADDRESS AND THE ASSESSOR'S PARCEL NUMBER CAPPLORT HE PROJECT, AND SHALL BE SIGNED AND STAMPED BY THE CERTIFIEND REPOSSIONAL







PROJECT

EXTERIOR REMODEL

ADDRESS

111 OAK AVE KENTFIELD CA 94904

CLIENT

GOTTESMAN REVOCABLE TRUST

TITLE


PROJECT OVERVIEW

DATE

7/21/23

SCALE



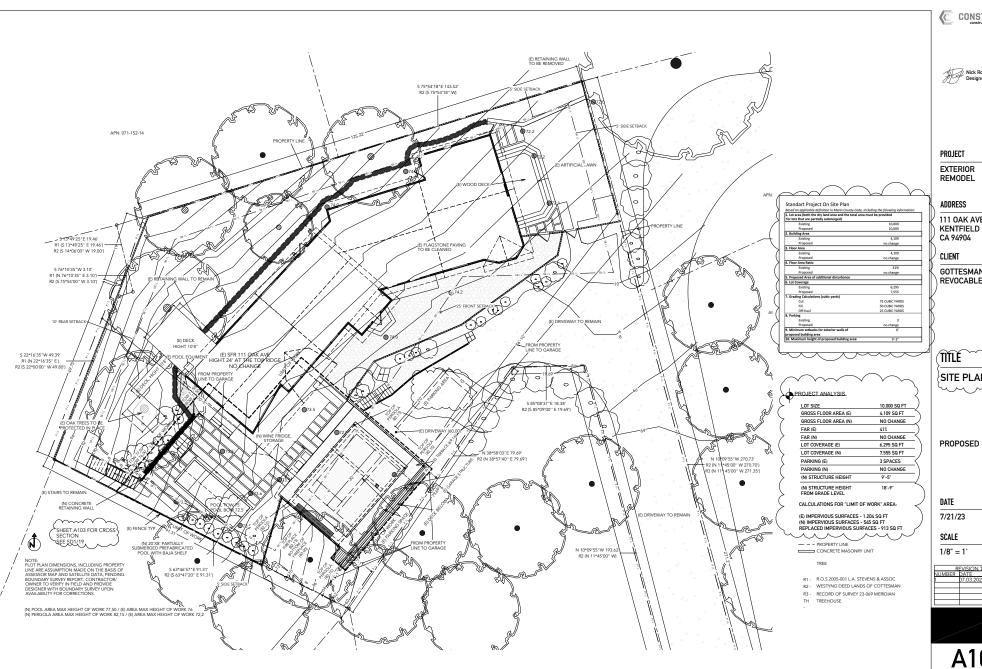

CONSTRUCTO

PROJECT

EXTERIOR REMODEL


ADDRESS

111 OAK AVE KENTFIELD CA 94904

GOTTESMAN REVOCABLE TRUST

TITLE SITE PLAN

REVISION TAB

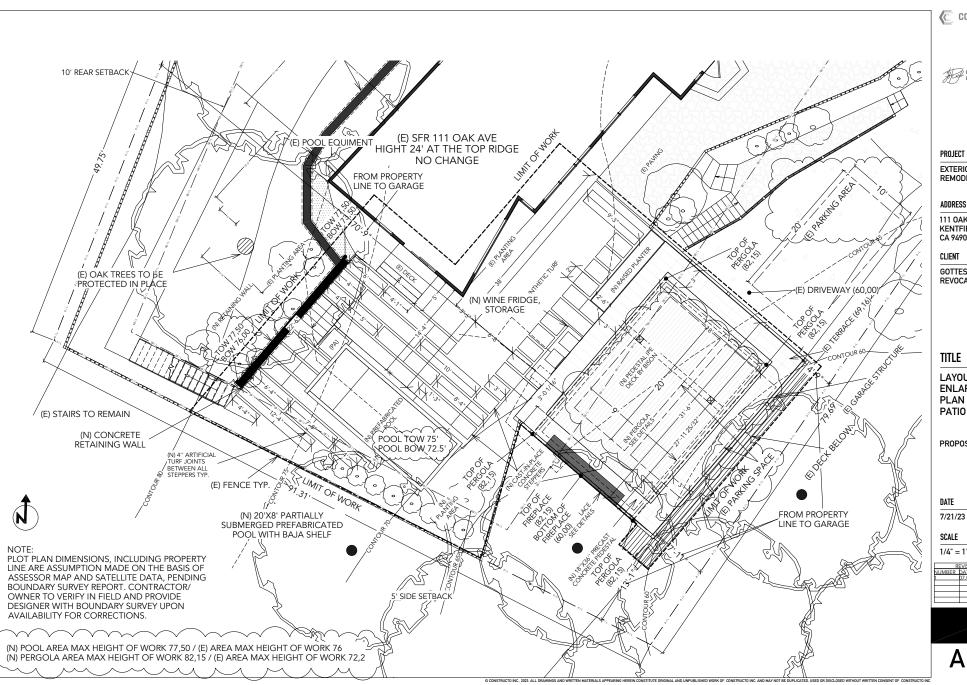

CONSTRUCTO

EXTERIOR REMODEL

ADDRESS

111 OAK AVE KENTFIELD CA 94904

CLIENT

GOTTESMAN REVOCABLE TRUST

TITLE


LAYOUT **ENLARGEMENT** PLAN POOL AND PATI0

PROPOSED

DATE

7/21/23

1/4" = 1"

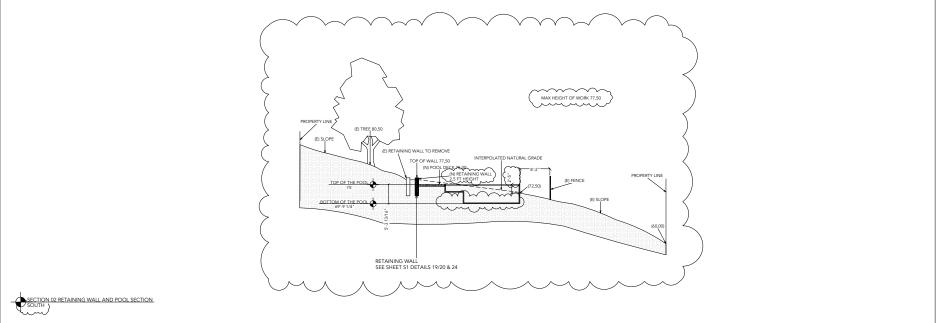

CONSTRUCTO constructo enline



PROJECT

EXTERIOR REMODEL

ADDRESS

111 OAK AVE KENTFIELD CA 94904

CLIENT

GOTTESMAN REVOCABLE TRUST

TITLE

SECTIONS

PROPOSED


DATE

7/21/23

SCALE

1/8" = 1'


| R | EVISION TA | BLE |
|--------|------------|------------|
| NUMBER | | REVISED BY |
| | 07.03.2023 | NR |
| | | |
| | | |
| | | |
| | | |

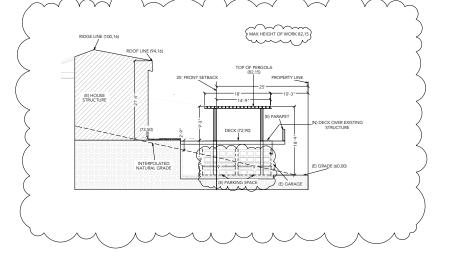


SECTION 01 PERGOLA AND EXISITING HOUSE SOUTH

A103

© CONSTRUCTO INC., 2023. ALL DRAWINGS AND WRITTEN MATERIALS APPEARING HEREIN CONSTITUTE ORIGINAL AND UNPUBLISHED WORK OF CONSTRUCTO INC. AND MAY NOT BE DUPLICATED, USED OR DISCLOSED WITHOUT WRITTEN CONSENT OF CONSTRUCTO INC.

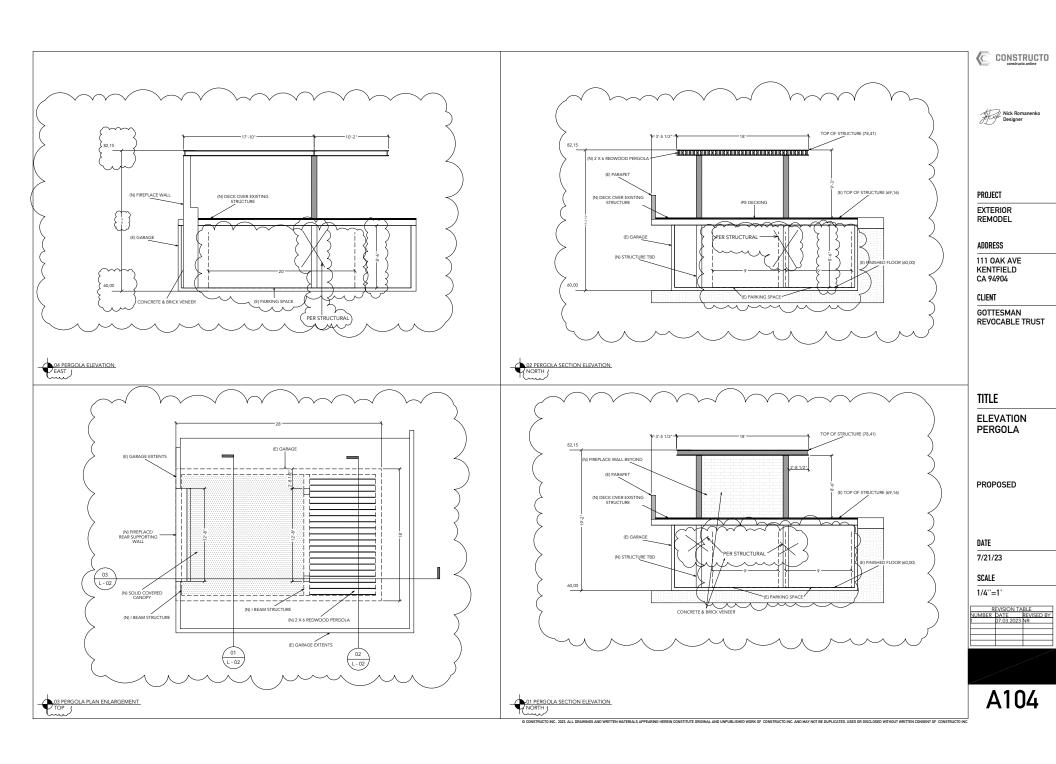

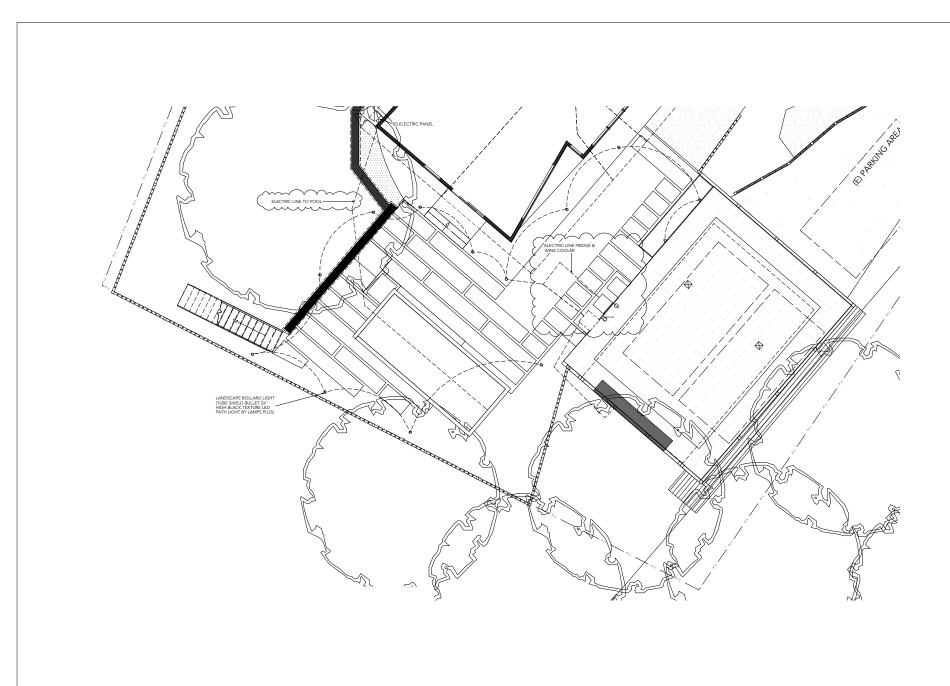





PROJECT

EXTERIOR REMODEL

ADDRESS

111 OAK AVE KENTFIELD CA 94904

CLIENT

GOTTESMAN REVOCABLE TRUST

TITLE

MEP


PROPOSED

DATE

7/21/23

SCALE

1/4''=1'

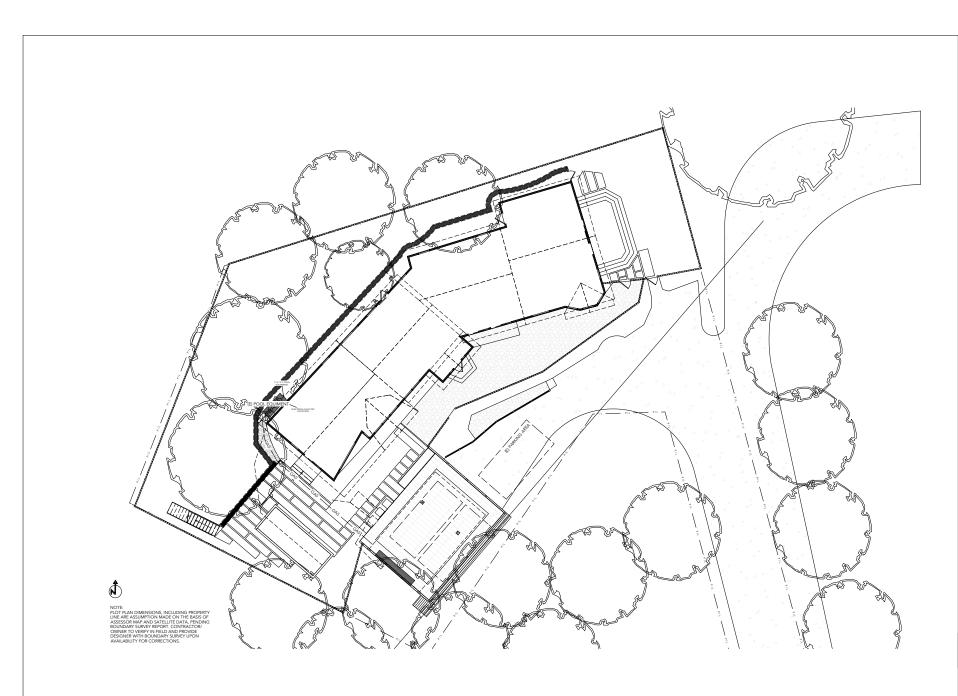





PROJECT

EXTERIOR REMODEL

ADDRESS

111 OAK AVE KENTFIELD CA 94904

CLIENT

GOTTESMAN REVOCABLE TRUST

TITLE

GAS LINE DIAGRAM


PROPOSED

DATE

7/21/23

SCALE

1/8''=1'

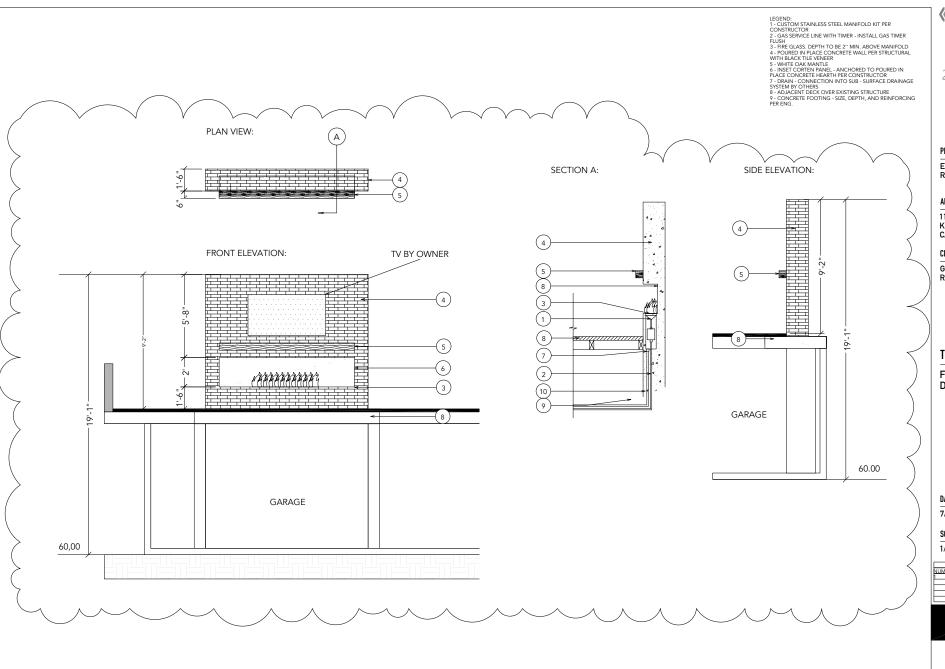

CONSTRUCTO
constructo.online

Nick Romanenko Designer

PROJECT

EXTERIOR REMODEL

ADDRESS

111 OAK AVE KENTFIELD CA 94904

CLIENT

GOTTESMAN REVOCABLE TRUST

TITLE

FIREPLACE DETAILS

DATE

7/21/23

SCALE

1/8" = 1'

© CONSTRUCTO INC., 2023, ALL DRAWINGS AND WRITTEN MATERIALS APPEARING HEREIN CONSTITUTE ORIGINAL AND UNPUBLISHED WORK OF CONSTRUCTO INC. AND MAY NOT BE DUPLICATED. USED OR DISCLOSED WITHOUT WRITTEN CONSENT OF CONSTRUCTO INC.







PROJECT

EXTERIOR REMODEL

ADDRESS

111 OAK AVE KENTFIELD CA 94904

CLIENT

GOTTESMAN REVOCABLE TRUST

TITLE

BEST MANAGEMENT **PRACTICES** PLAN


DATE

SCALE

7/21/23

NO SCALE




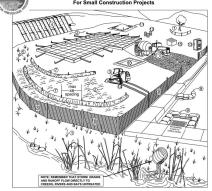


| Erosion Controls | Sediment Controls | Good Housekeeping |
|---|---------------------------|---------------------------------------|
| NS Scheduling | 6. Tracking Controls | 10. Concrete Washout |
| . Preserve Vegetation & Creek Set Backs | 7. Fiber Rolls | 11. Stockpile Management |
| Soil Cover | 8. Silt Fence | 12. Hazardous Material Management |
| Soil Preparation/ Roughening | 9. Drain Inlet Protection | 13. Sanitary Waste Manacement |
| . Erosion Control Blankets | NS Trench Dewatering | 14. Equipment and Vehicle Maintenance |
| 5. Revegetation | | 15. Litter and Waste Management |

If you require materials in alternative formats, please contact: 415-473-4381 voice/TTY or disabilityaccess@co.marin.ca.us

| | trol Measure | General Description |
|-----|--|--|
| | | anagement Practices |
| | Scheduling | Plan the project and develop a schedule showing each phase of construction. Schedule construction activities to reduce erosion potential, such as scheduling ground disturbing activities unique plan bytesting projects to minimize the summer and phasing projects to minimize the amount of area disturbed. For more info see the following factsheats: CASQA: EC-1; or Castrares: Sch. 1. |
| 1 | Preserve Existing Vegetation and Creek Setbacks | Preserve existing vegetation to the extent possible, especially stong creek buffers. Show crear buffers on maps and identify areas to be preserved in the field with temporary fencing. Check with the local Planning and Public Works Departments for specific creek set back requirements. For more into see the following factorhests: CASOAL: EC-2 or Cathans: SS-2. |
| 2 | Soil Cover | Cover exposed soil with straw mulch and tackifier (or equivalent). For more info see the following factsheets: CASQA: EC-3, EC-5, EC-6, EC-7, EC-6, EC-14, EC-16; or Caltrans: SS-2, SS-4, SS-5, SS-6, SS-7, SS-8. |
| 3 | Soil Preparation/ Roughening | Soil preparation is essential to vegetation establishment and BMP installation. It includes soil testing and amendments to promote vegetation growth as well as roughening surface soils by mechanical methods (decompacing, acarifying, stair stapping, etc.). For more into see the following facothesets: CASQA: EC-15. |
| 4 | Erosion Control Blankets | Install ensists control Narkets (or equivalent) on disturbed sites with 3.1 slopes or steeper. Use widdle- friendly blankets made of blood-gradable natural materials. Avoid using blankets made with plasts netting or fixed apenture netting. See: http://www.coastal.ca.gov/ings/Halfler-Eriendly-Products.pdf . For more into see the following facility-interior CASOA-EC-7; or Catherras SS-7. |
| 5 | Revegetation | Re-vegetate areas of disturbed soil or vegetation as soon as practical. For more info see the following factorheets: CASQA: EC-4; or Calmans: SS-4. |
| | ment Control Best | Management Practices |
| 6 | Tracking Controls | Stabilists the entirects to prevent tracking and offisher, lospect of treefed daily and sweep class a consider. Another invention and restricts to assume that one of the control of the |
| 7 | Fiber Rolls | Use the ren's as a permiser control measure, since contains of stope, and amount out stopics, for these specimen for 10 faired explaining of secondary on before stopics), middle practice contain, secondary of the secondary of the secondary of the secondary of the secondary of the Type 1 (pairs rich into shafetier secondary of Type 2 (pairs in form and before of and rich with the con- traction of the secondary of the secondary of the secondary of the secondary of the secondary of these developers of the secondary of the secondary of the secondary form of the secondary of the secondary of the secondary of the secondary of the secondary of the secondary of the form of the secondary of the secondar |
| 8 | Sit Fence | Use all fince as a perimeter control measure, and around soci stocipies, install all fince along contours. Key all fance in the load and stalls. On out use all fance for connectrated water flows, install for all seals of feet back from the sloce is alway for admired storage. Whe backed fence can be used for each sample, Avoid installing all finescent pages and an around the sample of the stall for a single section of seals of seal for a making. Amounted finesar scalement control can be used in like of silf fences. For more into see the following factablesis: CASOA: SE-1; SI-12; or Cathans: SO-1. |
| ٥ | Orain Inlet Protection | Use gravel bags, (or similar product) around drain initial located both contact and in guitar as a last line of defense. Bags should be made of a woven father resistant to photo-degradation filled with 0.51-in washed crushed rock; Do not use send bags or sit fence fabric for drain inlet protection, For more info see the following factorheast: CASON, SE-10; or. Calternas: SC-10. |
| N/A | Trench Dewatering | Follow MCSTOPPP BMPs for trench dewatering. http://www.marincounty.org/dests/bw/divisions/mcstoppg/ development/-imedia/Filea/Desartherers/Pt//imcstopps/development/TrenchingSW/RegMCSTOPPPFinal6_0 s.pdf. For more into see the following destribests: CASSW: NS-2: or Catrass: NS-2: |
| Goo | d Housekeeping Be | st Management Practices |
| 10 | Concrete Washout | Construct a lined concrete washout site away from storm drains, waterbodies, or other drainages. Ideally, place adjacent to stabilized entrance. Clean as needed and remove at end of project. For more into see the following factaheets: CASOA: WM-6; or. Californis: WM-6. |
| 11 | Stockpile Management | Cover all stockples and landscape material and berm properly with fiber rolls or sand bags. Keep behind the site perimeter central and away from waterbodies. For more info see the following factsheets: CASQA: WM-3 or Californi; WM-3. |
| 12 | Hazardous Material Management | Hazardous materials must be kept in closed containers that are covered and within secondary containment; do not place containers directly on soil. For more into see the following factsheets: CASQA: VIM-6; or Catrans: WiM-6. |
| 13 | Sanitary Waste Management | Place portable foliats near stabilized site entrance, behind the curb and away from gutters, storm dosin inlets, and waterbodies. The or stake portable toilets to prevent tipping and equip units with overflow pantray (most vendors provide these). For more into see the following factsheets: CASQA: WM-8; or Californic WM-9. |
| 14 | Equipment and Vehicle Maintenance | Prevent equipment fluid leaks onto ground by placing drip pers or plastic targs under equipment. Immediately clean up any spills or drips. For more info see the following factsheets: CASQA: NS-8, NS-9, and NS-10; or Catranse. NS-9, NS-9, and NS-10. |
| 15 | Litter and Waste Management | Designate waste collection areas on site. Use waterlight dumpsters and trash cans; inspect for leaks. Cover at the end of each work day and when it is raining or windy. Arrange for regular waste collection. Pick up site |

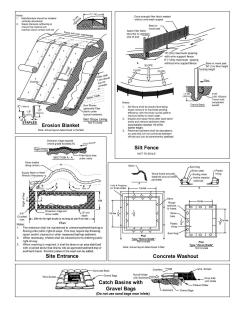

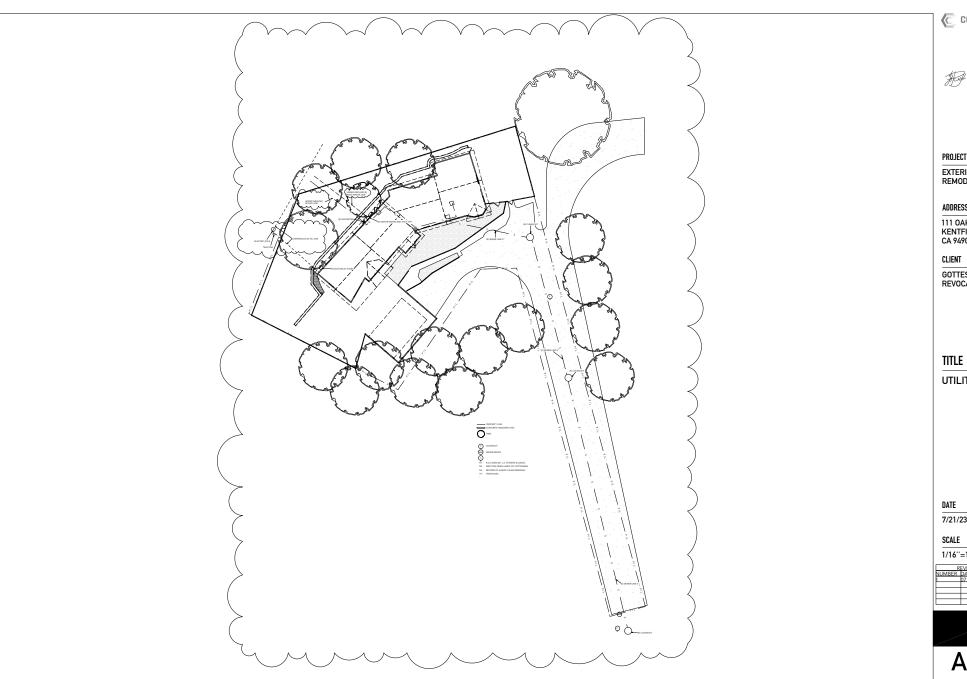





PROJECT

EXTERIOR REMODEL

ADDRESS

111 OAK AVE KENTFIELD CA 94904

GOTTESMAN REVOCABLE TRUST

UTILITY PLAN

7/21/23

1/16''=1'

| NUMBER | | REVISED B |
|--------|------------|-----------|
| 1 | 07.03.2023 | NR |
| | | |
| | | |
| | | |
| | | |
| | | |
| | | |

Construction Best Management Practices (BMPs)

Construction projects are required to implement the stormwater best management practices (BMP) on this page, as they apply to your project, all year long.

Materials & Waste Management



Non-Hazardous Materials

- □ Bern and cover stockpiles of sand, dirt or other construction material with tarps when rain is forecast or if not actively being used within
- ☐ Use (but don't overuse) reclaimed water for dust control.

Hazardous Materials

- ☐ Label all hazardous materials and hazardous wastes (such as pesticides, paints, thinners, solvents, fuel, oil, and antifreeze) in accordance with city, county, state and federal regulations.
- ☐ Store hazardous materials and wastes in water tight containers, store in appropriate secondary containment, and cover them at the end of every work day or during wet weather or when rain is forecast.
- ☐ Follow manufacturer's application instructions for hazardous materials and be careful not to use more than necessary. Do not apply chemicals outdoors when rain is forecast within 24 hours
- ☐ Arrange for appropriate disposal of all hazardous wastes

Waste Management

- ☐ Cover waste disposal containers securely with tarps at the end of every work day and during wet weather
- Check waste disposal containers frequently for leaks and to make sure they are not overfilled. Never hose down a dumpster on the
- ☐ Clean or replace portable toilets, and inspect them frequently for leaks and spills.
- ☐ Dispose of all wastes and debris properly. Recycle materials and vastes that can be recycled (such as asphalt, concrete, aggregate base materials, wood, gyp board, pipe, etc.)
- ☐ Dispose of liquid residues from paints, thinners, solvents, glues, and cleaning fluids as hazardous waste

Construction Entrances and Perimeter

- ☐ Establish and maintain effective perimeter controls and stabilize all construction entrances and exits to sufficiently control erosion and sediment discharges from site and tracking off site.
- ☐ Sweep or vacuum any street tracking immediately and secure sediment source to prevent further tracking. Never hose down streets to clean up tracking

Equipment Management & Spill Control



- Designate an area, fitted with appropriate BMPs, for vehicle and equipment parking and storage
- ☐ Perform major maintenance, repair jobs, and vehicle and equipment washing off site.
- ☐ If refueling or vehicle maintenance must be done onsite, work in a bermed area away from storm drains and over a drip pan or drop cloths big enough to collect fluids. Recycle or dispose of fluids as hazardous waste
- ☐ If vehicle or equipment cleaning must be done onsite, clean with water only in a hermed area that will not allow rinse water to run into gutters, streets, storm drains, or surface waters.
- ☐ Do not clean vehicle or equipment onsite using soaps solvents, degreasers, or steam cleaning equipment.

Spill Prevention and Control

- ☐ Keep spill cleanup materials (e.g., rags, absorbents and cat litter) available at the construction site at all times. ☐ Inspect vehicles and equipment frequently for and
- repair leaks promptly. Use drip pans to catch leaks until repairs are made. ☐ Clean up spills or leaks immediately and dispose of
- cleanup materials properly.
- Do not hose down surfaces where fluids have spilled. Use dry cleanup methods (absorbent materials, cat
- ☐ Sweep up spilled dry materials immediately. Do not try to wash them away with water, or bury them
- ☐ Clean up spills on dirt areas by digging up and properly disposing of contaminated soil.
- ☐ Report significant spills immediately. You are required by law to report all significant releases of hazardous materials, including oil. To report a spill: 1) Dial 911 or your local emergency response number, 2) Call the Governor's Office of Emergency Services Warning Center, (800) 852-7550 (24 hours)

Earthmoving



- ☐ Schedule grading and excavation work
- ☐ Stabilize all denuded areas, install and maintain temporary erosion controls (such as erosion control fabric or bonded fiber matrix) until vegetation is established.
- $\hfill \square$ Remove existing vegetation only when absolutely necessary, and seed or plant vegetation for erosion control on slopes or where construction is not immediately
- ☐ Prevent sediment from migrating offsite and protect storm drain inlets, gutters, ditches, and drainage courses by installing and maintaining appropriate BMPs, such as fiber rolls, silt fences, sediment basins, gravel bags, berms, etc.
- ☐ Keen excavated soil on site and transfer it to dump trucks on site, not in the streets.

Contaminated Soils

- ☐ If any of the following conditions are observed, test for contamination and contact the Regional Water Quality Control Board:
- Unusual soil conditions, discoloration, or odor
- Abandoned underground tanks Abandoned wells
- Buried barrels, debris, or trash

Paving/Asphalt Work



- Avoid paving and seal coating in wet weather or when rain is forecast, to revent materials that have not cured from contacting stormwater runoff.
- ☐ Cover storm drain inlets and manholes when applying seal coat, tack coat, slurry seal, fog seal, etc.
- Collect and recycle or appropriately dispose of excess abrasive gravel or sand Do NOT sweep or wash it into gutters.
- Do not use water to wash down fresh asphalt concrete pavement

Sawcutting & Asphalt/Concrete Removal

- ☐ Protect nearby storm drain inlets when saw cutting. Use filter fabric, catch basin inlet filters, or gravel bags to keep slurry out of the storm drain system.
- ☐ Shovel, abosorb, or vacuum saw-cut slurry and dispose of all waste as soon as you are finished in one location or at the end of each work day (whichever is sooner!)
- ☐ If sawcut slurry enters a catch basin, clear it up immediately

Painting & Paint Removal



- Never clean brushes or rinse paint containers into a street, gutter, storm
- ☐ For water-based paints, paint out brushes to the extent possible, and rinse into a drain that goes to the sanitary sewer. Never pour paint down a storm drain.
- ☐ For oil-based paints, paint out brushes to the extent possible and clean with thinner or solvent in a proper container. Filter and reuse thinners and solvents. Dispose of excess liquids as hazardous waste
- ☐ Paint chips and dust from non-hazardous dry stripping and sand blasting may be swept up or collected in plastic drop cloths and disposed of as trash.
- Chemical paint stripping residue and chips and dust from marine paints or paints containing lead mercury or tributyltin must be disposed of as hazardous waste. Lead based paint removal requires a state certified contractor.

Dewatering



- runoff from dewatering operations must be properly managed and disposed. When possible send dewatering discharge to landscaped area or sanitary sewer. discharging to the sanitary sewer call your local wastewater treatment plant
- ☐ Divert run-on water from offsite away from all disturbed areas.
- ☐ When dewatering, notify and obtain approval from the local municipality before discharging water to a street gutter or storm drain. Filtration or diversion through a basin, tank, or sediment trap may be required.
- □ In areas of known or suspected contamination, call your local agency to determine whether the ground water must be tested. Pumped groundwater may need to be collected and bauled off-site for treatment and proper disposal.



- □ Discharges of groundwater or captured

Storm drain polluters may be liable for fines of up to \$10,000 per day!



PROJECT

EXTERIOR REMODEL

ADDRESS

111 OAK AVE KENTFIELD CA 94904

CLIENT

GOTTESMAN REVOCABLE TRUST

TITLE

BMP

7/21/23 SCALE

NO SCALE

A111

Concrete, Grout & Mortar

Application

☐ Store concrete, grout, and mortar away

☐ Wash out concrete equipment/trucks

offsite or in a designated washout

that will prevent leaching into the

☐ When washing exposed aggregate,

and disposed of properly.

area, where the water will flow into a

emporary waste pit, and in a manner

Let concrete harden and dispose of as

prevent washwater from entering storm

gutters, hose washwater onto dirt areas, or

drain onto a bermed surface to be pumped

Landscaping

☐ Protect stockpiled landscaping materials

☐ Stack bagged material on pallets and

☐ Discontinue application of any erodible landscape material within 2 days before a

forecast rain event or during wet weather

under cover.

from wind and rain by storing them under

drains. Block any inlets and vacuum


underlying soil or onto surrounding areas


rain, runoff, and wind.

garbage.

from storm drains or waterways, and on

pallets under cover to protect them from

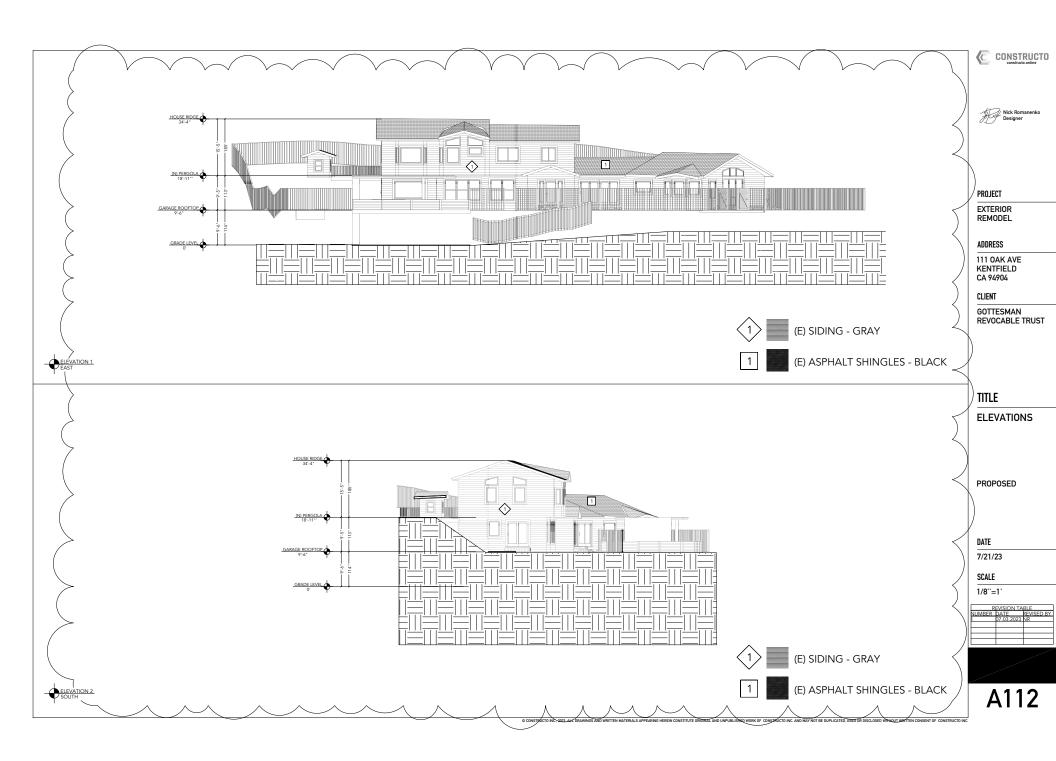

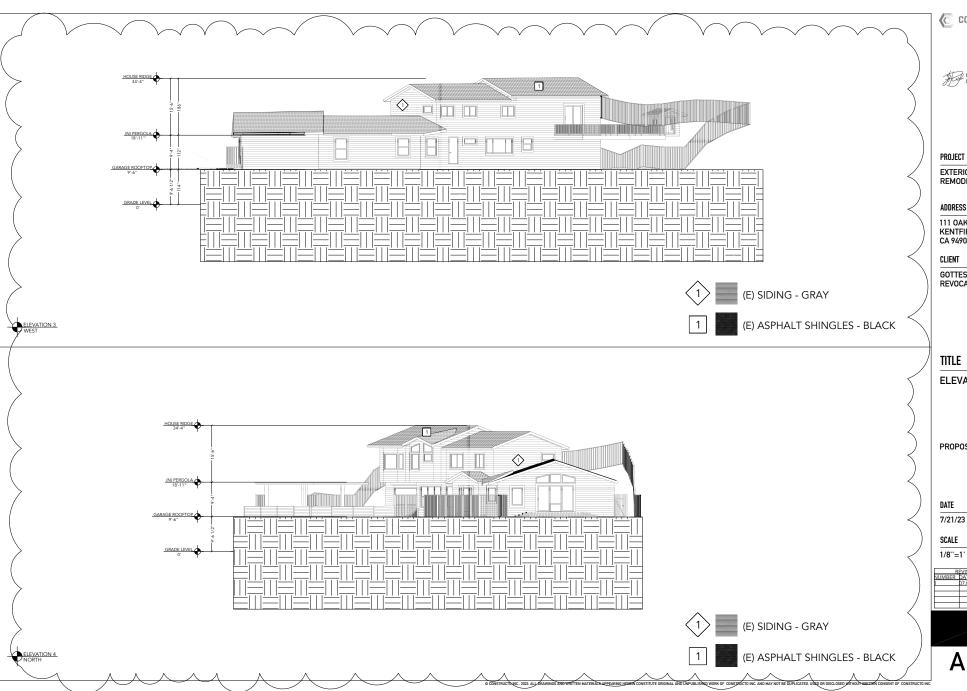

CONSTRUCTO constructo consinue



EXTERIOR REMODEL

ADDRESS


111 OAK AVE KENTFIELD CA 94904

GOTTESMAN REVOCABLE TRUST

ELEVATIONS

PROPOSED



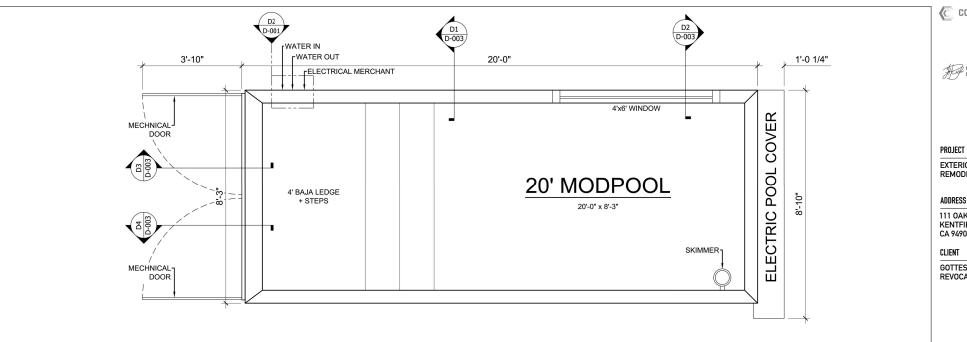


GENERAL SPECIFICATIONS

PLAN VIEW 5/16" = 1'-0"

- ▶20' MODPOOL
- ► FOOTING- 8"+ COMPACTED GRAVEL (3/4" MINUS)
- ►WINDOW- 4'x6' RIGHT WALL
- *** AS FAR TO THE END ***
- ►ENTRY- 4' BAJA LEDGE + STEPS CONFIG.
- ► HEATER- JANDY 400K BTU (NAT GAS)
- ► COVER- LHM ELECTRIC (BLACK)
- ►WIFI KIT
- ►LED LIGHT
- ►INSTALLATION- PARTIAL IN-GROUND
- ►EXTERIOR COLOR- BLACK
- ►INTERIOR LINER COLOR-LIGHT GREY

ADDITIONAL SPECIFICATIONS

- ►ULTRA UV2 WATER SANITATION SYSTEM
- ►TRUGUARD MINERAL
- *** EQUIPMENT EXTERNAL ***

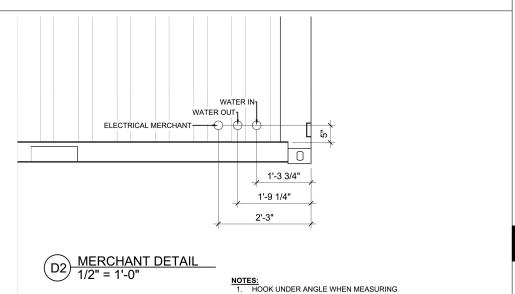

CONSTRUCTO

EXTERIOR REMODEL

ADDRESS

111 OAK AVE KENTFIELD CA 94904

GOTTESMAN REVOCABLE TRUST

TITLE

POOL PLAN


PROPOSED

DATE

7/21/23

SCALE

AS NOTED

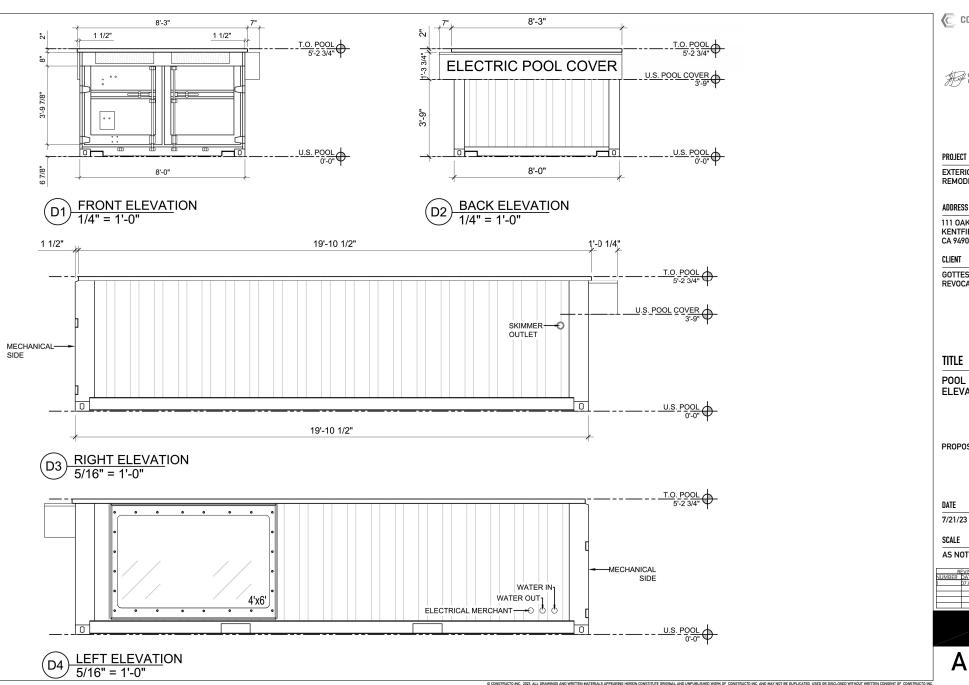

CONSTRUCTO

EXTERIOR REMODEL

ADDRESS

111 OAK AVE KENTFIELD CA 94904

GOTTESMAN REVOCABLE TRUST

P00L **ELEVATIONS**


PROPOSED

DATE

7/21/23

AS NOTED



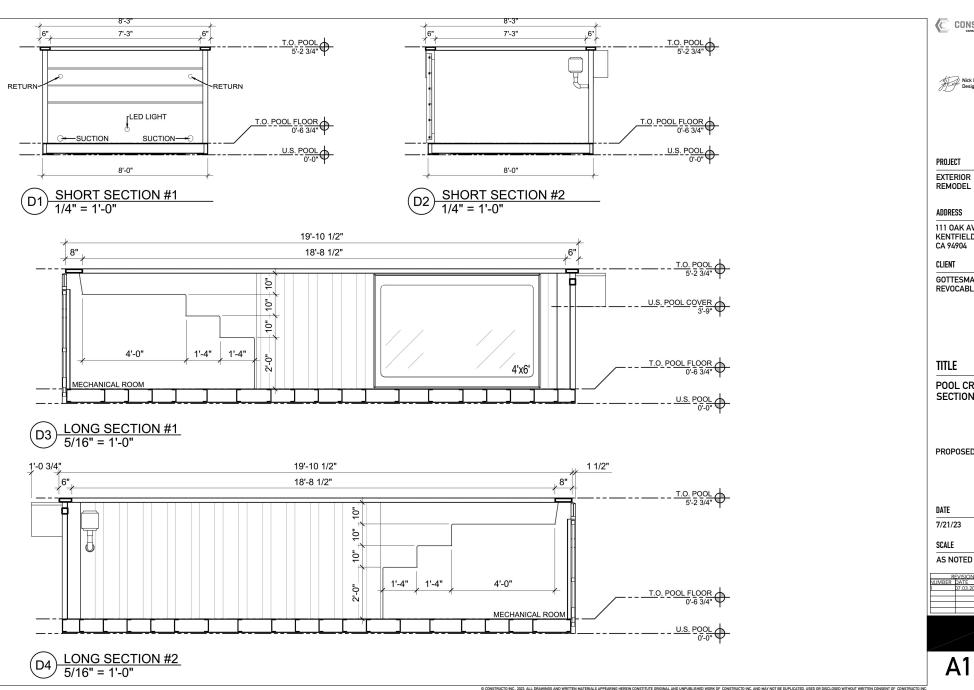

CONSTRUCTO

EXTERIOR REMODEL

111 OAK AVE KENTFIELD CA 94904

GOTTESMAN REVOCABLE TRUST

POOL CROSS SECTIONS

PROPOSED

7/21/23



PROPERTY LEGAL DESCRIPTION

THE LAND REFERRED TO IS SITUATED IN THE UNINCORPORATED AREA OF THE COUNTY OF MARIN, STATE OF CALIFORNIA, AND IS DESCRIBED AS FOLLOWS:

PARCEL ONE:

EXPANSIVO ON THE SASTEMY UNE OF THE PARCEL SCHAFED ID THEN A LOUGH BY EXECUTED DECORDED JUNE, 74, 1932. IN BOOK X-60 OF FORLING EXCENSION, Y FASCE 114, USENIAM WORTH MY 32' LEST 1932-50 FEET HAN INSTITUTE OF A WARREST ASS. THE PARCEL SCHAFE TO THE MESTING THE SOUTH ASS OF THE PARCEL SCHAFE TO THE MESTING THE SOUTH AS TO SENIES AS THE PARCEL SCHAFE TO THE MESTING THE SOUTH AS TO SELECT ASS. THE PARCEL SCHAFE TO THE MESTING THE SOUTH AS TO SELECT ASS. THE SOUTH AS TO SELECT A

PARCEL TWO:

BEGINNING ON THE NORTHERLY LINE OF OAK AVENUE, DISTANT NORTH 75' 54' EAST 28 FEET FROM THE SOUTHWEST CORNER OF LOT 32; THENCE NORTH 75' 54' EAST 20 FEET TO THE SOUTHWEST CORNER OF THE PARCEL GRAVITED TO ROBERT W. HORART BY DEED RECORDED FEBRUARY 27, 1641 IN BOOK 480 OF OFFICIAL RECORDED, AT PACE 442; THENCE ALMON THE WISTERSTRY LINE OF SAID PARCEL, NORTH 11' 48' WEST 270.7 FEET TO THE NORTHERLY LINE OF LOT 22; THENCE ALMON DAD LINES, DOUTH 11' 45' MEST 270.7 FEET TO THE NORTHERLY LINE OF LOT 23; THENCE ALMON DAD LINES, DOUTH 11' 45' LEST 270' FEET, MORE OF LUSS. TO THE POINT OF BEGINNING.

BEING A PORTION OF LOT 32, MAP OF THE MONTE VISTA TRACT, FILED ON OCTOBER 31, 1906 IN VOLUME 2 OF MAPS, AT PAGE 72, MARIN COUNTY RECORDS.

GENERAL NOTES 1. SURVEYOR DID NOT ABSTRACT PROPERTY.

- 2. NOTHING IN THIS SURVEY IS INTENDED TO EXPRESS AN OPINION REGARDING OWNERSHIP OR TITLE.
- 3. THE PREPARER DID NOT PERFORM NOR HAS THE PREPARER ACCEPTED ANY RESPONSIBILITY TO PERFORM ADDITIONAL RECORDS RESEARCH.
- 4. VISIBLE ABOVE GROUND UTILITIES ARE SHOWN HEREON. UNDERGROUND LOCATES WERE NOT PERFORMED AS PART OF THE SCOPE OF THIS SURVEY.
- 5. ASSESSORS PARCEL INFORMATION HEREON IS PER THE COUNTY PARCEL VIEWER.
- 6. THIS IS NOT A "BOUNDARY SURVEY." NO MONUMENTS WILL BE SET.
- 7. LIMITS OF LIABILITY ARE NOT TO EXCEED THE LUMP SUM BID OF THS SURVEY.
- 8. THIS SURVEY IS CERTIFIED FOR THIS TRANSACTION ONLY.
- 9. THE PURPOSE OF THIS SURVEY IS FOR LANDSCAPING REHABILITATION, NO ADDITION TO THE EXISTING SINGLE FAMILY RESIDENCE.

TOPOGRAPHIC SURVEY

111 OAK AVENUE, KENTFIELD, CA 94904 ASSESSORS PARCEL NUMBER 071-152-66 MARCH, 2023 PROJECT NO. 23-015

CENTERLINE

PROPERTY LINE

WATER METER

TREE

CONCRETE MASONRY UNIT

FINISH FLOOR FLEVATION

TITLE REPORT SCHEDULE BILLITEMS:

THIS SURVEY WAS CONDUCTED WITHOUT THE BENEFIT OF A TITLE REPORT, EASEMENTS OR OTHER SCHEDULE BII ITEMS MAY NOT BE SHOWN.

BASIS OF BEARING AND COORDINATES

APN: 071-152-57

THE BASIS OF BEARINGS IS BASED UPON TIED CITY MONUMENTS IN HAND HOLES ALONG LAUREL GROVE AVENUE IN RELATION TO RECORD OF SURVEY 2005-001 COMPLETED BY I..A STEVENS & ASSOCIATES AS SHOWN HEREON.


BENCH MARK

APN: 071-152-14

ELEVATIONS HEREON ARE DERIVED FROM GNSS STATIC OBSERVATION. RINEX DATA PROCESSED THROUGH THE NATIONAL GEODETIC SURVEY 'OPUS' AND COMPUTATIONS UTILIZING GEOID 18. ELEVATIONS ARE REFERENCED TO NAVD88.

GRASS

APN: 0/1-152-4

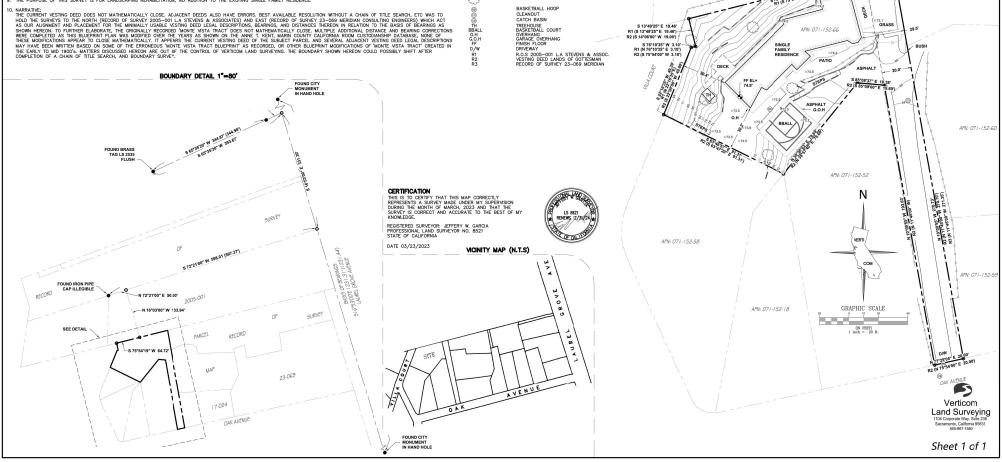

LEGEND

PRECISE GRADING PLAN

SINGLE-FAMILY RESIDENCE

111 OAK AVE, KENTFIELD, CA 94904

GENERAL NOTES

- EXCEPT AS HEREN MODIFIED, ALL GRADING SHALL CONFORM TO THE REQUIREMENTS OF CHAPTER 23.08, EXCAVATING, GRADING AND FILLING, OF THE MARIN COUNTY CODE AND ALL TERMS AND WORDS USED HEREIN ARE AS DEFINED IN CHAPTER 23.08 AND CHAPTER 23.18 FOR PUBLIC WORKS CONSTRUCTION.
- PUBLIC WORKS CONSTRUCTION
 GRADON SHALL BE HELD TO A MINIMUM. GRADING SHALL BE PERMITTED ONLY WHERE THE DEVELOPER CLEARLY DEMONSTRATES EVERY
 REASONABLE EFFORT HAS BEEN MODE TO RETAIN THE NATIONAL PERLINESS OF THE LAND TO THE MAXIMUM EXTENT POSSIBLE, E.G., SOULHE
 MANUFACTURE OF COLUMNS LINED FORMS, MODILES SWORTH MATRIEV EVERSITION, THESE, MODE COUNTEMPROSS, STREAMBEED AND
 MATERISES AND MATERIAL PROPERTY.
- 3. DEPENDING ON THE NATURE AND EXTENT OF THE PROPOSED GRADING. THE AGENCY MAY REQUIRE PLANS SPECIFICATIONS SURFACE ANDOR SUBSURFACE EXPLORATION, GEOTECHNICAL REPORTS, MATERIAL TESTING AND ANY OTHER INFORMATION DEEMED INCCESSARY BY THE AGENCY FOR THE PROPER EVALUATION OF THE PROPOSED GRADING, SUCH PLANS, SPECIFICATIONS, ETC., SHALL BE PREPARED BY REGISTERED PROFESSIONALS A REQUIRED BY THE AGENCY.

EROSION AND SEDIMENT CONTROL

- ALL DISTURBED SURFACES, INCLUDING, BUT NOT LIMITED TO, CUT AND FILL SLOPES, BUILDING PADS, DRIVEWAYS AND AREAS CLEARED OF VEGETATION, SHALL BE PROTECTED AGAINST EROSION AND SEDIMENT DISCHARGES BY MEASURES THAT THE AGENCY DETERMINES TO BE APPROPRIATE OT THE STIE, PHASE OF CONSTRUCTION AND TIME OF YEAR
- APPROPAIL TO THE STIE, PHASE OF CONSTRUCTION AND THE OF TEXE.

 WHEN REQUIRED TO THE PHASE IS STORMART PERSON OF THE ASSOCIATION, AND POLITION PROVIDED THE CONSTRUCTION PHASE. AS THE WAS STORMART OF THE CONSTRUCTION PHASE AS THE ASSOCIATION AND SEQUENCE AND SECURITY OF THE ASSOCIATION AND PHASE. AS THE ASSOCIATION AND PHASE AS THE ASSOCIATION AND ASSOCIATION ASSOCIATION ASSOCIATION ASSOCIATION AND ASSOCIATION ASSOCIATIO

- SUBJECT TO A BULLOWING PIRANT OR OTHER REPORT WERE: THE ARREN'D SETEMBARES THAT THE PROJECT HAS THE OTHER THAN THE SOMEPHOLAT RESIDENCE AMOND SOMETHING HOS TORNING THE CONSTRUCTION CONTINUED THAT THE PROJECT HAS THE OTHER THAN THE WHERE THE GRADED PORTION OF THE SITE INCLUDES MORE THAN TEN THOUGHAND SOURCE FEET OF AREA HAVING A SLOPE GREATER THAN FIFTEEN FRECENT.

- 2.3. WHERE THE GRADIO PORTION OF THE STER NALIDES MOSE THAN TEXT TROUBAND SQUARE FET OF AREA-HANDING A GOF GERETAR THAN PREPARE PRESCRIPT.

 1.4. WHERE THE REPORT.

 1.5. THE STEP OF THE S
- DUTURENT AT THE USINGS FOR THE MODELS.

 THE ESCP SHALL BE SUBMITTED FOR REVIEW AND APPROVAL BY THE AGENCY AND SHALL INCLUDE INFORMATION REQUIRED IN THE MOST RECENT VERSION OF THE MICSTOPPP ESCP STANDARD TEMPLATE. AT A MINIMUM, AN ESCP SHALL INCLUDE:
- DESCRIPTION OF THE MICS OFFE ESUF STANDARD TEMPLATE. BY A MINIMUM, AS DESCRIPTION OF THE PROPOSED PROJECT AND SOIL DISTURBING ACTIVITY. SITE SPECIFIC CONSTRUCTION-PHASE BEST MANAGEMENT PRACTICES (BMPS).
- SHE SPECIFIC CONSTRUCTION FROM BE BEST WANDERSHIP FRACTICES (1989).

 LIST OF A PRICABLE CUTSOE AGENCY FERMITS ASSOCIATED WITH THE SOIL DISTURBING ACTIVITY, SUCH AS CONSTRUCTION GENERAL.

 PERMIT (COPY, CLEAN WATER ACT SECTION 40 PERMIT, CLEAN WATER ACT SECTION 401 WATER QUALITY CERTIFICATION,

 STREAMBEDLANE ALTERATION AGREEMENT (1600 AGREEMENT).
- PERMIT (COP), CLEAN WATER ACT SECTION 44 PRIMIT, CLLAN WATER ACT SECTION 49 THATE QUALITY CERTIFICATION.

 FIREMANDELME ACTERIZATION RECIPIENT (1900, GREENERS).

 FOR ANY PROJECT REQUIRED TO MAKE AS EXP. PROCE SHALL BE SUMMITTED TO THE AGENCY THAT THE APPLICANT MAS GREATED THE PROCESS.

 FOR ANY PROJECT REQUIRED TO MAKE AS EXP. PROCE SHALL BE SUMMITTED TO THE AGENCY THAT THE APPLICANT MAS GREATED THE PROCESS.

 BIT AND ACTION AS ANY PROJECT REQUIRED TO MAKE AS ANY PROJECT AS ANY PROJECT THE ASSAULT OF A FERROR CHAPTER.

 BIT ANY PACLUE, BUT ARE NOT LIMITED TO, SCHEDULING AND TIMING OF GREATED ACTION BECAUSE TO GREATED ANY PROJECT ANY PROJECT AS ANY

- BUTH CIVE, AND CHRIMME, INFOVERED IN THE MARIN MUNICIPAL CODE.

 ALL CONSTRUCTION PLANS AND PREJICATIONS FOR CONSTRUCTION ACTIVITY SUBMITTED TO THE COUNTY SHALL CONSIDER THE POTENTIAL.

 FOR EROSION AND SEDIMENTATION AND THE DISCHARGE OF CONSTRUCTION WASTER AND CONTRIBUTIONS FROM CONSTRUCTION MATERIALS,

 TOUGS AND EQUIPMENT AT THE CONSTRUCTION STEEL, AND SHALL INCLIDE APPROPRIATE EROSION AND SEDIMENTATION CONTROLS.
- IMPLEMENTATION OF AN APPROVED ESCP SHALL BE A CONDITION OF THE ISSUANCE OF A BUILDING PERMIT, A GRADING PERMIT, OR OTHER PERMIT ISSUED BY THE AGENCY FOR A PROJECT SUBJECT TO THIS SECTION.

POOL NOTES

- SAL THATER POOLS COMPOT BE DISCHARGED TO A SMITTARY SERIES DISTING OR A STORM DRAWN.

 THE PREPERRED WERE DOES OF DISCHARGED ON, SAR, OF CHARGE WAS TESTED FOR AN ELYMPIC ONTO JAND SURFACES PROVIDED THE
 WATER SECRIC ROCKES OF COMPANIES OF THE PLANT SERIES AND S. A. AND THE JAND FALL OF THE PROPERTY OF T

- ALBAR TERSOR, DISCHARGE TO A STORM PAIN DULY FULL-PERT, ALBAR TERSOR, DISCHARGE TO A STORM PAIN DAY. L'ADDISCAPING) ARE POSSIBLE.

 NO OTHER DISPOSAL METHODS (E.G. SANTARY SEWER, LANDSCAPING) ARE POSSIBLE.

 THE POOL, SPA. OR FOUNTAIN WATER IS COMPLETED Y DO'SHORMATED DESPONMATED.

 CONCENTRATONS OF COPPER AND SILVER ARE NOT HARMFUL TO FSH OR OTHER AQUATC LIFE.
- CURENTS BETWEEN 6.5 AND 18.7

 THE PINS BETWEEN 6.5 AND 18.7

 THE WATER IS FREE OF ANY UNUSUAL CCLORATION, DIRT, SUDS, OR ALGAE THERE IS NO DISCHARGE OF FLITE MEDIA.

 THERE IS NO DISCHARGE OF ALGO CLEANING WASTES.

 THE WATER IS A MIGHENT TEMPERATURE.

- (HEATED WATER SHOULD BE ALLOWED TO COOL)

RETAINING WALLS

- RETAINING WALLS MAY BE REQUIRED WHENEYER TOPOGRAPHIC CONDITIONS WARRANT OR WHERE RECESSARY TO RETAIN QUIT OR FILL SLOPES WITHIN RIGHTS OF MAY, SLOPE SESSIENTS OR RIFORERTY LINES.

 FOR RETAINING WALLS REARLEST OF PISE, OR OF PRINCE PROJECT SECTION 24 A 130 AND FOR DRIVEWAYS SEE SECTION 24 A 206.

 IN NO-HROWNY AREAS UTILIZED OF THE PISE, SUCH AS PRINKING LOTS OR WALKWAYS, RESISSIET ETRACTED TIMERER MAY BE USED FOR MALL REGISTS TO EXCEDENT THE RETER HENGENGED FORM THE PISE, REQUIRED WAS AND AND CONTROLLED THE RETER HENGENGED FORM THE PISE, REQUIRED WAS AND THE PISESSARY THE PISES THE PISESTARY THE PISES OF THE PISESSARY THE STANDARY AREAS SECTION TO THE PISESSARY THE STANDARY OF THE PIS

- NOTWITHSTANDING THE CRITERIA CONTAINED HEREIN REGARDING THE USE OF TIMBER WALLS, THE AGENCY MAY DISALLOW SUCH USE WHERE IT DETERMINES THAT THE DESIGNATED LOCATION FOR A PROPOSED TIMBER WALL WOULD PRESENT INORDINATELY DIFFICULT PROBLEMS FOR JUTURE REPAIR OR REPLACEMENT.
- WALLS THAT ARE VISIBLE FROM BEYOND THE PROPERTY LINES OR FROM PUBLIC AREAS SHALL HAVE THE VISUAL IMPACT MITIGATED AS REQUIRED BY THE AGENCY ANDOR THE COMMUNITY DEVELOPMENT AGENCY INCLUDING, BUT NOT LIMITED TO, SURFACE TEXTURING, OCIORING AND LANGESCAPING.

GRADING FILL/CUTS

- CUT AND FILL SLOPES SHALL NOT BE STEEPER THAN IS SAFE FOR THE SUBJECT MATERIAL OR NECESSARY FOR THE INTENDED USE AND IN NO
- I. CUIT AND FILE SHOPES SHAEL, NOT BE STEEPER THAN SIS WEFF FOR THE SHORT WITH THE MEDICAL OR NECESSARY FOR THE NITEMBED USE AND INNO CLASS STEEPER THAN TOTO DO SE WITHOUT PROOF WRITETY APPROVAL FROM THE AGENCY SUCK PROPOSED, SAUL BE CONSIDERED ONLY.

 WHICH SUPPORTED BY APPROPRIATE DECOMENSATION PROPARED BY A REGISTERIO CVIL EXMERCE DEPERDACIO. BY GOTTO-MICH.

 PELL SLOWES SHALL NOT BE CONSTRUCTION OF MATURES, A DEPOS STEEPER THAN THO ON OR AD ON WHERE THE FILE SLOPE TOES OUT WITHIN THOSE FEET PROPERTY OF THE OWNER OF THE STEEPER THAN THOSE OF THE THE FILE SLOPE TOES OUT WITHIN THOSE FEET PROPERTY OF THE OWNER OF THE STEEPER THAN THOSE OF THE THE FILE SLOPE TOES OUT WITHIN THOSE FEET THE SHAPE OF THE STEEPER THAN THE STEEPER THE FILE SLOPE TOES OUT WITHIN THOSE OF THE STEEPER THAN THE STEEPER THAN THE STEEPER THE STEEPER THAN THE STEEPER THAN THE SECURITY OF THE THE STEEPER THAN THE SECURITY OF THE AGENCY, HIS BEEN SUBMITTED THAT THE REQUIRED ELEVATION HAS BEEN ONTAINED AND THAT THE FILL WILL PROVIDE A STABLE BASE FOR THE CONSTRUCTION PROPOSED.

PERMANENT STORMWATER CONTROLS FOR NEW AND REDEVELOPMENT.

THE AGENCY MAY REQUIRE, AS A CONDITION OF PROJECT APPROVAL, PERMANENT CONTROLS DESIGNED TO REMOVE EXEMBENT AND OTHER POLICITIES, AND TO MINE THE REPROJECT SITE HYDROLCOUNT OF CONTROLLING THE FLOW WAITES AND OTHER CONTROLLING OF STORMANDER SHAPE PROPERTY. AND THE PROPERTY OF THE PROPERT

- CONSTRUCTION MANUAL.

 THE SEPCICIP CONTICTOR MANUAL.

 THE SEPCICIP CONTICTOR PROPOSED IN THE SCP SHALL BE SUBJECT TO THE REVIEW AND APPROVAL OF THE AGENCY AND SHALL BE IN GENERAL ACCORDANCE With the BASSAN POST CONSTRUCTION MANUAL, AND THE PHASE IS TORNINATED PRIMAT.

 GENERAL ACCORDANCE WITH THE BASSAN POST CONSTRUCTION AND ADMINISTRATION ADMINISTRATION AND ADMINISTRATION ADMINISTRATION AND ADMINISTRATION AND
- IS REQUISED FROM TO PIAN, ASSISTION AND APPROVAD OF SILLING PERMIT COURSE.

 ALL STOOMARTS WANDERGOOT FACILIES SHALL SEE MAINTAINED ACCORDING TO THE APPROVED OM FLAN. THE PRISONESS OR ALL STOOMARTS WAS AND ADMINISTRATION OF THE PRISONESS OR AND ADMINISTRATION OF THE PRISONESS OF THE PLAN THE

- ARRESPITA RECORDED COMMANTS OF LOCALIZATION SHALL SEPROMED BY THE PROPERTY OWNER.

 ALL PROJECT PROPENTS AND THEIR SUCCESSION, OR SUCCESSIONS AS THE TITLE, OR COUNT, OR A PROJECT THAT IS LOCATED WITHIN A COUNTY INSTANCED, AREA AND THAT IS GETWIND AS A REQULATED PROJECT IN SECTION 6.12 C.O. THE PRIVATE STORMARTER PRIVATE AND A CONCINTOR PROJECT IN SECTION 6.12 C.O. THE PRIVATE STORMARTER PRIVATE AND A COUNTY OF THE PROPERTY OF THE PRIVATE AND APPRIVAT, OF BUTTOM PRIVATE OR STORMARTER PRIVATE AND A COUNTY OF THE PRIVATE OR APPRIVATE OF THE STORMARTER WAS AND MANTENANCE OF THE STORMARTER WAS AND AND ADMITTANCE OF THE STORMARTER WAS AND AND ADMITTANCE OF THE STORMARTER WAS AND ADMITTANCE OF THE STORMARTER WAS AND ADMITTANCE OF THE STORMARTER WAS ADMITTANCE. THE OPERATION AND MAINTENANCE OF THE STORMWATER MANAGEMENT FACILITIES UNTIL SUCH RESPONSIBILITY IS LEGALLY
- TRANSPERROD TO ADMIT SEPTION.

 A MY OTHER LOCALLY DEPORCEME AGREEMENT OR MECHANISM, SUCH AS RECORDATION IN THE PROPERTY DEED, THAT ASSONS THE OFFENTION AND IMMEDIATE OF THE STORMANTER IMMODITION IN THE PROPERTY OF THE OFFENTIAL SECRET WAY HE REQUIRED TO SHAPE THAT STORMANTER IMMODITION FOR A PROPERTY FOLLOWS OF THE OFFENTIAL SECRET SHAPE AS A PERSON WHICH HAVE A PERSON HIGH HAVE DESIGNED BY THE AGENCY. FRANCIAL SECRETY SHALL CONSIST OF AN APPROCADABLE THEFT OF THE AGENCY.

DRAINAGE AND TERRACING

UNLESS OTHERWISE INDICATED ON THE APPROVED GRADING PLANS, DRAINAGE FACILITIES AND TERRACING SHALL CONFORM TO THE FOLLOWING

- PROVISIONS:

 1. TERMACES AT LEAST SIX FEET IN WOTH SHALL BE ESTABLISHED AT NOT MORE THAN THRITY-FOOT VERTICAL INTERVALS TO CONTROL.

 SIXWACD DAMAGE AND DEBRIS SUTFACE ACCESS SHALL BE PROVIDED TO PREMIT PROPRIED CARRIED AND MAINTENANCE.

 OR SIXWACD WITH AN PROVIDED WHITE TO PREMIT PROGRESS OF THE ACCESS OF THE
- 4. DRAINAGE COLLECTION SYSTEMS SHALL DISCHARGE WATER IN AN AREA OF STABLE SCIL, AN IMPROVED ROADSIDE DITCH, OR A NATURAL OR

SHEET INDEX

| SECTIONS & DETAILS C.3 EROSION CONTROL PLAN C.4 | | |
|---|--|--|
|---|--|--|

EARTH WORK QUANTITY

| CUT FILL IMPORT EXPORT | 75 50 0 25 | C.Y. C.Y. C.Y. |
|---------------------------------|---------------------|----------------------|
| LOT SIZE: | 10000 | SQ-F |

NOTE: QUANTITIES SHOWN HERE ON ARE FOR PERMIT AND/OR BONDING PURPOSE ONLY.

OWNER

YURI GALEEV ADDRESS: 111 OAK AVE, KENTFIELD, CA 94904 PHONE: (408) 809-1210 EMAIL: yun@constructo.online

ARCHITECTURAL DESIGNER

CONSTRUCTO INC. ADDRESS: 910 CAMPISI WAY, STE 2C, CAMPBELL, CA 95008 PHONE: (800) 970-1766 EMAIL: welcome@constructo.online

STRUCTURAL ENGINEERING

ADDRESS: 8890 Commerce Blvd. Suite 105, Rohnert Park, CA 94928 PHONE: (707) 578-8185 WEBSITE: www.mkmassociates.com

PROFESSIONAL ENGINEER

NAME: LEI ZHENG

SURVEYOR

VERTICOM LAND SURVEYING ADDRESS: 1104 CORPORATE WAY, SUITE 238, SACRAMENTO, CA 95831



VICINITY MAP



DURING CONSTRUCTION IF ANY DIFFICULTY OCCUR. PLEASE CONTACT ENGINEER IMMEDIATELY JF CONTRACTOR DEVIATE FROM THE DRAWING WITHOUT PRIOR APPROVAL FROM ENGINEER THE CONTRACTOR WILL TAKE ALL THE LIABILITY DUE TO DEVIATION

> Kentfield 904 Ave, 94 Oak


| REV. | DESCRIPTION | DATE |
|------|-------------------|------------|
| 0 | APPLY FOR PERMITS | 04/12/2023 |
| 1 | 1ST PLAN CHECK | 07/11/2023 |
| | | |
| | | |
| | | |



SHEET TITLE:

TITLE SHEET

C-1

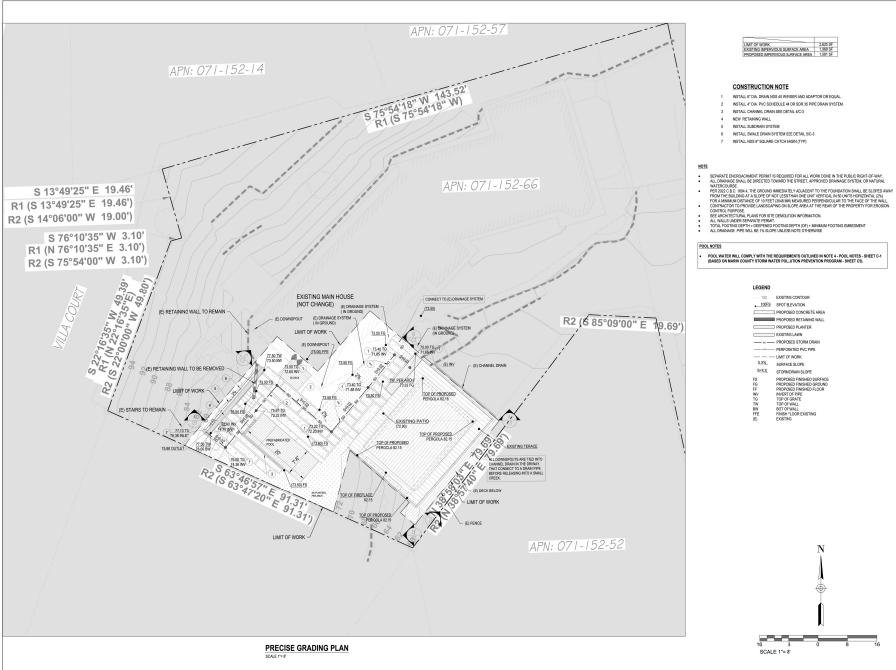



DURING CONSTRUCTION IF ANY DIFFICULTY OCCUR, PLEASE CONTACT ENSINEER IMMEDIATELY IF CONTRACTOR DEVIATE FROM THE DRAWING WITHOUT PRIOR APPROVAL FROM ENGINEER, THE CONTRACTOR WILL TAKE ALL THE LIABILITY DUE TO DEVIATION.


Oak Ave, Kentfield, CA 94904

| REV. | DESCRIPTION | DATE |
|--------|-------------------|------------|
| 0 | APPLY FOR PERMITS | 04/12/2023 |
| 1 | 1ST PLAN CHECK | 07/11/2023 |
| | | |
| | | |
| \Box | | |




PRECISE GRADING & DRAINAGE PLAN


C-2

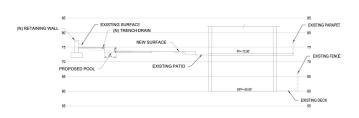


SECTION A-A SCALE : 1" = 10"

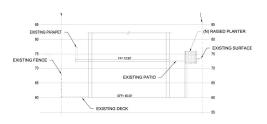


SECTION B-B SCALE : 1" = 10"

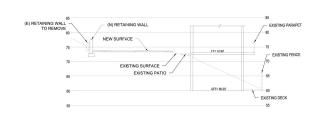


SECTION C-C SCALE : 1" = 10"

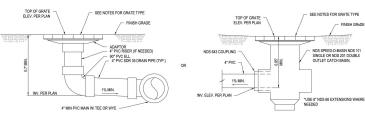


- NOTE:
 1. ALL FITTINGS 89': NDS, NC. (OR EQUAL) PHONE:
 1. ALL FITTINGS 89': NDS, NC. (OR EQUAL) PHONE:
 1. 400.726-1984
 2. REFERT OF GRADING PLAN FOR FINISH GRADING.
 3. DO NOT GLUE GRATE OR RISEST FOR PIEC.
 4. GLUE "1.P.S. WELD ON" #773 SOLVENT (MEDIUM BOOIED FAST SET) FOR PIEC THRU 6" 80.
 5. ALL PIPES TO BE 4" 8" PVC SDR 35 OR SCHEDULE 40.

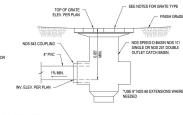


DETAIL 1

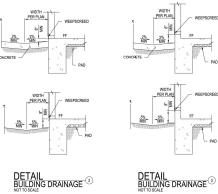


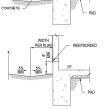



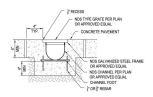



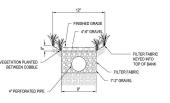





DURING CONSTRUCTION IF ANY DIFFICULTY OCCUR, PLEASE CONTACT ENGINEER IMMEDIATELY. IF CONTRACTOR DEVIATE FROM THE DRAWING WITHOUT PRIOR APPROVAL FROM ENGINEER, THE CONTRACTOR WILL TAKE ALL THE LIABILITY DUE TO DEVIATION.


111 Oak Ave, Kentfield, CA 94904

| REV. | DESCRIPTION | DATE |
|------|-------------------|------------|
| 0 | APPLY FOR PERMITS | 04/12/2023 |
| 1 | 1ST PLAN CHECK | 07/11/2023 |
| | | |
| | | |
| | | |




SECTIONS AND DETAILS


SHEET NUMBER: C-3

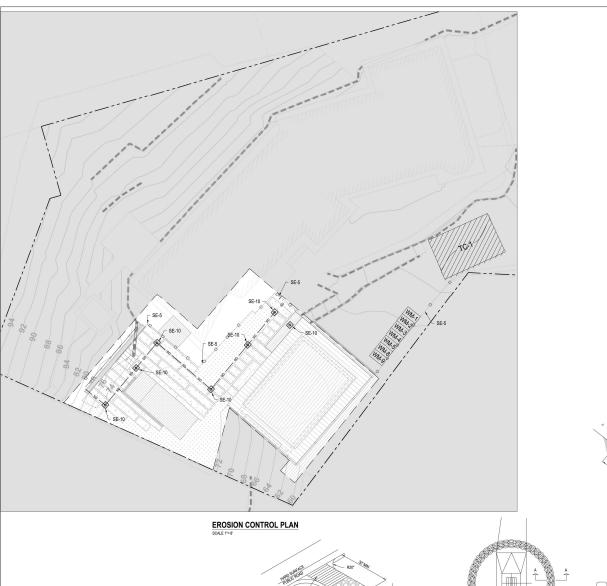


6" THICK }" AGGREGATE BASE


DETAIL STABILIZED CONSTRUCTION ENTRANCE

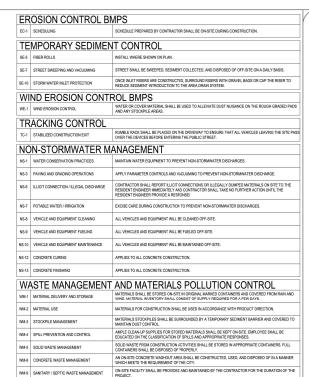

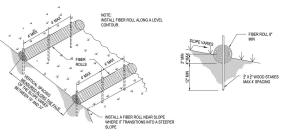

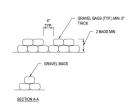

DETAIL GRAVEL BAG FOR INLETS

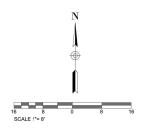



DURING CONSTRUCTION IF ANY DIFFICULTY OCCUR, PLEASE CONTACT ENSINEER IMMEDIATELY .IF CONTRACTOR DEVIATE FROM THE DRAWING WITHOUT PRIOR APPROVAL FROM ENGINEER, THE CONTRACTOR WILL TAKE ALL THE LIABILIT' DUE TO DEVIATION.

111 Oak Ave, Kentfield, CA 94904

| REV. | DESCRIPTION | DATE |
|------|-------------------|------------|
| 0 | APPLY FOR PERMITS | 04/12/2023 |
| 1 | 1ST PLAN CHECK | 07/11/2023 |
| | | |
| | | |
| | | |



EROSION CONTROL PLAN

C-4

Best Management Practices

Follow the maintenance practices listed below to help keep pollutants out of our waterways, protect water in our creeks and comply with local, state, and federal laws.

Note: For information on commercial swimming pool facilities, contact the Marin County Department of Environmental Health Services at 415-473-6907.

Disposing of Swimming Pool, Spa, or Fountain Water

It is illegal to discharge water from pools, spas and fountains - including filter rinsewater

- Saltwater pools cannot be discharged to a sanitary sewer system or a storm drain!
- The preferred method is to discharge pool, spa, or fountain water (other than salt water) onto land surfaces provided the water is dechlorinated/debrominated, the pH is between 6.5 and 8.5, <u>and</u> the land area is sufficient to prevent erosion and runoff into a ditch, creek, or other stormwater conveyance.
- If landscaping is not a viable option, the next best choice is to discharge pool, spa, or fountain water to the sanitary system. Contact your local sanitary sewer agency to make sure the discharge will not create a problem in the sewer system or wastewater treatment plant downstream of your property.

As a last resort, discharge to a storm drain only if:

- no other disposal methods (e.g. sanitary sewer, landscaping) are possible.
- the pool, spa, or fountain water is completely dechlorinated/debrominated.
- concentrations of copper and silver are not harmful to fish or other aquatic life.
- the pH is between 6.5 and 8.5.
- the water is free of any unusual coloration, dirt, suds, or algae.
- there is no discharge of filter media.
- there is no discharge of acid cleaning wastes
- the water is at ambient temperature. (Heated water should be allowed to cool.)

 Backwash sand and diatomaceous earth filters onto a dirt or rocked area.
 Keep backwash discharges out of the street

Rinsewater and Backwash

Rinse cartridge filters onto a dirt area and

spade the filter residue into the soil.

Disposing of Filter

- Reep backwash discharges out of the street and storm drain. Temporary wash areas must be adequate to contain all washwaters. The temporary wash area is inadequate if washwater reaches creeks, gutters, or storm drains.
- If you do not have a suitable dirt area, contact your wastewater treatment authority listed on the back of this brochure for instructions on discharging to the sanitary sewer. Pretreatment may be required to remove the diatomaceous earth from the backwash water and prevent blockages to your sewer line.

General Maintenance Tips

- Clean your pool, fountain, or spa regularly, maintain proper chlorine levels, water filtration and circulation. If you do so, you will not have to drain your pool so often.
- Manage pH and water hardness to reduce copper pipe corrosion that can stain your pool and end up in our creeks.
- Avoid using copper algaecides. Ask your pool maintenance service or store for help resolving persistent algae problems without using copper algaecides.
- Make sure your pool maintenance service follows all discharge requirements.
- Dispose of unwanted pool chemicals properly. Many are hazardous wastes when discarded. Household hazardous wastes may be legally disposed of at a Hazardous Waste Collection Facility for free. In Novato, call 892-7344. Other areas of Marin call 485-6806.

Commercial operations, including maintenance companies, may dispose of hazardous pool chemicals for a fee through the Conditionally Exempt Small Quantity Generator Program. For an appointment, call the Hazardous Waste Collection Facility at 892-6395 (Novato only) or 485-5648 (for other areas of Marin).



DURING CONSTRUCTION IF ANY DIFFICULT

11 Oak Ave, Kentfield CA 94904

| REV. | DESCRIPTION | DATE |
|------|-------------------|------------|
| 0 | APPLY FOR PERMITS | 04/12/2023 |
| 1 | 1ST PLAN CHECK | 07/11/2023 |
| | | |
| | | |
| | | |

Jurisdiction



SHEET TITLE

BEST MANAGEMENT PRACTICES

SHEET NUMBER:

C-5



GENERAL

1. All act, to be in conformance with the 2018 Collonian Beoderside

1. All act, to be in conformance with the 2018 Collonian Beoderside

1. All act, to be in conformation Billiang Dode (CRIC) an obtained by

the local generaling agency, and any opticiable local devaluations.

2. the Contractor, any discrepancies that require destination or

relations to be torought to the destination of the Architect-Propierar

2. Contractor to provide the requirements of all structural details collected

3. Contractor to provide the requirements of all structural details control and the contractor of the

toted. The contract structural drawings and specifications represent the initiated structure, and, except where specifically shown, do not ndicate the method or means of construction. The Contractor to supervise and direct the work and to be solely responsible for all construction means, methods, procedures, techniques, safety and

5100-CRC 2201445N1 01/01/20 DESIGN CRITERIA

VERTICAL LOADS
A. Roof Live Load = 20 psf (May be reduced for slope and tributory area)

EXISTING CONSTRUCTION

The structural review provided by MKM & Associates is for the addition and partitions of the existing building that have been structurally medified only. A complete review/retrofit of the existing structure is beyond the scope of services provided by MKM &

or ore subject to changes due to time, environment or modification by others.

Support of the control of the co

construction.

Any removal or demolition of existing construction required to execute the work shown in these drawings to be the responsibility of the Contractor and to be restored to its original or better condition.

5102 220144941 1/1/17

1. Sinclutural conformance letters indeciting general conformance to the Associates it formation and the Conformance to the Associates it formation and the Conformation and the

FOUNDATIONS/SITE WORK

FOUNDATIONS/SIE WORK

All sile work, disorings systems, foundations and other soil considerations to conform to the recommendations of the considerations to conform to the recommendations of the property of the conformation of the conform

CONCRETE & REINFORCEMENT

Concrete to meet the following requirements:
 28-Day
 Strength Slump MSA W/CM Admixtures

FOUNDATIONS 3000 psi 4"±1" 1-1/2" 0.55 N/A

TOURDATIONS 3000 psi 4"a" 1" 1-1/2" 0.55 N/A

2. Protition centre in conform to SNITU 1150, type 3.

3. All concrete to be semiped and tested by a qualified technical in accordance with AU 313-14, section 26.12, and the semiped centre of the section of the sect

Eliminate all air and stone pockets which may cause hotepromibing.

Illuminate and eliminate in the surprise receipt in a model.

A Expand surface of receipts to the surprise receipt in a model in a model concrete to be thoroughly settled an excessive to receipt the model occurrence to be thoroughly settled an excessive to mention.

B. For curing of concrete cost and finished field, cure by one of the following methods for a minimum of sever (17) days U.O.M. but a placed without marking the surface. Neep the burities of the surface of the s

ADHESIVE CONNECTIONS

Installation of adhesive, anchors and dowels to be in accordance with the manufacturer's specifications and these notes. Where requirements of the manufacturer or these notes conflict the more requirements and the more conflict the more power.
 Adhesive Systams
 A. The following adhesive anchor systems are acceptable for use in

concrete:
Hits: HF-200 (ICC-ES ESR 3187)
Hits: RE-500 x3 (CC-ES ESR 3814)
Simpson: SET-XP (ICC-ES ESR-358)
Simpson: SET-XP (ICC-ES ESR-358)
Simpson: SET-XP (ICC-ES ESR-358)
Dehkits: ItyelTi-14 (ICC-ES ESR-358)
B. The following otherwise enricher systems are acceptable for use in solid-grounded concrete managing units (If viola are encountered solid-grouted concrete majority units jur voids are encountered control. Enginee-1:-E. ISSR-4143)
Simpson: SET-AP (APMO-ES ER-265)
Deviola: ADIO-0-0-001 (ICC-2 ER-265)
Deviola: ADIO-0-0-001 (ICC-2 ER-265)
Any other adhesive to have documentation, outdoor just of the device and the second proposed prior to drilling
SE Report, southful to the Engineer for approval prior to drilling

CS deports, additionable on the congress of supporting the control of the control

extension nazzle

B. Clean hole surfaces with a plastic wire battle brush which is slightly larger than the hole diameter.

C. Blow out his with compressed oid?

D. Repeat procedure as required until all surfaces are clean and no residual dust remains an surfaces of hole.

Items embedded in adhesive to be clean and free of any rust, petroleum based products or deletrious materiolis per adhesive

5. Items embedded in adherive to be clean and free of any rast, perthalm build products of determination sentencing or chemical perthalmation of the product of determination sentencing or chemical and a sentencing of the product o

CARPENTRY

WATERAN AND A COMMENT OF THE A

3) Berims and posts 6s and larger (**J.A.L.**). **No.** it into Lumber to late on a maximum molature collects of 19% at time Lumber to late on a maximum molature collects of 19% at time Lumber to late of the collection of the

quelly mark to be on a storing of sweet wareness and a confirmation of the confirmation (e.g.).

It is allowed by the correlate integration agency the appropriate trademark of the American Physical Association and to confirm to the requirement for the Prince of the Confirmation of the Confirmation of the Confirmation of the American Physical Association and to confirm to the requirement for their type in DOC PS 1, the destricted for grade and give type by the trademarks of on approved leasting and grading species, in addition, possess when types, except that wood structural posel root shwatching exposed to the outdoors on the underside a permitted to the inferior of the confirmation of the confirm

drawing. Composite Lumber (SCL)

3. SCL from boards.

9. SCL from boards.

1. SCL so have the rollowing minimum properties:

1. SCL so have the rollowing minimum properties:

1. SCL so have the rollowing minimum properties:

1. SCL so have the rollowing so the solid sol

ASTENERS/CONNECTORS

Another Control of the Structural drawings.

APPENDER/COMPOSITION or sequirements of ASTM F1667. Noils used for froming and sheetings connections to low a used for froming and sheetings connections to low a class for share dismersiant longer than 0.172 inch but not 100 ks for share dismersiant longer than 0.172 inch but not 100 ks for share dismersiant longer than 0.172 inch but not 100 ks for share dismersiant longer than 0.172 inch but not 100 ks for share dismersiant longer than 0.172 inch but not 100 ks for share dismersiant longer than 0.172 inch but not 100 ks for share dismersiant longer from 0.172 inch but not 100 ks for share dismersiant longer for share dismersiant longer from 0.172 inch but not 100 ks for share dismersiant longer for share dismersiant longer for sh

CARPENTRY (CONTINUED)

4) TYPICAL NAIL SIZE LENGTH
8d common 2-1/2"
8d box 2-1/2" SHANK DIAMETER Bd common Bd box 10d common 10d box 16d common 16d box 16d sinker 20d common 20d box

Indisinter 3-1/4" 0.148*

20d common 4" 0.192"

30d common 4" 0.192"

30d common 4" 0.192"

30d common 618 may be substituted for box or

b. 16d sinters may be substituted for 10d common

b. 16d sinters may be substituted for 10d common

1.6d sinters may be substituted and sinters for 10d sinters for

5118-CRC 2201445N1 02/15/22

ASIANAM . All work to be in conformance with ASC "Specification for Structural Stell Buildings", lotest edition.

Stell Public Buildings and Stell Buil

All affactural veiling to be done in occordance with AMS D.1.1, lotted procedures for the veiling process and veiling proclets and veiling process and veiling proclets used.

All affacts are consistent to the process and veiling proclets used.

In all sate exposure to be glorisated or oppy primed and apony partial. All spoys point typied to be compatible with the process of the process of

EXCEPTION: Non-structural slob on groce.

Generally and the provided state of the s

DOCEPTION Non-structural slob-on-grade.

DOCEPTION Non-structural slob-on-grade.

DY Order's Testing Loborolary period continuous from the structural slob-on-grade continuous from the slob-

1. Contractor to submit along drawings and/or certifications to provide the contractor to submit along drawings and/or certifications for the tablewing place of ward.

1. Structural and minimizations satisfied and calculations submitted by the contractor of the co

CANT

COLL COMB CONC COND COND CONN CONST CONT CJP

Continuous Complete Joint Penetration Countersink

d Penny (Noil size)
DBL Double
DET Detail
D.F. Douglas Fir
DW or P Diameter
DWG Diameter
DWG Dimension
DL Dead Load
D.T. Dray Truss
DWG Drawing

Direction Drowling

(C) Existing

Ex

FDN Foundation FLR Floor FF EL Finish Floor

(1)^s

10'-6" WILL LENGTH

A BUILDING GRID SYSTEM

DETAIL REFERENCE (DETAIL NUMBER OVER SHEET NUMBER)

WALL ELEVATION REFERENCE
OR SECTION REFERENCE
(DETAIL NUMBER OVER
SHEET NUMBER)

SPELL NUMBERS | WARROUS KEYNOTE | SYMBOLS, SIE | KEYNOTE LEGENO | STANKE SHEET |

STRAP/TIEDOWN SZŁ
ST DETAL REPERENCE
SZE OF POST BELOW
WHERE APPLES

POST WITH HOLDOWN
(PLAN VIEW)

POST ABOVE WITH STRAP
(PLAN VIEW)

WOOD MEMBER (CONTINUOUS)

WOOD MEMBER (BLOCKING)

STRUCTURAL STEEL
PER PLAN

MALL LENGTH

-DVERALL WALL LENGTH

MAY BE CREATER SALL

SHEATHED WALL ABOVE,

SEE OTHER PLANS

SPECIAL INSPECTION

A CRUENAL CONTROLLING

A CREATER AND A CREAT

irrequiorities or deficiencies ore uncorrected, the Special Inspector programs, and the second programs are second programs are second programs.

Grading, Drainage, Excavation, and Fill By: RGH Consultants

ite. TION: Non-structural slab-on-grade.

PHSMS Pan Head Sheet Metal Screw PARL Porollel PERP Perpendicular P.D.F. Powder Driven Fastener PERF Perforated Pinte ABBREVIATIONS

L or L Angle
AB Anchor Bolt(s)
AB Anchor Bolt(s)
AB Apphaltic
AC Apphaltic
AC Concrete
AC Concrete
AC Concrete
AC Concrete
AC Concrete L or L Angle
At Anchor Bott(s)
ABN Above
AC Asphottic
Concrete
ADDL Additional
ADJ Adjacent
AFF Above Finish
AUT Alternate
APA American
Plywood
Association
Association F.O.P. Face of Post F.O.S. Face of Stud F.O.H.C. Free of Heart Center
FRMG Framing
F.S. Far-Side
FT Foot / Feet
FTG Footing APRX ASTM

Portal Sont
Particular Sont
P.S.F. Pounds Pot
P.S.F. Pounds Pot
P.S.F. Pounds Por
Source Inch
P.S.F. Pounds Por
Source Foot
P.T. Presurvative Treated
P.T.D.F. Presurvative Treated
P.T.D.F. Post-Tension(ed) (ing)
(#) Quantity
P.T. Post-Tension(ed) (ing) A.T.R. All—Threaded Rod AYC Alaska Yellow Cedar Quantity (Number of items) BFF Below Finish
Filoor
BLDG Building
BLK Block(ing)
BLW Below
BM Beom
B.N. Boundary Nail
BOT Bottom
BRG Bearing
BTWN Between GTP BID Gypaum Boord
H.D.G. Hot-Dipped
Golvanized
HDR Header
HORKZ
HORKZ
HORKZ
HORKZ
HSH Hollow
Structural
Section (Tube)
HT Height

S.A.D. See Architectural Drawings S.C.D. See Civil Drawing S.M.D. See Mechanical SCHED See Mechanical Drawings SCHED Schedule S.S.D. See Structural Drawings SCL Structural Composite Lumber

(See CARPENTRY Notes) | For | Incident | For | Incident | Incident

N.1.S. Rict to Scole

O/ Over (Cn)

On Center

OF Condest

OF Coldest

OF Cold

SYMBOLS LEGEND (SOME SYMBOLS MAY NOT BE APPLICABLE TO PROJECT) +B'-1" ELEVATION ABOVE 0'-0" WHOR BARRIER OVER FREE-DRAINING CRUSHED ROCK OVER UNDSTURBED OR NATIVE SOIL

COMPACTED SOIL METAL. WOOD SHEATHING FRAVING MEMBER WTH EDGE NAUNG REVISION AREA

REVISION NUMBER CONCRETE SLAB
CONSTRUCTION JOINT CONCRETE SLAB CONTROL JOINT CONDITION CONTINUES
BEYOND AREA DEPICTED POST-TEMSORIDE TENDON
STRESSING INIG
(TUNE-DAD')
POST-TEMSORIDE TENDON
(TEAD-END')
POST-TEMSORIDE TENDON
(TEAD-END')

* STEP DM/VSIONS
S.A.D. OR PER PLAN

PE: BR SR#: -220144

SN₁

structural engineering Internet:
www.mkmasociotes. 7/17/2023

MKM

GAssociates 4 contracts

PROJECT MANAGER STRUCTURAL OBSERVATION REQUIRED

 $\overline{\Box}$ \overline{S} Ш

OAK AVENUE RES

07-17-23 CC CC PLAN REVIEW ISSUE INFORMATION

Plot Date: 7/17/202 Sheet Title: STRUCTURAL

Checked by:

-(A) DS. 20 SD1 PER 5 - 11 В 1 2 FOUNDATION PLAN

FOUNDATION NOTES

5072 22014451 06-21-22

MKM «Associates seructural engineering

PROJECT MANAGER Cody Cruz

STRUCTURAL OBSERVATION REQUIRED SEE "STRUCTURAL OBSERVATION" NOTES ON SHEET SN1

OAK AVENUE RESIDENCE 1111 OAK AVENUE KENTFIELD, CALIFORNIA 94940


| ì | | | | | |
|---|--|--|--|--|--|
| Ī | | | | | |
| | | | | | |
| | | | | | |
| | 08.19.2022 CC CC Building Permit Application | | | | |
| | SUE INFORMATION | | | | |

| | ISSUE INFORMATION Designer: | | |
|---|------------------------------|--------|--|
| | | | |
| | PC: BR | SR#: | |
| 1 | Job: | 220144 | |
| | Checked by: | | |
| | Plot Date: 7/17/2023 | | |
| | Chest Title: | | |

Sheet Title:

FCUNDATION PLAN

S1

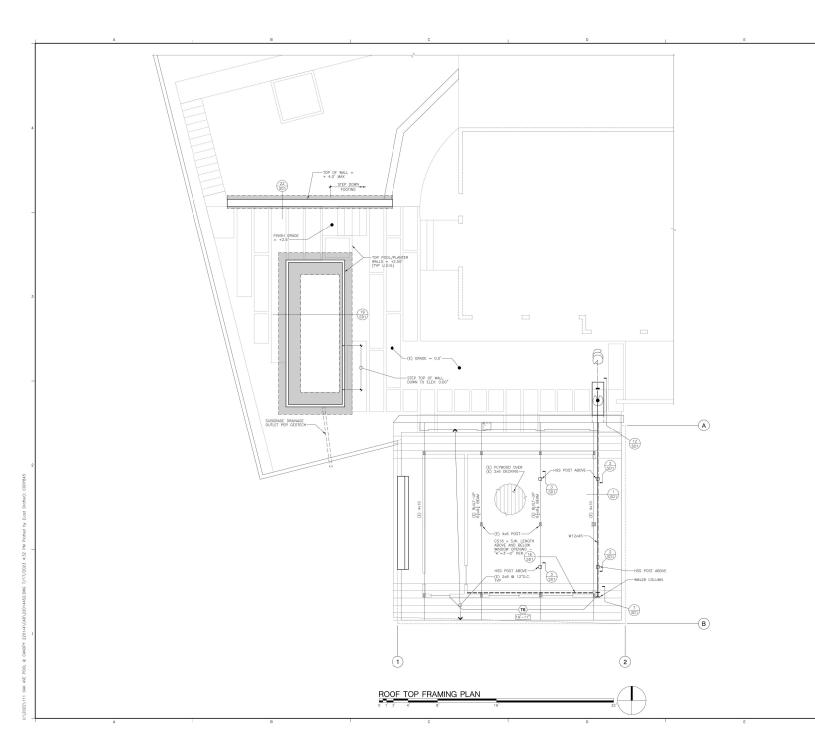

UPPER FLOOR FRAMING NOTES

- UPPER HOUR HAMING NOTES

 1. See "S0" sheek(s) for structure ordation of "S1" sheek(s) for structure ordation of the structure of the structu noil with 8d of e.g., surper-view marker node, Provide sheets not 1923 and "7". 8—0" except to boundaries and changes in fronting, Minimum sheet size to be 24" x 46" unless all edges of undersized sheets one supported by and festiment of forming of undersized sheets one supported by and festiment of forming of undersized sheets one supported by and festiment of forming of the section of the se

| WALL LEGEND | | | | |
|-------------|---|--|--|--|
| SYMBOL | DESCRIPTION | | | |
| | (E) WALL | | | |
| | (N) WALL | | | |
| | (N) OR (E) INTERIOR BEARING WALL* | | | |
| : | WALL ABOVE | | | |
| \vdash | CONCRETE STEM/GRADE BEAM/RETAINING WALL | | | |

MKM «Associates structural engineering



PROJECT MANAGER Cody Cruz

STRUCTURAL
OBSERVATION
REQUIRED
SEE "STRUCTURAL
OSSERVATION" NOTES
ON SHEET SN1

OAK AVENUE RESIDENCE III OAK AVENUE KENTFIELD, CALIFORNIA 94940


07-17-23 CC CC PLAN REVIEW ISSUE INFORMATION

PC: BR SR#: -

Plot Date: 7/17/2023

Sheet Title: ROOF TOP FRAMING PLAN

S2

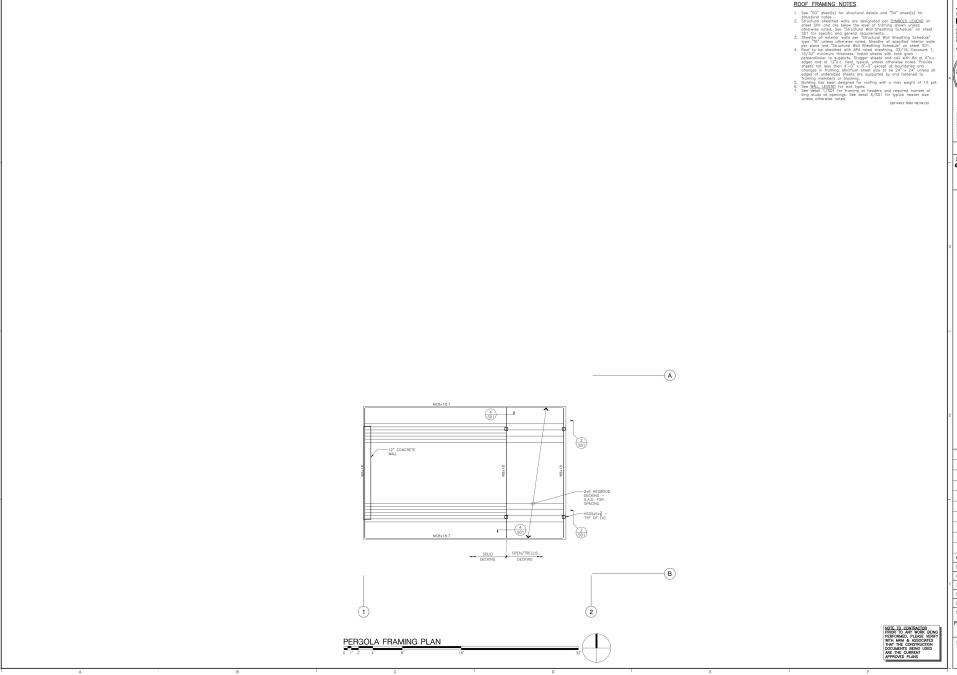

ROOF FRAMING NOTES

MKM CASSOCIATES STRUCTURAL ENGINEERING

T/TT/2028

-Copying to 2022 WM & Associate-This drawing is on instrument of service and in the sole property for service and in the sole property of a sole property of the sole property of drawing without written concert by Mark & Associated in probability accelerate the sole property accelerate the sole

STRUCTURAL
OBSERVATION
REQUIRED
SEE "STRUCTURAL
OBSERVATION" NOTES
ON SHEET SN1

OAK AVENUE RESIDENCE 1111 OAK AVENUE KENTFIELD, CALIFORNIA 94940

07-17-23 CC CC PLAN REVIEW ISSUE INFORMATION

PC: BR SR#: --Joo: 220144

Plot Date: 7/17/2023 Sheet Title:

PERGOLA FRAMING

S3

